

A





B

C

D

THE ROOF LIGHTS TO BE INSERTED IN THE FRONT ROOF SLOPE WILL NOT PROJECT MORE THAN 150MM BEYOND THE ROOF SLOPE

THE MATERIALS USED FOR THE REAR DORMER WILL MATCH THE MATERIALS ON THE HOST DWELLING

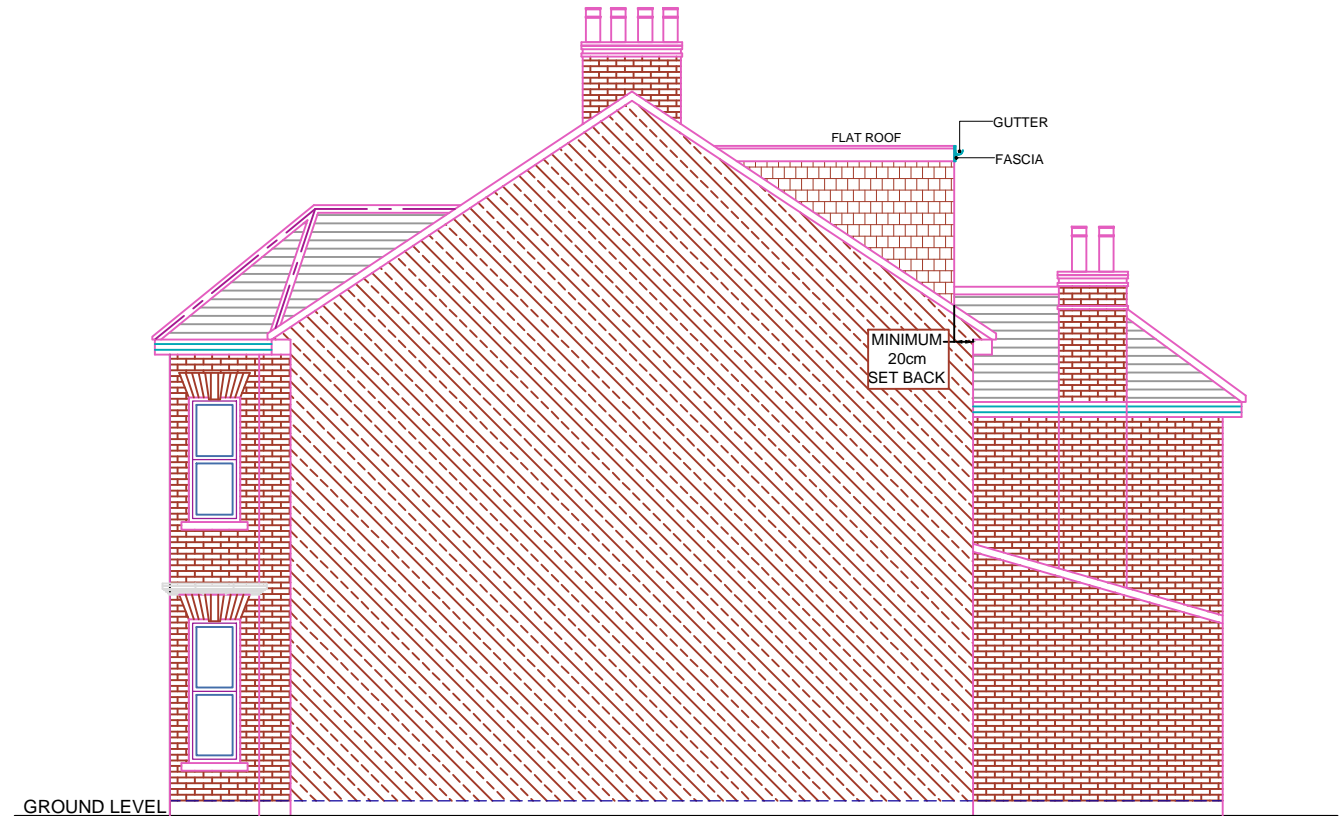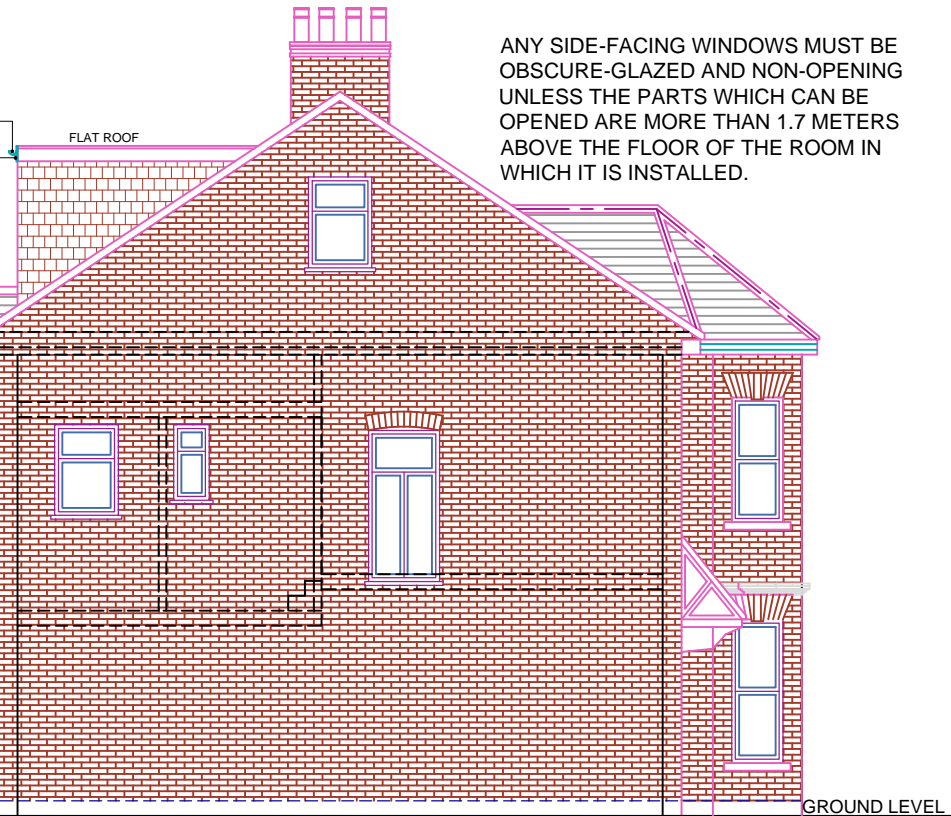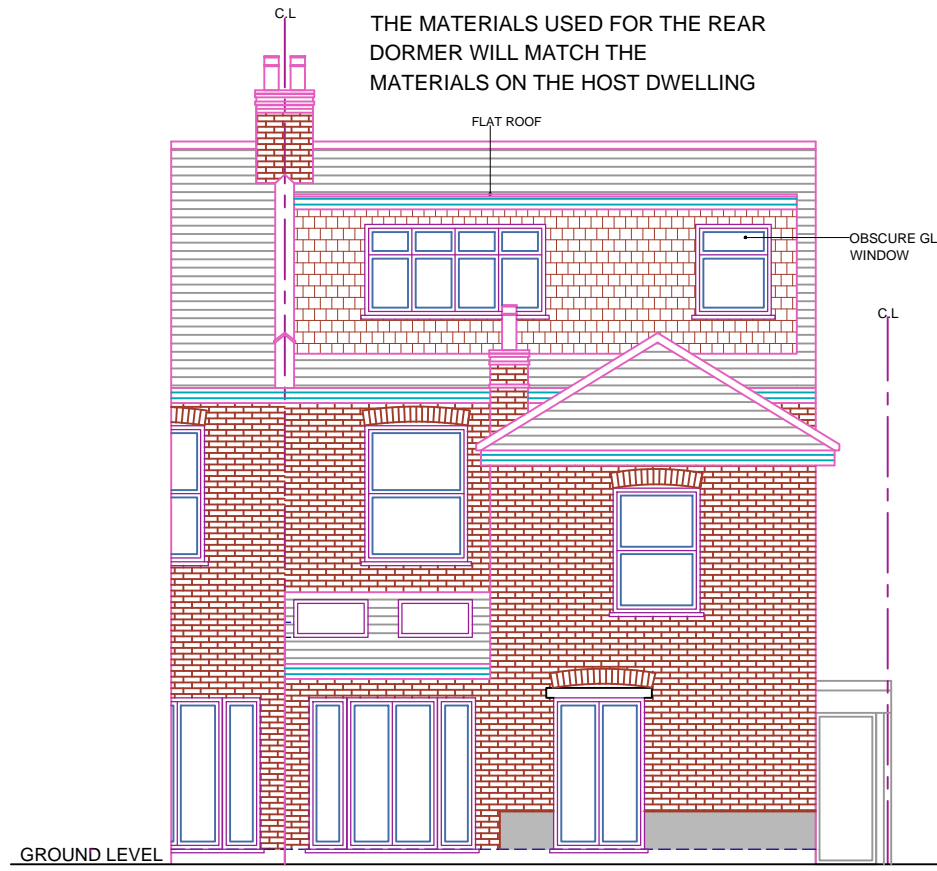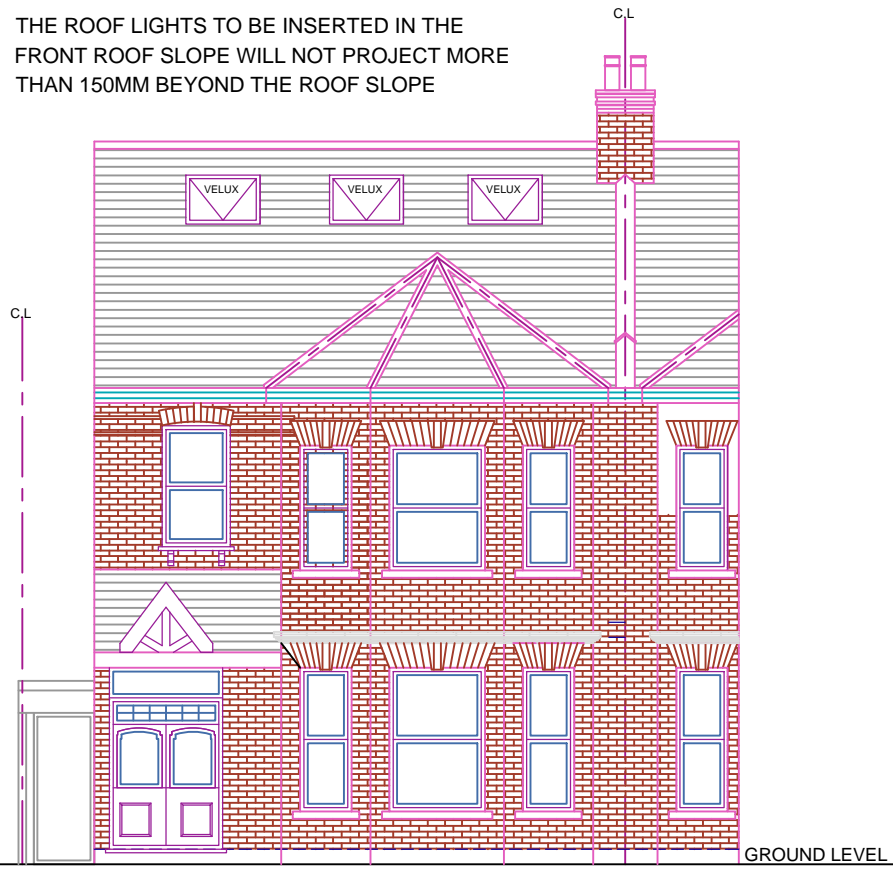

ANY SIDE-FACING WINDOWS MUST BE OBSCURE-GLAZED AND NON-OPENING UNLESS THE PARTS WHICH CAN BE OPENED ARE MORE THAN 1.7 METERS ABOVE THE FLOOR OF THE ROOM IN WHICH IT IS INSTALLED.

MINIMUM 20cm SET BACK



PROPOSED FRONT ELEVATION

PROPOSED REAR ELEVATION

PROPOSED ELEVATION SIDE A

PROPOSED ELEVATION SIDE B

REFERENCE DRAWINGS

GENERAL NOTES

This drawing is for planning use only do not use this drawing for any purpose other than that for which it was issued. Structural Design and Building Control Approval is required before construction commences. This drawing is subject to copyright do not reproduce this drawing without prior permission.

No	DATE	REVISION	BY	CHK

CONSULTANT

CIVIL ENGINEERS  
STRUCTURAL ENGINEERS  
ARCHITECTURAL DESIGNERS

**CIVIL CONSULTING LTD.**  
Contact: 07947249323

DRAWN AS  
CHECKED A.R  
PROJECT NO.

CLIENT/PROJECT  
**223b Fordwych Road  
LONDON NW2 3NH**

TITLE  
PROPOSED ELEVATIONS

DRAWING No.  
**D07 REV3**

SCALE: 1:100  
DATE: 15-02-2023

A

B

C

D