Piercy&Company

CAMDEN GODS YARD

BUILDING A TECHNICAL FACADE REPORT



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0.0.1 INTRODUCTION

This report contains technical analysis and comment on the post planning developed facade design of Building A at Camden Goods Yard. It includes the consented detailed facade drawings for reference together with analysis of the facade mockup panel and design changes introduced by delivery architects PTAL during RIBA Stage 4.



CONSENTED DETAILED PLANNING DRAWINGS

1.0.1 PLANNING FACADE

The detailed facade drawings contained in the consented planning application are listed below and included on the following pages for reference:

> CGYA0-PCY-ZZZ-ZZ-DR-AR-00160 Bay Drawings -Residential Bays

CGYA0-PCY-ZZZ-ZZ-DR-AR-00161 Bay Drawings -South West Elevation


CGYA0-PCY-ZZZ-ZZ-DR-AR-00162 Bay Drawings - Maker's Yard

CGYA0-PCY-ZZZ-ZZ-DR-AR-00163 Bay Drawings - Ground Floor Retail

CGYA0-PCY-ZZZ-ZZ-DR-AR-00164 Bay Drawings - Ground Floor Reception

The key materials noted on each of these drawings (and labelled left on the CGI included in the DAS) are

- 1. Exposed aggregate concrete columns, light-
- 2. Exposed aggregate window sill panels, dark-grey with white aggregate stone
- Dark grey concrete coping
 Dark grey textured rustic brick soldier coursing horizontal bands with 430mm soffit overhang to windows
- 5. Warm dark grey coloured metal window & door frames
- 6. Warm dark grey coloured metal horizontal louvres
- 7. Warm dark grey coloured metal flat bar ballustrades
- 8. Aluminium soffits, colour to match window frames

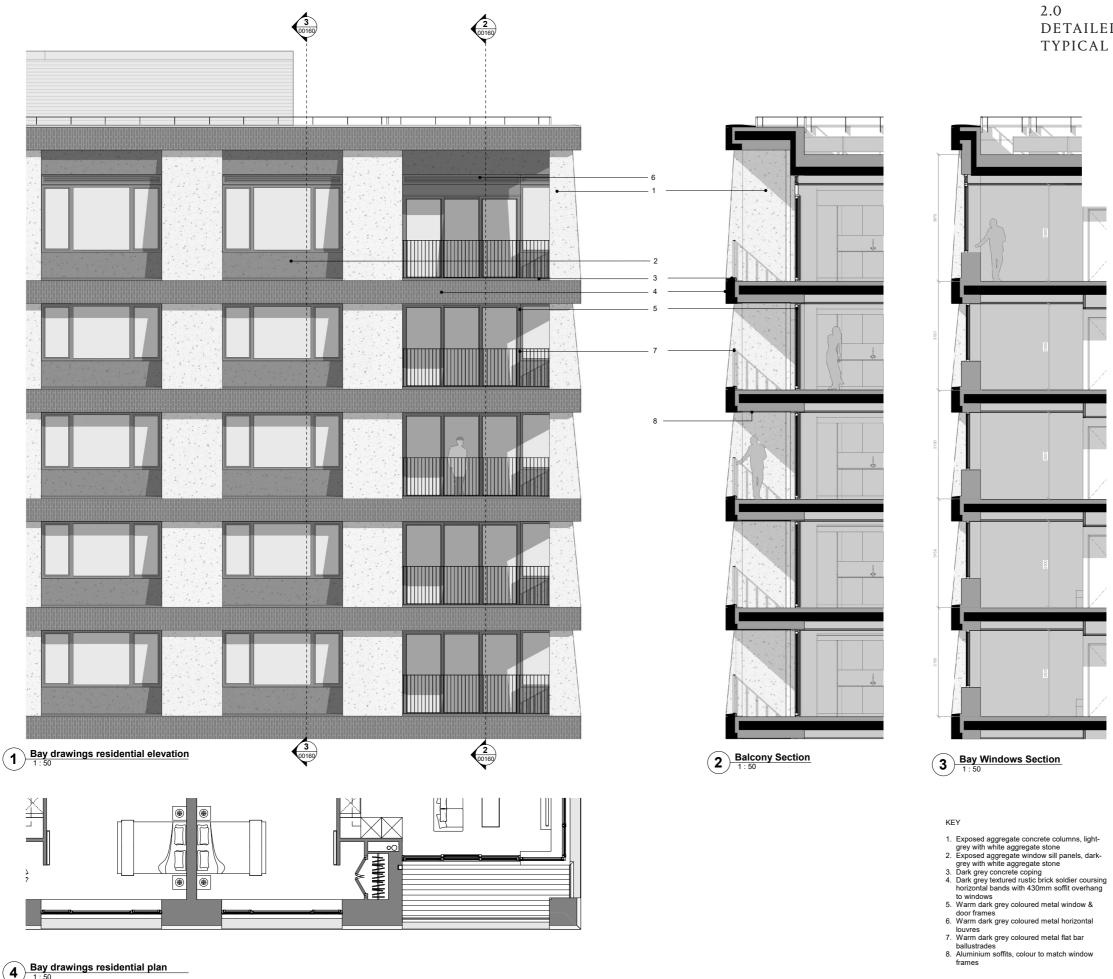

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CGYA0-PCY -ZZZ - ZZ - DR - AR - 00160 -P01

Drawn MS Checked AH Approved DC Drawing Status PLANNING Project Originator Zone Level Type Role Drg No. Rev

Drawing Title Bay Drawings - Residential Bays

Date of First Issue 03/07/20

Client 235 and a


Scale 1 : 50 at A1

CGYA0 Camden Goods Yard

P01 10.07.20 Planning Planning Description





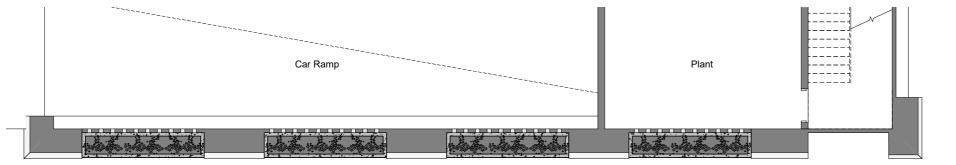

- KEY
 Exposed aggregate concrete columns, light-grey with white aggregate stone
 Exposed aggregate window sill panels, dark-grey with white aggregate stone
 Dark grey concrete coping
 Dark grey textured rustic brick soldier coursing horizontal bands with 430mm soffit overhang to windows
 Dark grey textured rustic brick hit & miss brickwork
 Warm dark grey coloured metal horizontal

- 6. Warm dark grey coloured metal horizontal

- Warm dark grey coloured metal horizontal lourres
 Warm dark grey coloured metal window & door frames
 Dark grey textured rustic brick Flemish bond
 Exposed aggregate concrete planters, mid-grey with white aggregate and varying degrees of texture

2 Car ramp south west plan

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Project Originator Zone Level Type Role Drg No. Rev CGYA0 - PCY - ZZZ - ZZ - DR - AR - 00161 - P01

Drawn MSr Checked AH Approved DC Drawing Status PLANNING

Drawing Title Bay Drawings -South West Elevation

Scale 1:50 at A1 /

Date of First Issue 03/07/20

Client

CGYA0 Camden Goods Yard


 P01
 10.07.20
 Planning

 Rev
 Date
 Description

2.1

3 Workshop unit shops plan

6

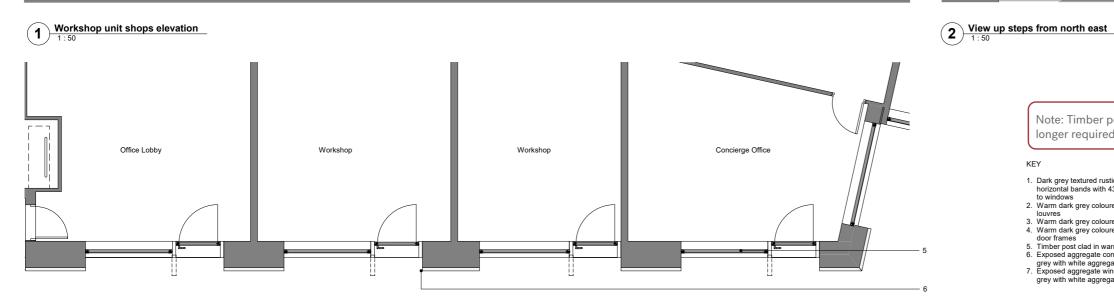




2.2

longer required

KEY

DETAILED FACADE PLANNING DRAWING: MAKERS YARD ELEVATION

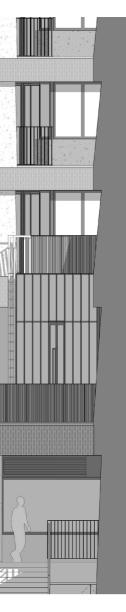



Dark grey textured rustic brick soldier coursing horizontal bands with 430mm soffit overhang to windows

to windows 2. Warm dark grey coloured metal horizontal lourves 3. Warm dark grey coloured metal signage panel 4. Warm dark grey coloured metal window & door frames 5. Timber post clad in warm dark grey metal 6. Exposed aggregate concrete columns, light-grey with white aggregate stone 7. Exposed aggregate window sill panels, dark-grey with white aggregate stone



CGYA0 Camden Goods Yard

Bay Drawings - Makers Yard

Checked AH

Client

Date of First Issue 03/07/20

Drawing Title

Drawn MS

Drawing Status

PLANNING

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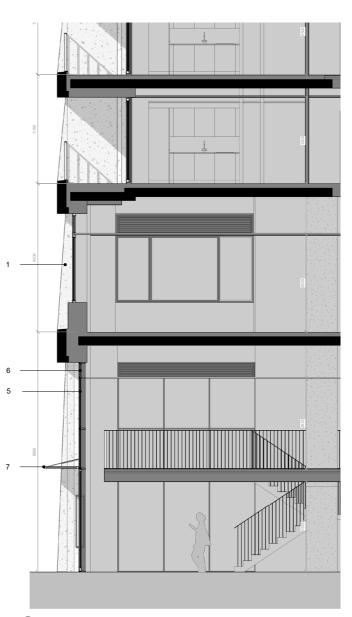
A Street

Scale 1:50 at A1 /

Approved DC

Project Originator Zone Level Type Role Drg No. Rev CGYA0 - PCY - ZZZ - ZZ - DR - AR - 00162 - P01





2 Retail Section

KEY

Note: Drainage design for glass canopies (7) to be confirmed at next stage

Exposed aggregate concrete columns, light-grey with white aggregate stone
 Exposed aggregate window sill panels, dark-grey with white aggregate stone
 Dark grey concrete coping
 Dark grey textured rustic brick soldier coursing horizontal bands with 430mm soffit overhang to windows
 Warm dark grey coloured metal window & door frames
 Warm dark grey coloured metal horizontal louvres
 Glass canopy above retail entry doors with warm dark grey coloured metal frame

DETAILED FACADE PLANNING DRAWING: **GROUND FLOOR RETAIL**

2.3



Project Originator Zone Level Type Role Drg No. Rev CGYA0 - PCY - ZZZ - ZZ - DR - AR - 00163 -P01 The Centro Building 39 Plender Street LONDON NW1 0DT Telephone +44 (0)207 4249611 info@piercyandco.com www.piercyandco.com


Date of First Issue 03/07/20 Scale 1:50 at A1 / Drawing Title Bay Drawings - Ground Floor Retail Drawn Author Checked Checker Approved Approver

Client

CGYA0 Camden Goods Yard



Drawing Status

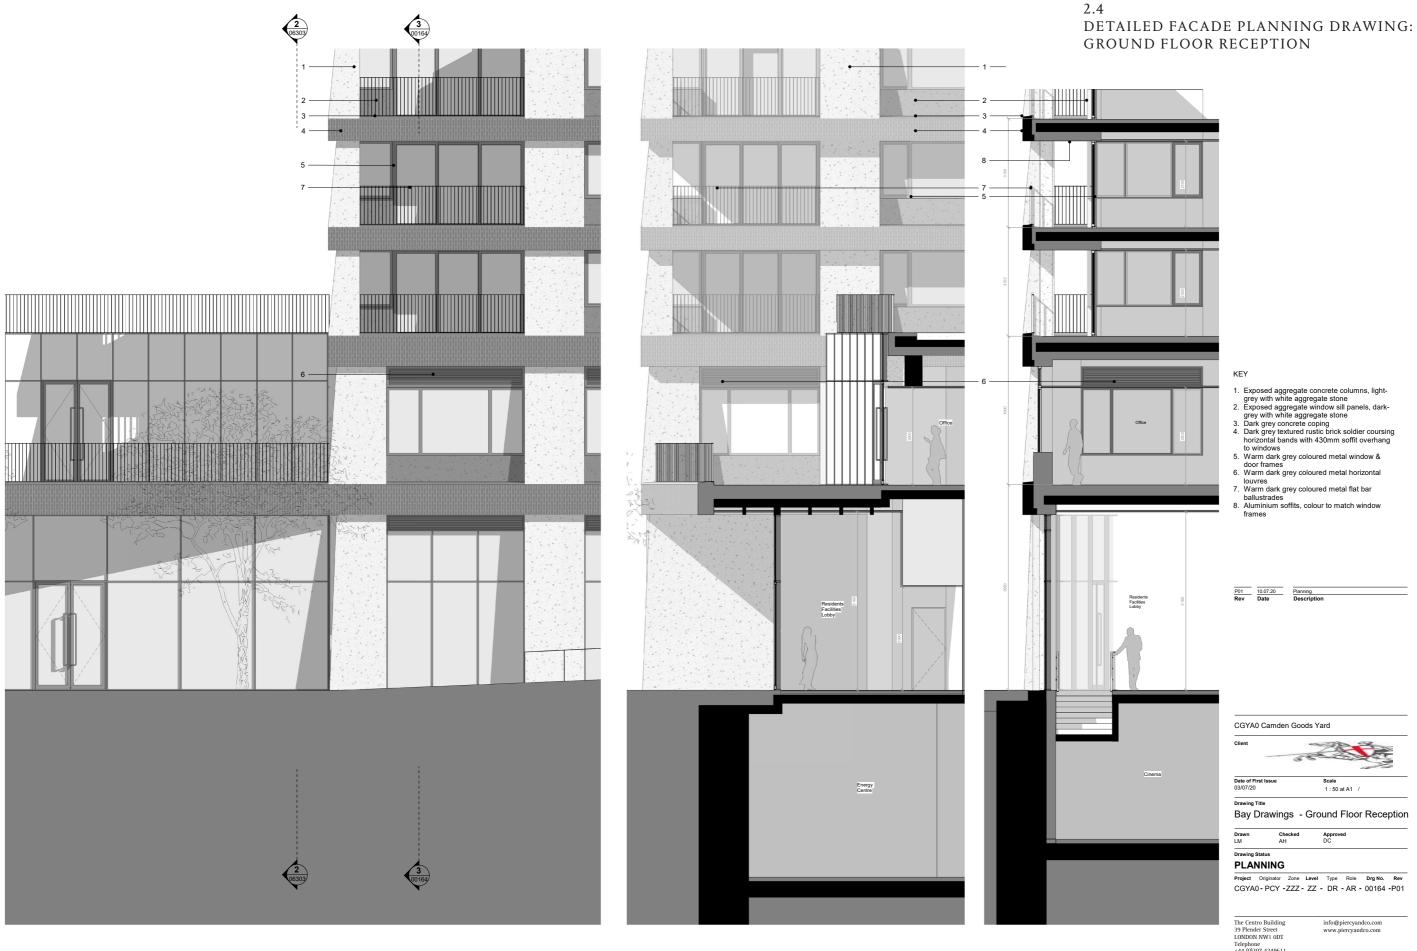

1 : 50

8



3 Section G-G 1:50

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Project Originator Zone Level Type Role Drg No. Rev CGYA0 - PCY - ZZZ - ZZ - DR - AR - 00164 - P01

Drawing Status PLANNING

Drawn LM

Checked AH Approved DC

Drawing Title Bay Drawings - Ground Floor Reception

Date of First Issu 03/07/20

Client É Scale 1:50 at A1 /

CGYA0 Camden Goods Yard

 P01
 10.07.20
 Planning

 Rev
 Date
 Description

Warm dark grey coloured metal horizontal louvres
 Warm dark grey coloured metal flat bar ballustrades
 Aluminium soffits, colour to match window frames



Residents Facilities Lobby

- Exposed aggregate concrete columns, light-grey with white aggregate stone
 Exposed aggregate window sill panels, dark-grey with white aggregate stone
 Dark grey concrete coping
 Dark grey textured rustic brick soldier coursing horizontal bands with 430mm soffit overhang to windows
 Warm dark grey coloured metal window & door frames
 Warm dark grey coloured metal horizontal louvres

- KEY





CONCRETE COLUMN

12mm Cornish Granite aggregate. Polished circa. 3-4mm. Light Grey Cement (blend of white and grey cements)

> 3.0.1 SAMPLE PANEL In late 2020 a sample panel (shown left) was developed and constructed to test the concrete and brick specification in relation to achieving the facade detailed in the planning drawings presented above. The dimensions of the panel are all as per the planning drawings.

3.0

The proposed specification of 12mm Cornish Granite aggregate and grey cement that is then polished to a depth of 3mm represents a good match to both the planning images and the description of these elements in the detailed planning drawings as 'Exposed aggregate concrete columns, light grey with white aggregate stone'.

WINDOW CILL (UPSTAND) PANELS & COPING

12mm Cornish Granite aggregate. Acid Etched Finish Dark Grey Cement (4% black pigment)

The upstand panels and coping pieces have the same 12mm Cornish Granite aggregate as the columns.

In the mock up panel concrete with a 4% black pigment was used. We consider this slightly too light in comparison to the planning information and recommend that a 5% black pigment is used for the final precast panels.

The overall aesthetic matches well to the "Exposed aggregate window sill panels, dark grey with white aggregate stone" referred to on the planning drawings.

13508-CAMDEN GOODS YARD BUILDING A

Piercy & Company's comments on the concrete finishes are as follows:

CONCRETE COLUMN

The Cornish Granite has a mixture of white and darker aggregate which we consider gives a good feel. The polished finish on the sloped face of the column is important to aid water runoff down this element and prevent staining.

CONCRETE UPSTAND & CILL

An acid etched finish was chosen to contrast with the lighter polished concrete columns and due to concerns over the practicality of polishing into the many internal corners of these elements.



RAL7022. - for windows, balustrades and soffits



Wienerberger Graphite black



BRICK OPTION 03:

MICHELMERSH BLACK SMOOTH Nominal Size: 215 x 102.5 x 65mm Manufactured: UK <u>Type:</u> Wirecut & vertically perforated <u>Dimensional tolerance</u>: Tolerance = T2 (+/-4mm for length, +/- 3mm for width, +/-2mm for height) Range: R2 (i.e. 4mm, 3mm, 2mm) Durability/Salt Classifications: F2/S2

BRICK OPTION 02: WIENERBERGER GRAPHITE BLACK

Nominal Size: 215x102.5x65mm Manufactured: Belgium <u>Type:</u> Soft mud moulded with frogging Dimensional tolerance: Tolerance = T1 (i.e. +/-6mm for length, +/- 4mm for width, +/-3mm for height) Range: R1 (i.e. 9mm, 6mm, 5mm) Durability/Salt Classifications: F2/S2

BRICK OPTION 01: HECHISCH ZWARTE (AGITA BLACK)

Nominal size: 215x102.5x65mm Manufactured: Belgium Type: Wirecut & vertically perforated <u>Dimensional tolerance</u>: Tolerance = T2 (+/-4mm for length, +/- 3mm for width, +/-2mm for height) Range: R2 (i.e. 4mm, 3mm, 2mm) Durability/Salt Classifications: F2/S2

Four samples were originally included on the mockup panel and one of these has since been discarded for cost and buildability reasons.

However, it is our understanding that Brick Option 01 is significantly over budget and that the client wishes to discard this as an option.

Brick Option 03: Michelmersh Black Smooth has a finish which is too smooth, shiny and consistent to be considered as 'rustic' or 'textured'.

The costs are noted left with the caveat that the brickwork bands form a relatively small part of the overall facade area.


The mortar should be raked joints and matched in colour to the chosen brick.

3.1.1 BRICKWORK OPTIONS

With regard to the brickwork the description on the detailed planning drawings reads "Dark grey textured rustic brick soldier coursing horizontal bands with 430mm soffit overhang to windows". The developed detail design has increased this to 470mm which in the context of previous discussions with the planners is a positive move.

Of the remaining three bricks we consider that Brick Option 01: Hechisch Zwarte (Agita Black) and Brick Option 02: Wienerberger Graphite Black represent a good match to the planning visuals and the 'Dark grey textured rustic' qualities described on the planning drawings.

Window frames and balustrades are to be a dark grey finish. We would suggest RAL7022.

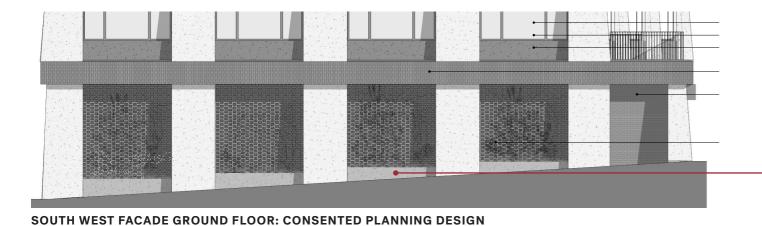

Planters adjacent to hit & miss brickwork with climbing plants. NB: Ground floor panel round the corner on South East facade is retained as a hit & miss brickwork panel.

Introduction of plantroom door with access stair

Planters on other side of pavement. Climbing plants replaced with planting

SOUTH WEST FACADE GROUND FLOOR: PROPOSED STAGE 4 DESIGN



SOUTH WEST FACADE GROUND FLOOR: PROPOSED STAGE 4 DESIGN

Planters on other side of pavement. Climbing plants replaced with planting


POST PLANNING DETAILED DEVELOPMENT CHANGES

SUMMARY


Section 3.2 summarises the minor facade design amendments made during the post planning Stage 4 design by delivery architects PTAL.

SOUTH WEST FACADE GROUND FLOOR


The concrete planters at the base of the facade have been moved away from the hit and miss brickwork and relocated on the edge of the pavement. This is considered a minor and acceptable change but does mean that the potential for plants to climb up the hit & miss brickwork is removed. The concrete planters are marked as being a 'mid-grey' tone in the planning drawings. We are suggesting that for consistency they should be specified to match the darker grey coping and under-window concrete panels on Building A. A more major change is the introduction of metal steps and a plantroom door in one of the bays. It is understood that the current external stair up to the first floor terrace may be removed. If this is the case we suggest that the steps and the door are relocated inside. If this is not possible the steps and door should be powder coated in a dark finish to match the Building A window frames.

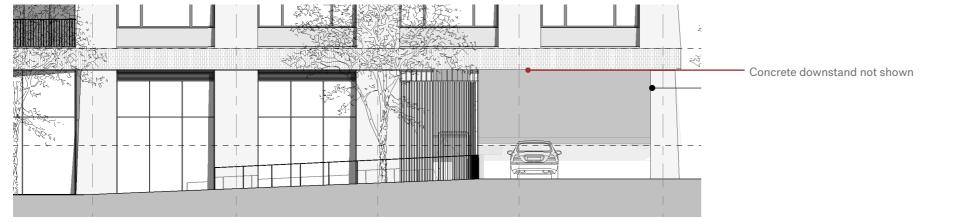


NORTH WEST FACADE GROUND FLOOR: CONSENTED PLANNING DESIGN

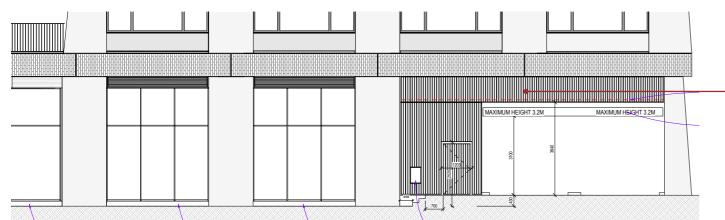

NORTH WEST FACADE GROUND FLOOR: PROPOSED STAGE 4 DESIGN

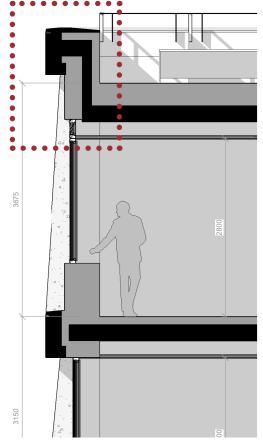



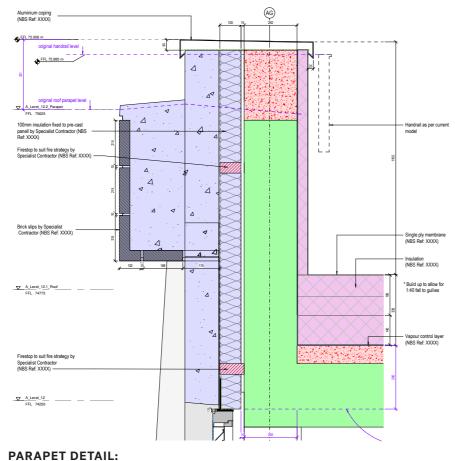

PROPOSED STAGE 4 DESIGN

Concrete downstand shown clad with metal fins

A small, set back concrete upstand has been introduced at roof level to create a better capping detail and simplify the balustrade design around the roof. The height of this new element is the same as the balustrade shown on the planning drawings. The set back means that this element will not be visible in the short views to the building and will not be prominent in the long views due to its relatively small size. An alternative detail to minimize the apparent height of the upstand would be to add a further brick (215mm) to the top brickwork band.

element.

SUMMARY

Section 3.2 summarises the minor facade design amendments made during the post planning Stage 4 design by delivery architects PTAL.

NORTH WEST FACADE GROUND FLOOR

The planning elevations did not show a downstand beam above the entrance to the car park ramp. This is required and PTAL are proposing that the metal gate steel uprights are continued up and over to form a screen to this exposed structural element. We consider this a minor change and a positive one that improves the elevation. 150mm upstands have been introduced under the large ground floor windows. This reduces the likelihood of leaks and the lower windows getting dirty and again is considered a minor and necessary update.

ROOF DETAIL

OTHER MODIFICATIONS

(See drawing on p.6)

The external access ladder linking the first floor office terrace to the roof of the office has been removed and replaced with an internal access hatch. If the ladder was to be retained it would require a hooped top. We consider this an omission that improves and simplifies the facade as this is essentially a back of house

The workshop units' glazed facades are marked as 'Leiab windows' on the planning drawings. This is an error and has now been corrected to be curtain walling Piercy&Company

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