


1 Proposed - Front Elevation Scale 1:50

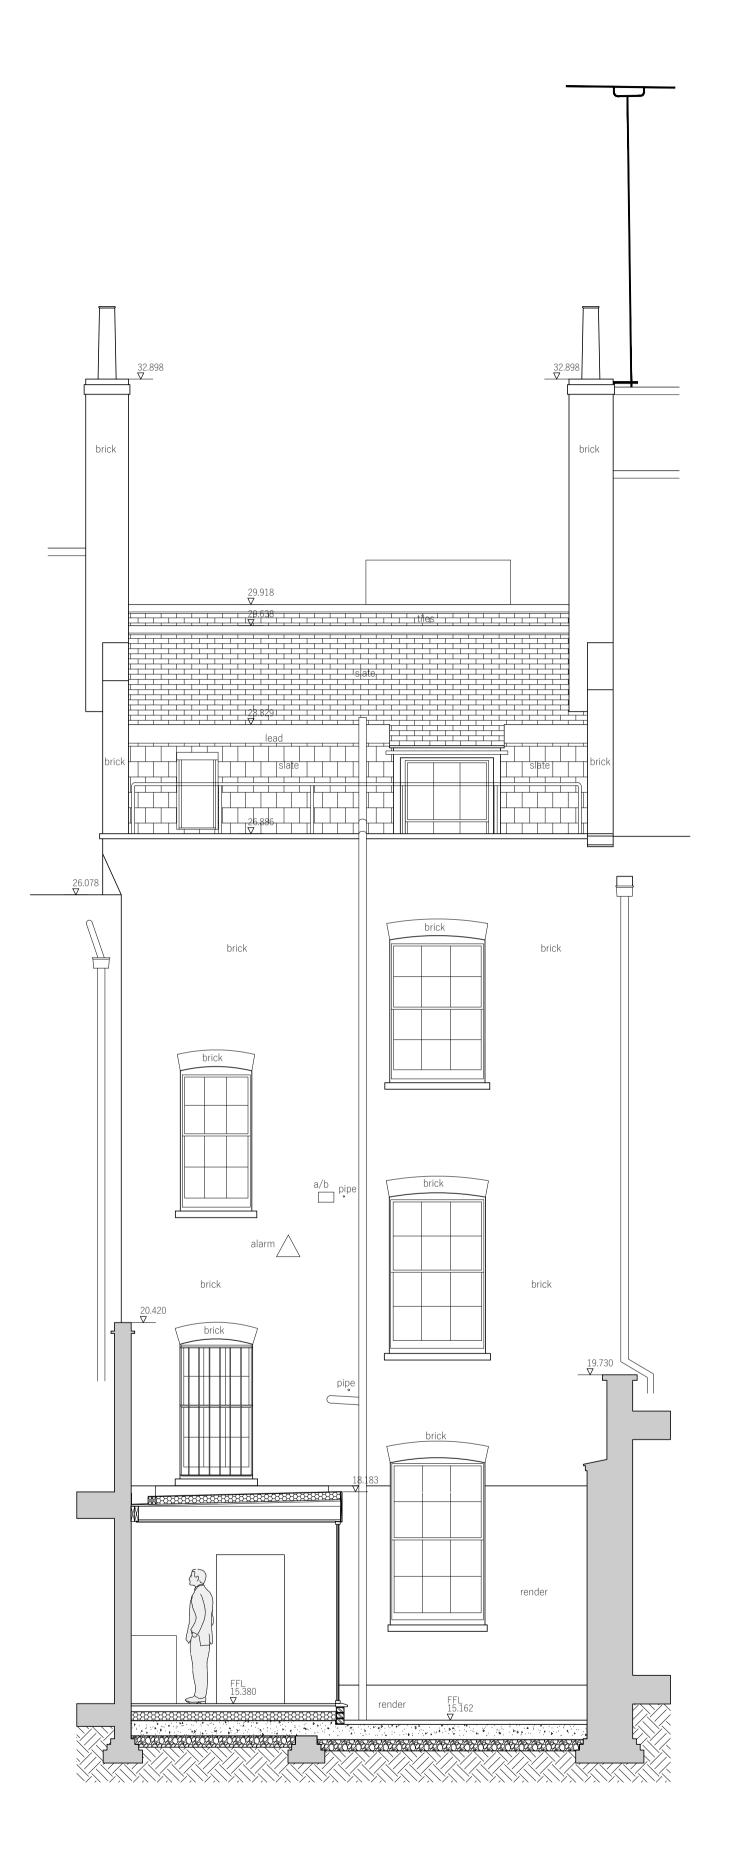








Studio 10 6-8 Cole Street London SE1 4YH

contact@dmba.co.uk dmba.co.uk +44 20 3129 0700

Key Plan

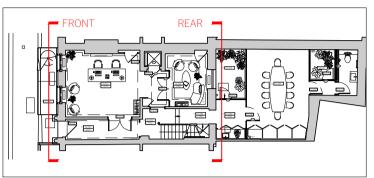

Notes

1.

PL03	11.04.22	Air Handling Unit support system revised ISSUED FOR PLANNING	MH	MH
PL02	16.03.22	MINOR REVISIONS. ISSUED FOR PLANNING	MH	MH
PL01	17.12.21	ISSUED FOR PLANNING	MH	MH
P01	14.12.21	Draft Issue For Comments	MH	MH
Rev	Date	Description	Ву	Chkd

1. Do not scale from this drawing except for the purposes of Planning. All dimensions are in mm unless otherwise stated.

2. All levels and dimensions to be checked on site by contractor prior to commencing works. Report all discrepancies to DMBA.

 All works shall follow relevant current statutory regulations.
 Workmanship and material shall follow relevant British standards and specification and codes of practice.
4. If this drawing is part of planning application, it should only be used for its purpose unless permission is sought from DMBA.

5. DMBA is not responsible for the accuracy of any information

- incorporated into this drawing from other professionals: any clarifications or further information required regarding this information from other professionals should be acquired from the relevant
- consultant or representative. DMBA are to be informed, If there are any discrepancies between this drawing and other DMBA drawings or other consultants drawings.
- This drawings in other DMBA drawings of other consultants drawings.
 This drawing is to be read in conjunction with all other DMBA drawings, specifications and schedules and all relevant consultant and specialist drawings, specifications, and contract documentation.
 All work and site procedures are to comply with CDM requirements

and regulations. 9. This drawing is subject to copyright.

Title	Proposed Front & Rear	Proposed Front & Rear Elevations			
Project	33	33 Ely Place			
Drawing	Planning				
Scale	1	1:50 at A1 .:100 at A3			
Proj No.	Drawing No.	Revision			
20023	ELY-DMB-XX-XX-DR-A-0313	PL03			

