





PROJECT
41 Belsize Road,
NW6 4RX



CONTENTS
Proposed Set, dated 15.12.2022, REV.B

PREPARED BY
Paulina Kosciak
Khalil Senhadji


Artisan Arena Ltd
Flat 115 Hartingtons Court
Coster Avenue
N4 2WN

07476887413
info@artisanarena.com
www.artisanarena.com

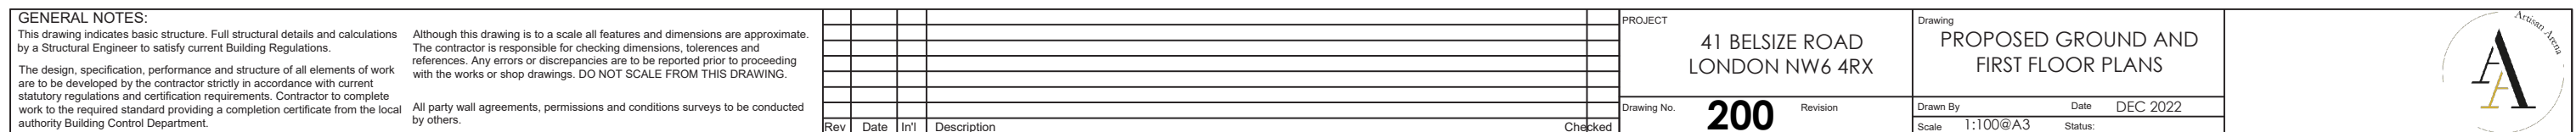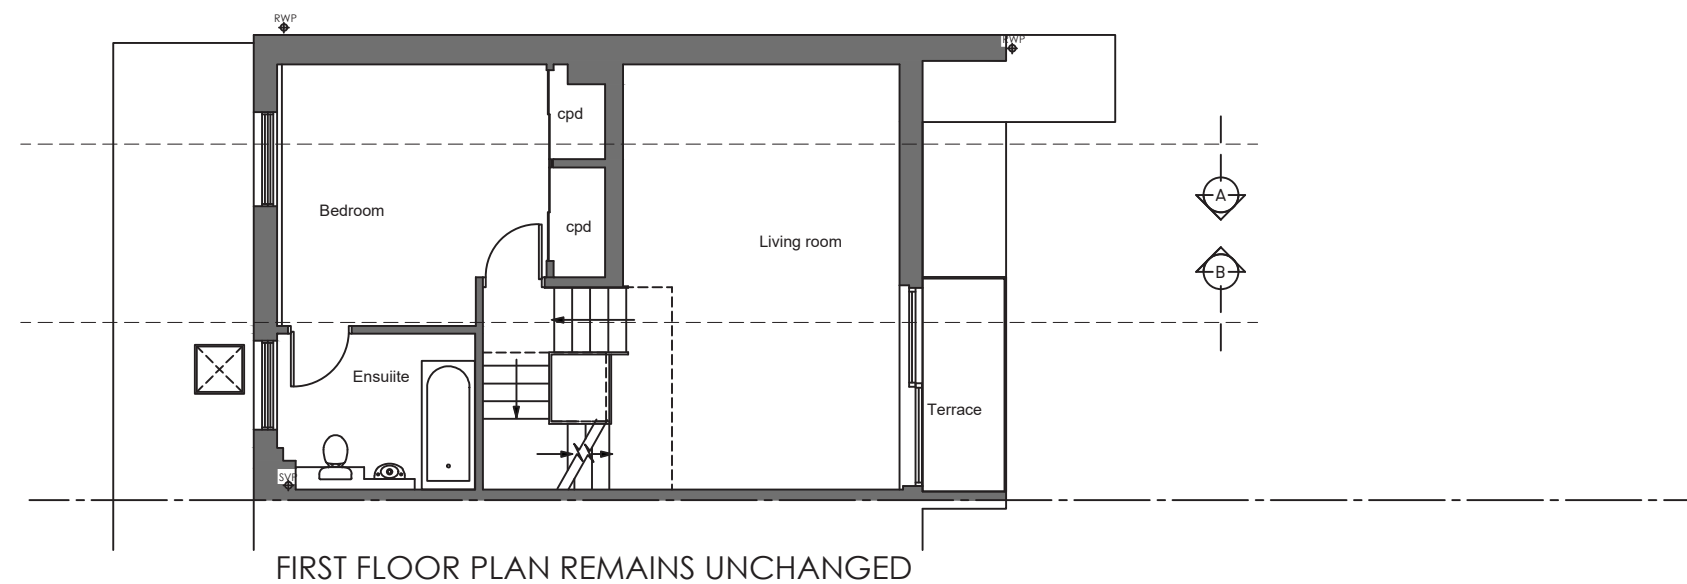


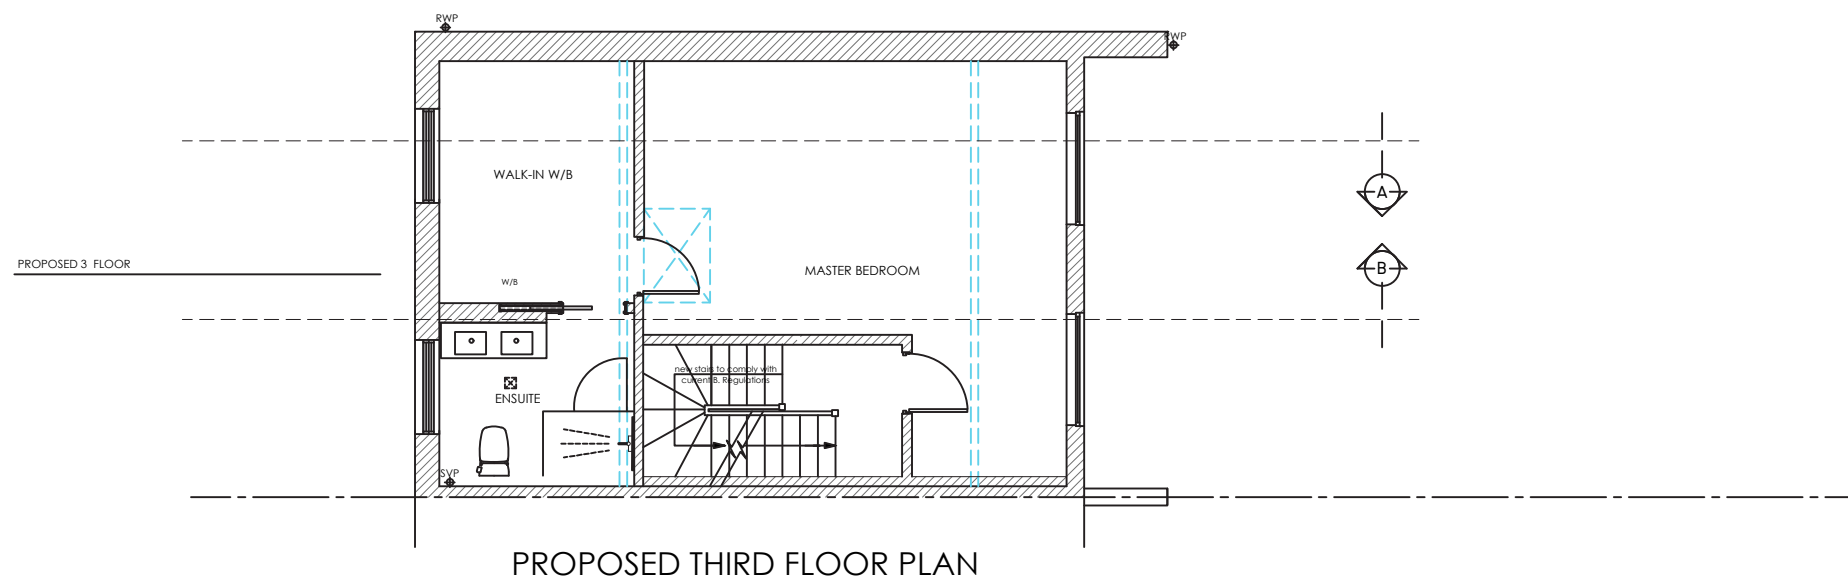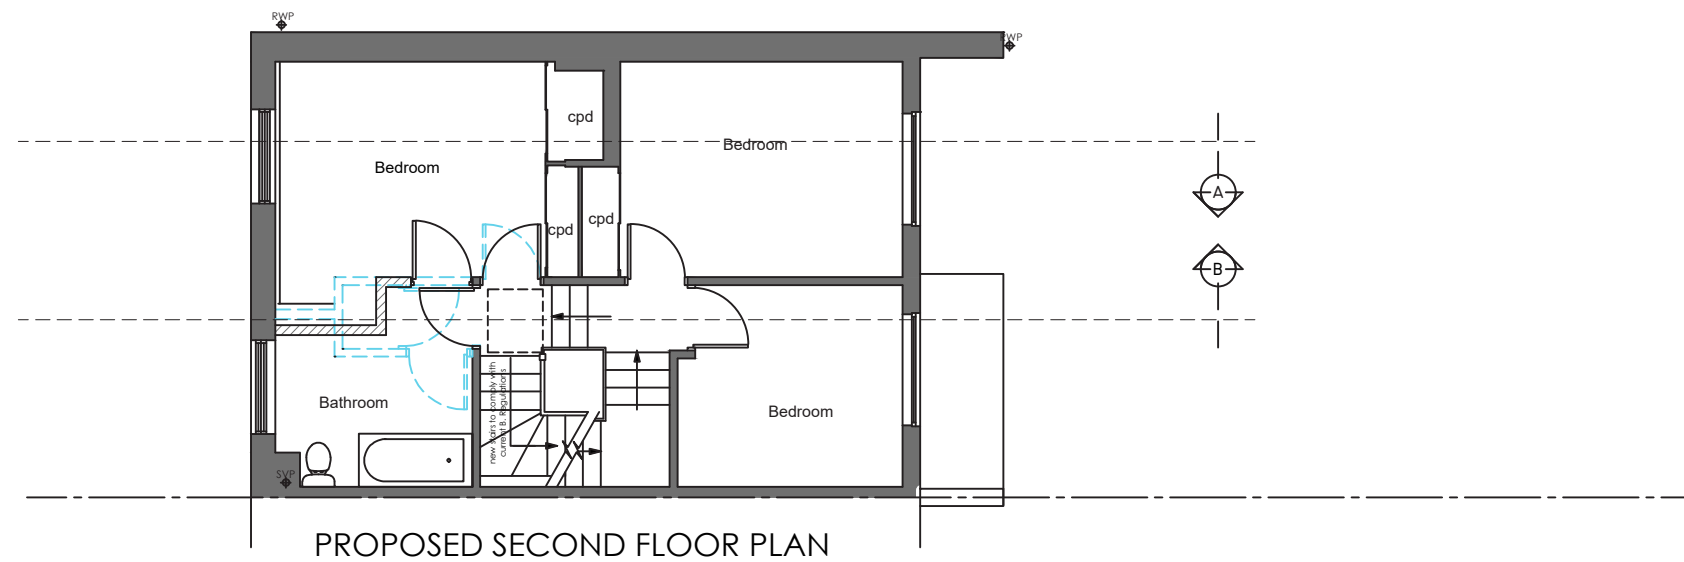


| | | | | | | | | | | | | | | |
|-----------------------------------------------------------------------------------------------------------------------------------------------------------------------------------------------------------------------------------------------------------------------------------------------------------------------------------------------------------------------------------------------------------------------------------------------------------------------------------------------------------------------------------------------|------|------|-------------|---------|--------------------------------------------------------------------------------------------------------------------------------------------------------------------------------------------------------------------------------------------------------------------------------------------------------|--|--|--|--|------------------------------------------------------------------------------------------|--|--|--|--|
| GENERAL NOTES: This drawing indicates basic structure. Full structural details and calculations by a Structural Engineer to satisfy current Building Regulations. The design, specification, performance and structure of all elements of work are to be developed by the contractor strictly in accordance with current statutory regulations and certification requirements. Contractor to complete work to the required standard providing a completion certificate from the local authority Building Control Department. | | | | | Although this drawing is to a scale all features and dimensions are approximate. The contractor is responsible for checking dimensions, tolerances and references. Any errors or discrepancies are to be reported prior to proceeding with the works or shop drawings. DO NOT SCALE FROM THIS DRAWING. | | | | | All party wall agreements, permissions and conditions surveys to be conducted by others. | | | | |
| Rev | Date | In'l | Description | Checked | PROJECT 41 BELSIZE ROAD LONDON NW6 4RX | | | | | Drawing PROPOSED SECOND AND THIRD FLOOR PLANS | | | | |
| | | | | | Drawing No. 201 Revision | | | | | Drawn By Date DEC 2022 | | | | |
| | | | | | Scale 1:100@A3 Status: | | | | | | | | | |

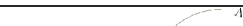



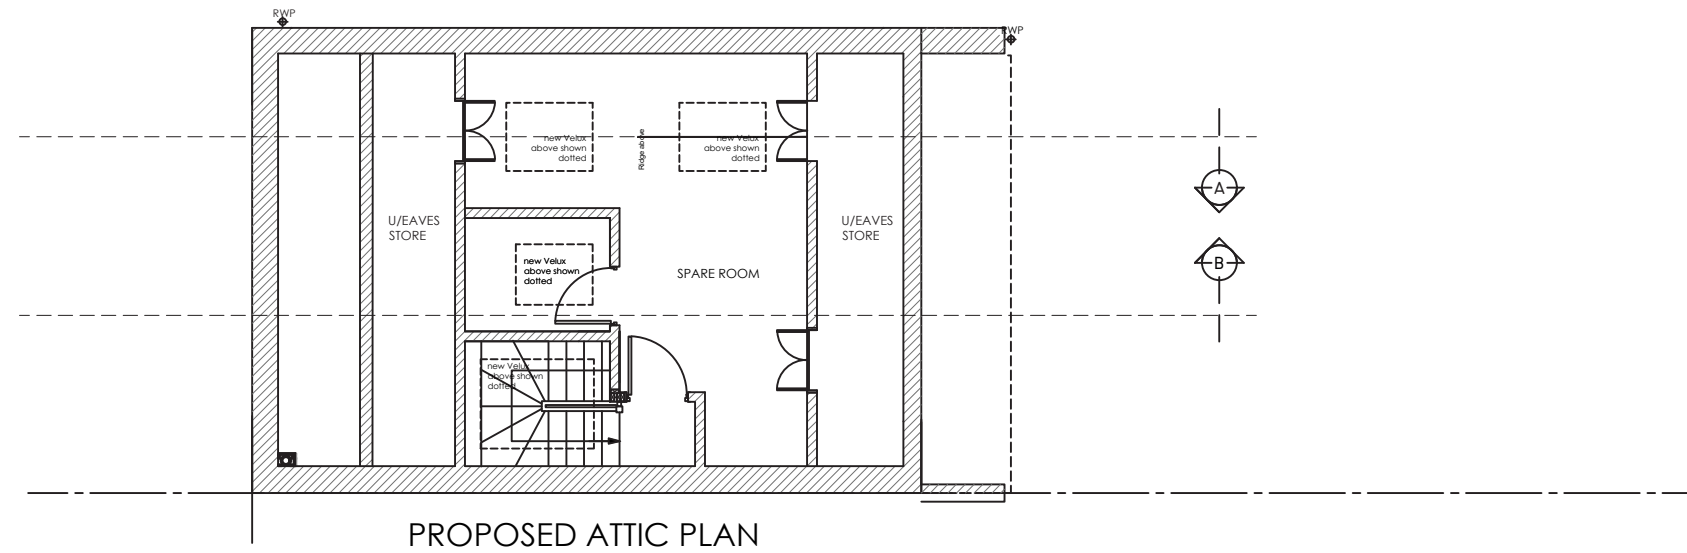

PROPOSED ROOF PLAN

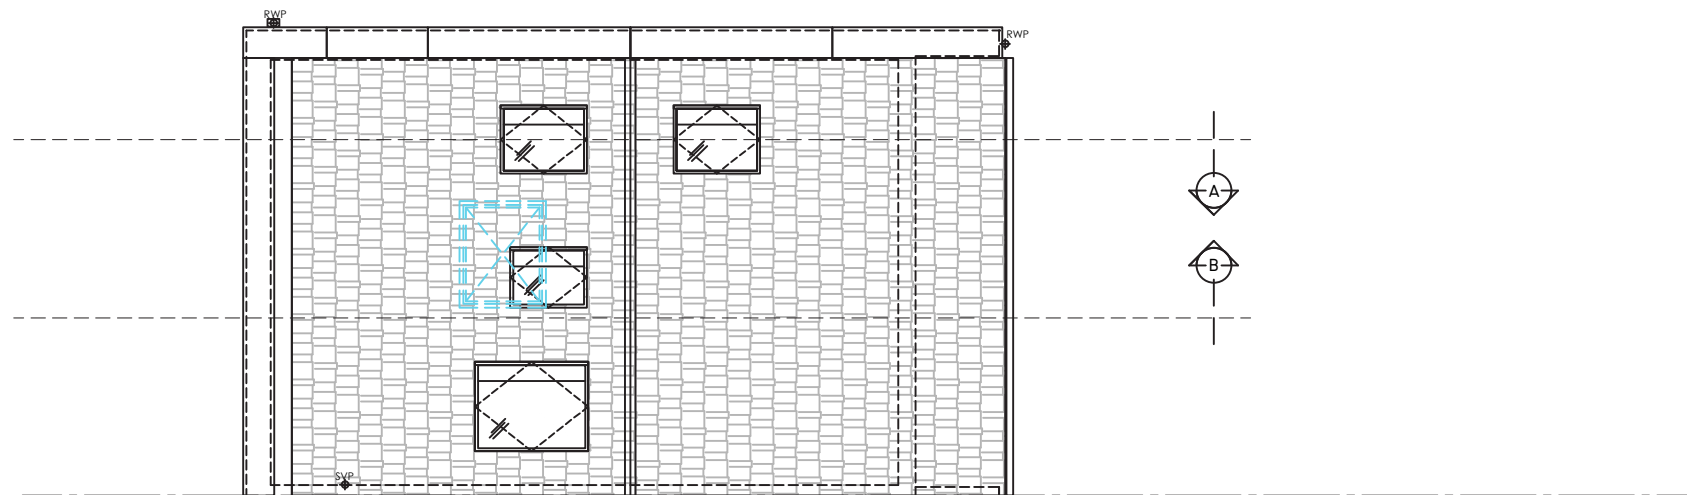

| |
|----------------------------------------------------------------------------------------------------------------------------------------------------------------------------------------------------------------------------------------------------------------------------------------------------------------------------------------------------------------------------------------------------------------------------------------------------------------------------------------------------------------------------------------------------------|
| <p>GENERAL NOTES:</p> <p>This drawing indicates basic structure. Full structural details and calculations by a Structural Engineer to satisfy current Building Regulations.</p> <p>The design, specification, performance and structure of all elements of work are to be developed by the contractor strictly in accordance with current statutory regulations and certification requirements. Contractor to complete work to the required standard providing a completion certificate from the local authority Building Control Department.</p> |
|----------------------------------------------------------------------------------------------------------------------------------------------------------------------------------------------------------------------------------------------------------------------------------------------------------------------------------------------------------------------------------------------------------------------------------------------------------------------------------------------------------------------------------------------------------|

Although this drawing is to a scale all features and dimensions are approximate. The contractor is responsible for checking dimensions, tolerances and references. Any errors or discrepancies are to be reported prior to proceeding with the works or shop drawings. **DO NOT SCALE FROM THIS DRAWING.**

All party wall agreements, permissions and conditions surveys to be conducted by others.

[illegible]


| | |
|---------|-----------------------------------|
| PROJECT | 41 BELSIZE ROAD LONDON NW6 4RX |
|---------|-----------------------------------|

| | | |
|-------------|------------|----------|
| Drawing No. | 202 | Revision |
|-------------|------------|----------|

Drawing PROPOSED THIRD AND ROOF FLOOR PLANS

| | | |
|----------|----------|----------|
| Drawn By | Date | DEC 2022 |
| Scale | 1:100@A3 | Status: |



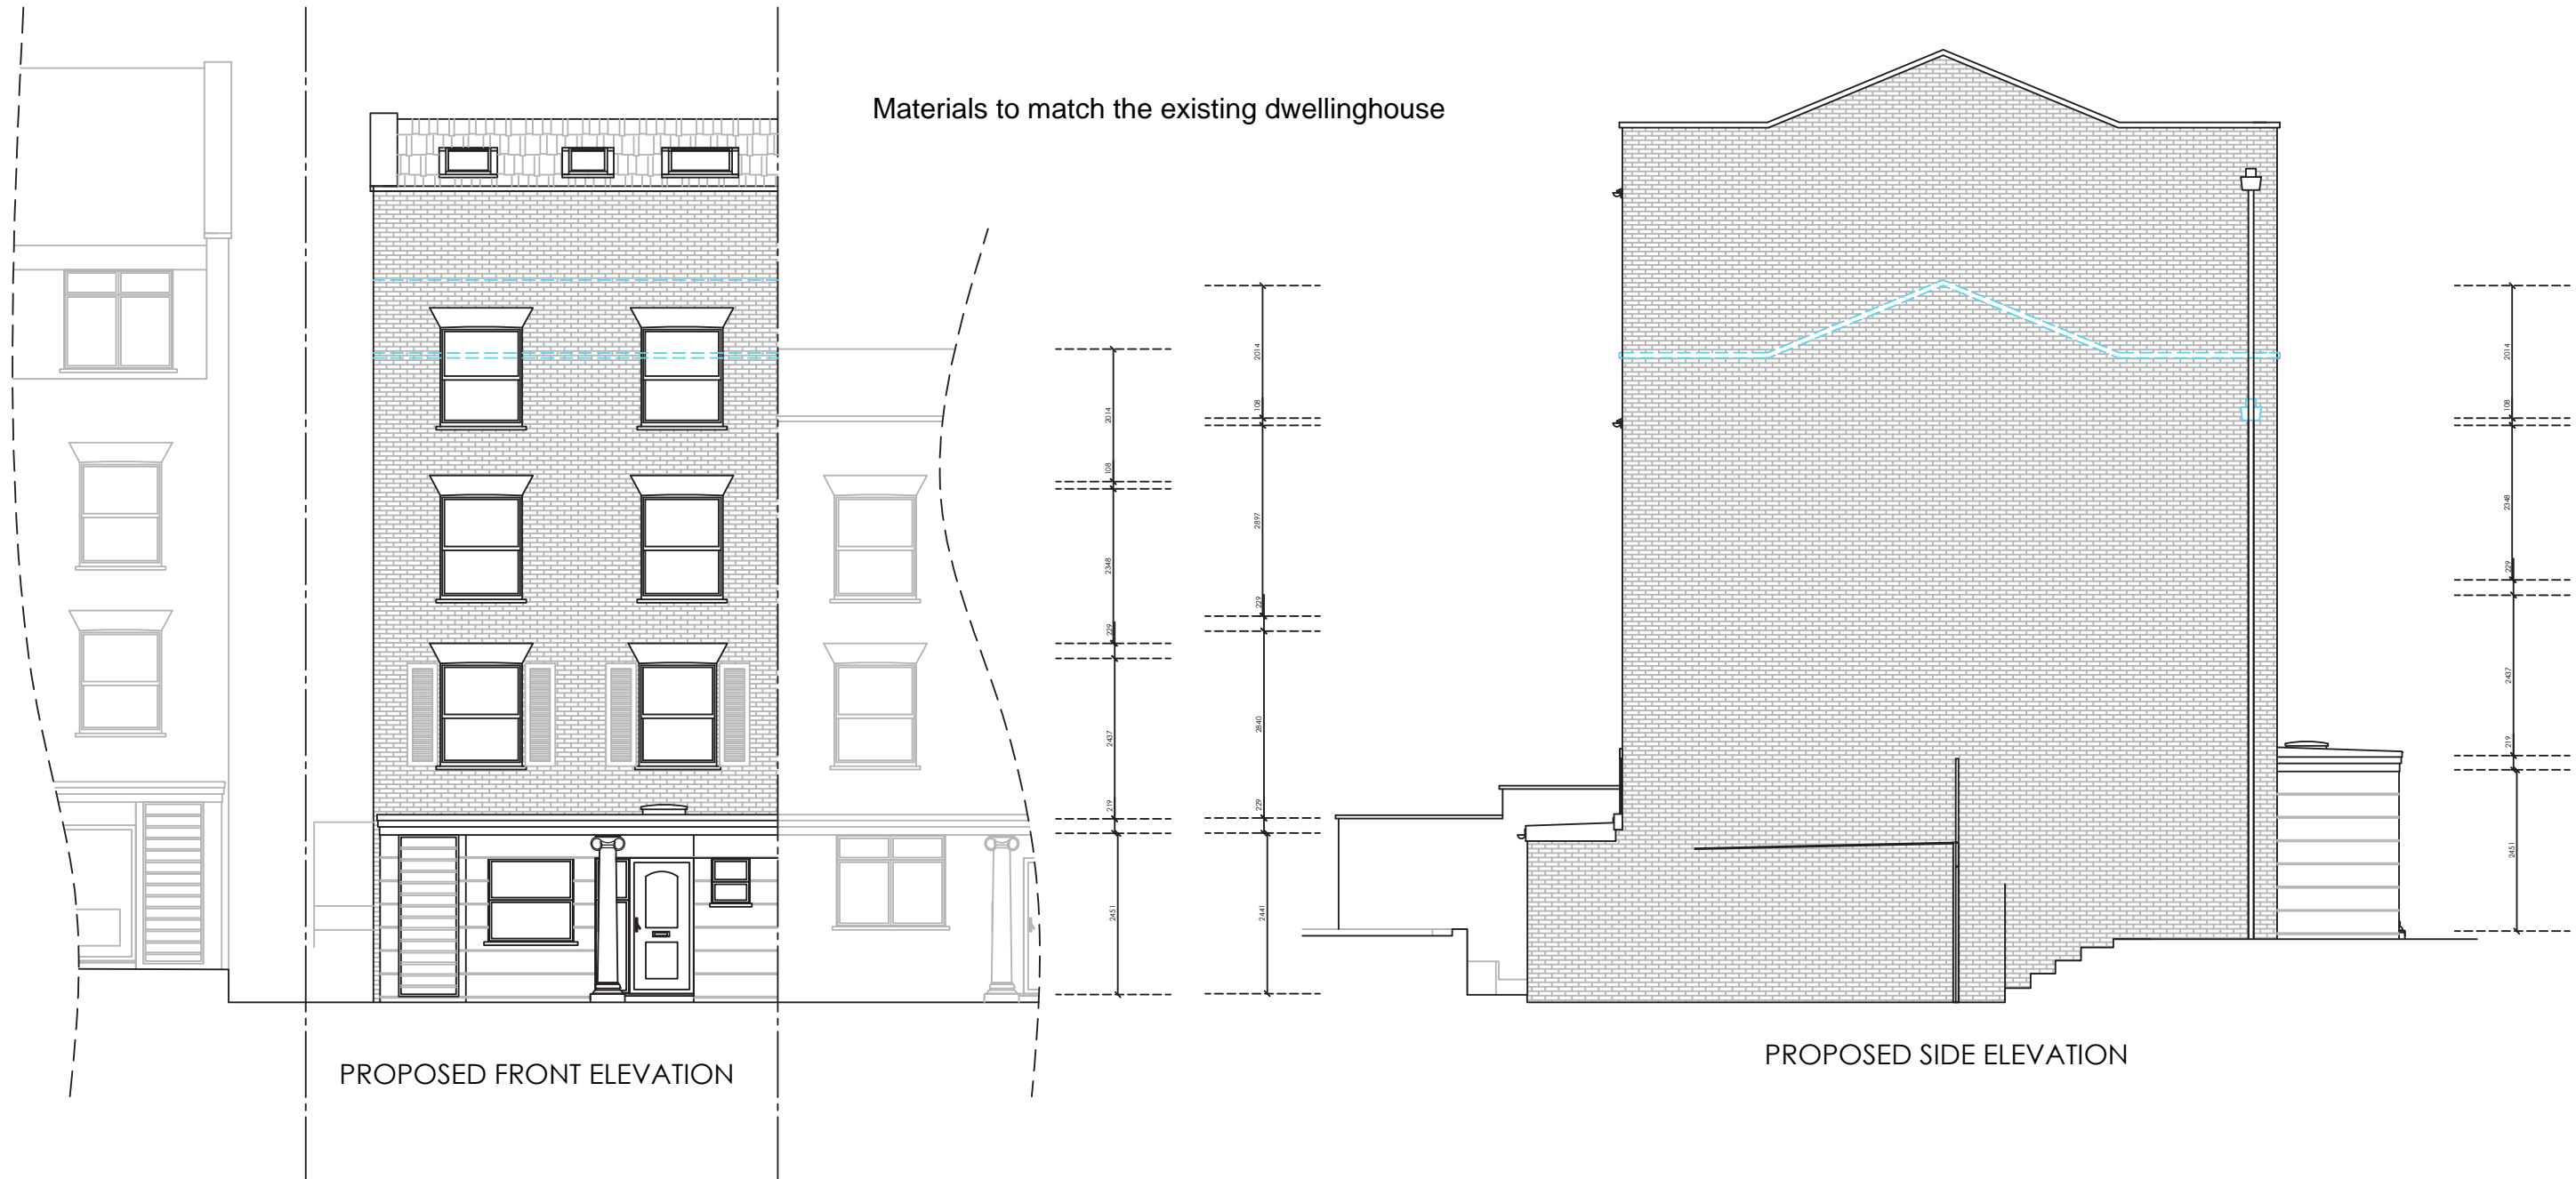

| | | | | | | | |
|-------------------------------------------------------------------------------------------------------------------------------------------------------------------------------------------------------------------------------------------------------------------------------------------------------------------------------------------------------------------------------------------------------------------------------------------------------------------------------------------------------------------------------------------------------------------------------------------------------------------------------------------------------------------------------------------------------------------------------------------------------------------------------------------------------------------------------------------------------------------------------------------------------------------------------------------------|--|--|--|----------------------------------------------|--|--------------------------------------------------|--|
| GENERAL NOTES: This drawing indicates basic structure. Full structural details and calculations by a Structural Engineer to satisfy current Building Regulations. The design, specification, performance and structure of all elements of work are to be developed by the contractor strictly in accordance with current statutory regulations and certification requirements. Contractor to complete work to the required standard providing a completion certificate from the local authority Building Control Department. Although this drawing is to a scale all features and dimensions are approximate. The contractor is responsible for checking dimensions, tolerances and references. Any errors or discrepancies are to be reported prior to proceeding with the works or shop drawings. DO NOT SCALE FROM THIS DRAWING. All party wall agreements, permissions and conditions surveys to be conducted by others. | | | | PROJECT 41 BELSIZE ROAD LONDON NW6 4RX | | Drawing PROPOSED FRONT AND SIDE ELEVATIONS | |
| Rev | | | | Drawing No. 210 | | Drawn By | |
| Date | | | | Revision | | Date DEC 2022 | |
| In/1 | | | | Checked | | Scale 1:100@A3 | |
| Description | | | | | | Status: | |



Figure 1 consists of two diagrams illustrating the construction of a 2D grid. The left diagram shows a vertical line with points labeled 2441, 227, 2343, 279, 2997, 103, and 2014. The right diagram shows a vertical line with points labeled 2441, 227, 2640, 472, 2997, 103, and 2014. Both diagrams include horizontal dashed lines and arrows indicating the construction process.

ghouse

Architectural section drawing of a house. The drawing shows the internal structure, including the roof, walls, and floor slabs. The roof is gabled with a pitch of 27.75. The drawing includes a north arrow pointing towards the upper right. Dimensions are provided for various parts of the structure:

- Roof pitch: 27.75
- Overall height: 26.61
- Height of the ground floor: 2.61
- Height of the first floor: 2.19
- Height of the second floor: 2.67
- Height of the third floor: 2.29
- Height of the fourth floor: 2.14
- Height of the fifth floor: 2.08

The drawing also shows a staircase on the left side and a chimney on the right side. The walls are shown in cross-section, and the floor slabs are indicated by dashed lines. The drawing is a technical representation of the building's structure and dimensions.



| | |
|------|----------|
| Date | DEC 2022 |
|------|----------|

