


1 Existing Front Elevation Scale: 1:50

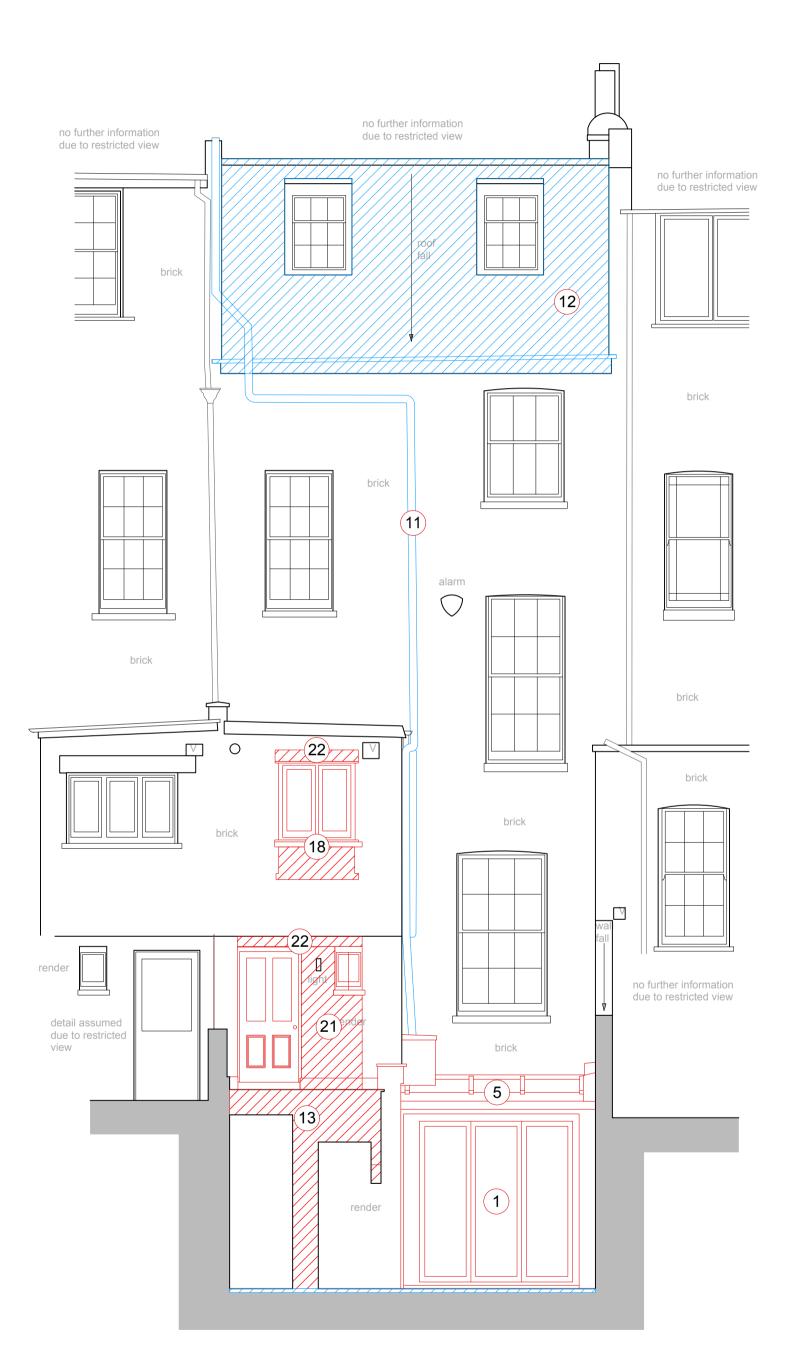

2 Existing Rear Elevation Scale: 1:50

<u>KEY</u>

- 1. REMOVAL OF NON-ORIGINAL DOOR
- 2. REMOVAL OF NON-ORIGINAL WINDOW
- 3. REMOVAL OF NON-ORIGINAL WALL / PARTITION
- REPLACEMENT OF NON-ORGINAL STAIRS
 REMOVAL OF NON-ORIGINAL ROOFLIGHT
- REMOVAL OF NON-ORIGINAL ROOFLIGHT
 REPLACEMENT OF NON ORIGINAL BALUSTARDE
- REMOVAL OF NON-ORIGINAL JOINERY
- 8. REMOVAL OF NON-ORIGINAL MANTLE / SURROUND AND HEARTH
- 9. REPLACEMENT OF NON-ORIGINAL STAIRCASE
- REMOVAL OF NON-ORIGINAL SANITARYWARE
 REMOVAL OF NON-ORIGINAL M&E (ALL PLANT / RADIATORS AND EXTERNAL PIPEWORK TO BE REPLACED)
- 12. REMOVAL OF NON ORIGINAL ROOF TILES AND FLASHING
- 13. REPLACEMENT OF REAR GARDEN SLAB AT NEW HEIGHT
- 14. ENLARGEMENT OF NON-ORIGINAL WINDOW OPENING TO ALLOW FOR REINSTATEMENTM OF
- ACCESS DOOR UNDER FRONT STAIRS 15. MINOR DEMOLITION WORKS TO ALLOW FOR REPOSITIONING OF NON-ORIGINAL DOOR (DOOR KEPT AND REUSED)
- 16. EXISTING DOOR HANDING CHANGE
- 17. REMOVAL OF NON ORIGINAL FLOOR FINISHES & UNDERFLOOR HEATING
- 18. LOWERING OF NON-ORIGINAL WINDOW SILL TO ALLOW FOR NEW SASH WINDOW OF MORE
- APPROPRIATE STYLE 19. REMEDIAL WORKS TO STAIRCASE REQUIRED DUE TO SEVERE SUBSIDANCE - TEMPORARY PROPPING WITH ALL EXISTING MATERIALS AND FEATURES TO BE RETAINED AS MUCH AS POSSIBLE. ALL ROTTEN TIMBER TO BE REPLACED LIKE FOR LIKE- ADDIDIONAL SUPPORT ADDED TO REDUCE FUTURE SUBSIDENCE
- 20. ALL CORNICES TO BE STRIPPED WITH PEELAWAY 1 (https://peelaway.co.uk/130/peelaway-1) TO REVEAL ORIGINAL PROFILES
- RECONFIGURATION OF CLOSET WING WINDOW AND DOOR TO ALLOW FOR DIRECT ACCESS.
 CLOSET WING CONCRETE LINTELS TO BE REPLACED
- 23. RECONFIGURATION OF MANSARD ROOF TO REINSTATE MANSARD AND INTRODUCE DORMER

REMOVAL

DEMOLITION

REVISION	A 04/10/2022		Pla	Planning Feedback Update		
DATE	28.06.2019		SC	ALE	1:50@A1	
PROJECT	11 Chamberlain Street					
CLIENT	Jaakko Ahmala & Liisa Tornivaara					
DRAWING TITLE	EXISTING ELEVATIONS					
DRAWING No.	EX_013					
ISSUE	PLANNING					
TR STUDIO			27 -	Unit 5.10 Clerkenwell Workshops 27 - 31 Clerkenwell Close London EC1R 0AT		
Archite	cture Inte	riors	T: E: W:	office@trstue	dio.co.uk	
This drawing must not be scaled from nor should it be used for the calculation of areas for the purposes of valuation. All dimensions are indicative and must be verified on site prior to the commencement of any works. This drawing must be read in conjunction with all necessary information from all other design consultants and contractors. All works must comply with the relevant British standards and building control requirements. Drawing errors to be reported to the Architect.						