


date: JUNE 2022 scale: 1:100 @ A3 CHETWYND ROAD drawing: EXISTING


GROUND FLOOR PLAN

number: 189 003 revision: P01 drawn: TSL checked: PdA

## GENERAL NOTES:

- 1. DO NOT SCALE FROM THIS DRAWING, EXCEPT FOR PLANNING PURPOSES
- 2. ALL DIMENSIONS AND LEVELS TO BE CHECKED ONSITE
- 3. ALL STRUCTURAL ELEMENTS TO STRUCTURAL ENGINEER'S SPECIFICATION AND DETAILS
- 4. ALL DETAILS TO MANUFACTURERS SPECIFICATION AND DETAILS
- 5. DRAWINGS TO BE READ IN CONJUNCTION WITH SCOPE OF WORKS TO1
- 6. ALL DETAILS SUBJECT TO BUILDING CONTROL APPROVAL
- 7. ALL DETAILS SUBJECT TO PARTY WALL AWARD
- 8. BOUNDARY LINES SHOWN ARE INDICATIVE AND
- TO BE CONFIRMED BY CLIENT
- 9. ISSUE NOT FOR CONSTRUCTION
- ©2022 MAY NOT BE REPRODUCED WITHOUT PERMISSION

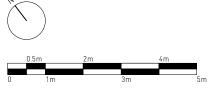

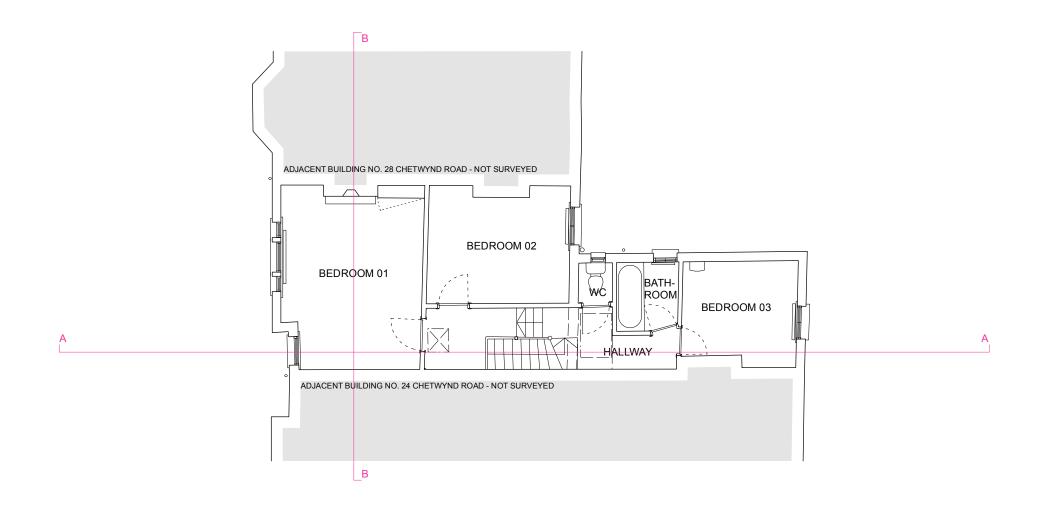

date: JUNE 2022 scale: 1:100 @ A3 CHETWYND ROAD


drawing: EXISTING FIRST FLOOR PLAN


number: 189 004 revision: P01 drawn: TSL checked: PdA

## GENERAL NOTES:

- 1. DO NOT SCALE FROM THIS DRAWING, EXCEPT FOR
- PLANNING PURPOSES
- 2. ALL DIMENSIONS AND LEVELS TO BE CHECKED ONSITE
- 3. ALL STRUCTURAL ELEMENTS TO STRUCTURAL ENGINEER'S SPECIFICATION AND DETAILS
- 4. ALL DETAILS TO MANUFACTURERS SPECIFICATION AND DETAILS
- 5. DRAWINGS TO BE READ IN CONJUNCTION WITH SCOPE OF WORKS TO1
- 6. ALL DETAILS SUBJECT TO BUILDING CONTROL APPROVAL
- 7. ALL DETAILS SUBJECT TO PARTY WALL AWARD
- 8. BOUNDARY LINES SHOWN ARE INDICATIVE AND
- TO BE CONFIRMED BY CLIENT
- 9. ISSUE NOT FOR CONSTRUCTION
- ©2022 MAY NOT BE REPRODUCED WITHOUT PERMISSION



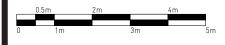

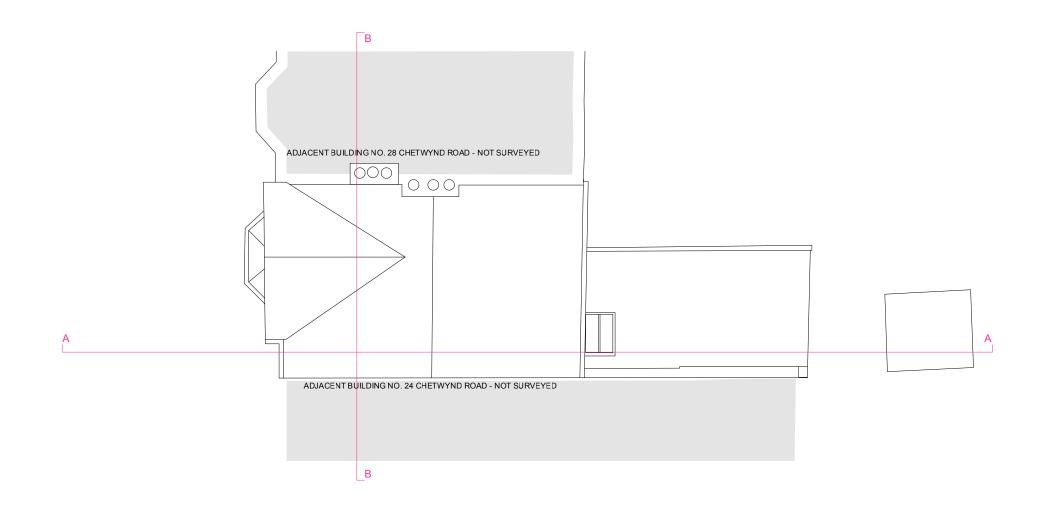

date: JUNE 2022 scale: 1:100 @ A3 CHETWYND ROAD


drawing: EXISTING ROOF PLAN

number: 189 005 revision: P01 drawn: TSL checked: PdA

# GENERAL NOTES:

- 1. DO NOT SCALE FROM THIS DRAWING, EXCEPT FOR PLANNING PURPOSES
- 2. ALL DIMENSIONS AND LEVELS TO BE CHECKED ONSITE
- 3. ALL STRUCTURAL ELEMENTS TO STRUCTURAL ENGINEER'S SPECIFICATION AND DETAILS
- 4. ALL DETAILS TO MANUFACTURERS SPECIFICATION AND DETAILS
- 5. DRAWINGS TO BE READ IN CONJUNCTION WITH SCOPE OF WORKS TO1
- 6. ALL DETAILS SUBJECT TO BUILDING CONTROL APPROVAL
- 7. ALL DETAILS SUBJECT TO PARTY WALL AWARD
- 8. BOUNDARY LINES SHOWN ARE INDICATIVE AND
- TO BE CONFIRMED BY CLIENT
- 9. ISSUE NOT FOR CONSTRUCTION
- ©2022 MAY NOT BE REPRODUCED WITHOUT PERMISSION



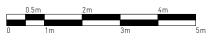







REAR ELEVATION

date: JUNE 2022 scale: 1:100 @ A3 job: CHETWYND ROAD drawing: EXISTING

FRONT & REAR ELEVATIONS

number: 189 006 revision: drawn: TSL checked: PdA

# GENERAL NOTES:

- 1. DO NOT SCALE FROM THIS DRAWING, EXCEPT FOR
- PLANNING PURPOSES
- 2. ALL DIMENSIONS AND LEVELS TO BE CHECKED ONSITE
- 3. ALL STRUCTURAL ELEMENTS TO STRUCTURAL ENGINEER'S SPECIFICATION AND DETAILS
- 4. ALL DETAILS TO MANUFACTURERS SPECIFICATION AND DETAILS
- 5. DRAWINGS TO BE READ IN CONJUNCTION WITH SCOPE OF WORKS TO1
- 6. ALL DETAILS SUBJECT TO BUILDING CONTROL APPROVAL
- 7. ALL DETAILS SUBJECT TO PARTY WALL AWARD
- 8. BOUNDARY LINES SHOWN ARE INDICATIVE AND
- TO BE CONFIRMED BY CLIENT
- 9. ISSUE NOT FOR CONSTRUCTION
- ©2022 MAY NOT BE REPRODUCED WITHOUT PERMISSION





date: JUNE 2022 scale: 1:100 @ A3 CHETWYND ROAD drawing: EXISTING SECTION AA

number: 189 007 revision: P01 drawn: TSL checked: PdA

## GENERAL NOTES:

- 1. DO NOT SCALE FROM THIS DRAWING, EXCEPT FOR
- PLANNING PURPOSES
- 2. ALL DIMENSIONS AND LEVELS TO BE CHECKED ONSITE
- 3. ALL STRUCTURAL ELEMENTS TO STRUCTURAL ENGINEER'S SPECIFICATION AND DETAILS
- 4. ALL DETAILS TO MANUFACTURERS SPECIFICATION AND DETAILS
- 5. DRAWINGS TO BE READ IN CONJUNCTION WITH SCOPE OF WORKS TO1
- 6. ALL DETAILS SUBJECT TO BUILDING CONTROL APPROVAL
- 7. ALL DETAILS SUBJECT TO PARTY WALL AWARD
- 8. BOUNDARY LINES SHOWN ARE INDICATIVE AND
- TO BE CONFIRMED BY CLIENT
- 9. ISSUE NOT FOR CONSTRUCTION
- ©2022 MAY NOT BE REPRODUCED WITHOUT PERMISSION



date: JUNE 2022 scale: 1:100 @ A3

CHETWYND ROAD drawing: EXISTING

SECTION BB number: 189 008 revision: P01 drawn: TSL checked: PdA

# GENERAL NOTES:

- 1. DO NOT SCALE FROM THIS DRAWING, EXCEPT FOR
- PLANNING PURPOSES
- 2. ALL DIMENSIONS AND LEVELS TO BE CHECKED ONSITE
- 3. ALL STRUCTURAL ELEMENTS TO STRUCTURAL ENGINEER'S SPECIFICATION AND DETAILS
- 4. ALL DETAILS TO MANUFACTURERS SPECIFICATION AND DETAILS
- 5. DRAWINGS TO BE READ IN CONJUNCTION WITH

SCOPE OF WORKS TO1

- 6. ALL DETAILS SUBJECT TO BUILDING CONTROL APPROVAL
- 7. ALL DETAILS SUBJECT TO PARTY WALL AWARD
- 8. BOUNDARY LINES SHOWN ARE INDICATIVE AND
- TO BE CONFIRMED BY CLIENT
- 9. ISSUE NOT FOR CONSTRUCTION

©2022 - MAY NOT BE REPRODUCED WITHOUT PERMISSION