

HIGH HOLBORN

FRONT ELEVATION

1:100



EXISTING AIR-HANDLING PLANT AND CHILLER PLANT ON MAIN ROOF



SIDE ELEVATION


KEY PLAN

C

REAR ELEVATION	Project No: Drawing No: Revision no: A		
	Title:         Front & Side Elevation         Plant Layout         Existing         Notes:         No:       Detail:         1.       DIMENSIONS Figured dimensions are to be taken in preference to scaled dimensions. All dimensions are to be verified on site prior to work commencing.         2.       DISCREPANCIES		
FRONT ELEVATION High Holborn	<ul> <li>Any discrepancy is to be referred to the consultant <u>before</u> proceeding.</li> <li>3. <u>COPYRIGHT ©_2022</u> Copyright in this drawing is the property of Michael Jones &amp; Associates LLP and must not be reproduced nor amended nor used for the execution of any woks whether in connection with the proposed works for which it is prepared or otherwise without the express consent of Michael Jones &amp; Associates LLP. All rights reserved.</li> <li>4. <u>RELATED DOCUMENTS</u></li> </ul>		
EXISTING CHILLER PLANT ZONE (CH1 + CH2) AT ROOF LEVEL, EACH CHILLER BEING 3600mm LONG x 1300mm WIDE x 2200mm HIGH SITTING ON SUPPORT STEELS @ 300mm HIGH	This drawing shall be read in conjunction with the relevant written Specification of Works, accompanying drawings equipment schedules and all other relevant documents connected to those works shown on this drawing.		
HOLBORN			
	6th		
_	ASept 2022Planning Application (1)-26th Aug 2022Planning ApplicationNo:Date:Amendment:Revision:Image: Amendment:		
	ichael Jones & Associates LLP NGINEERING CONSULTANTS Crossway House 8 London Road, Reigate, Surrey, RH2 9HY. Tel: +44(0)1737 245610 Fax: +44(0)1737 241142 e.mail: info@mjassociates.co.uk www.mjassociates.co.uk		
	Scale:       Date:       Drawn:       Chkd:         1:100@A1       Aug 2022       EF       MJA         Client:       ACAI (Swan House) Ltd         Project:       Swan House         37-39 High Holborn       John WC1V 6AA         Title:       Title:		
	Front & Side Elevation         Plant Layout         Existing         Project No:         Drawing No:         Revision No:		
NNING APPLICATION	D6146 PA.03 A		


1:100



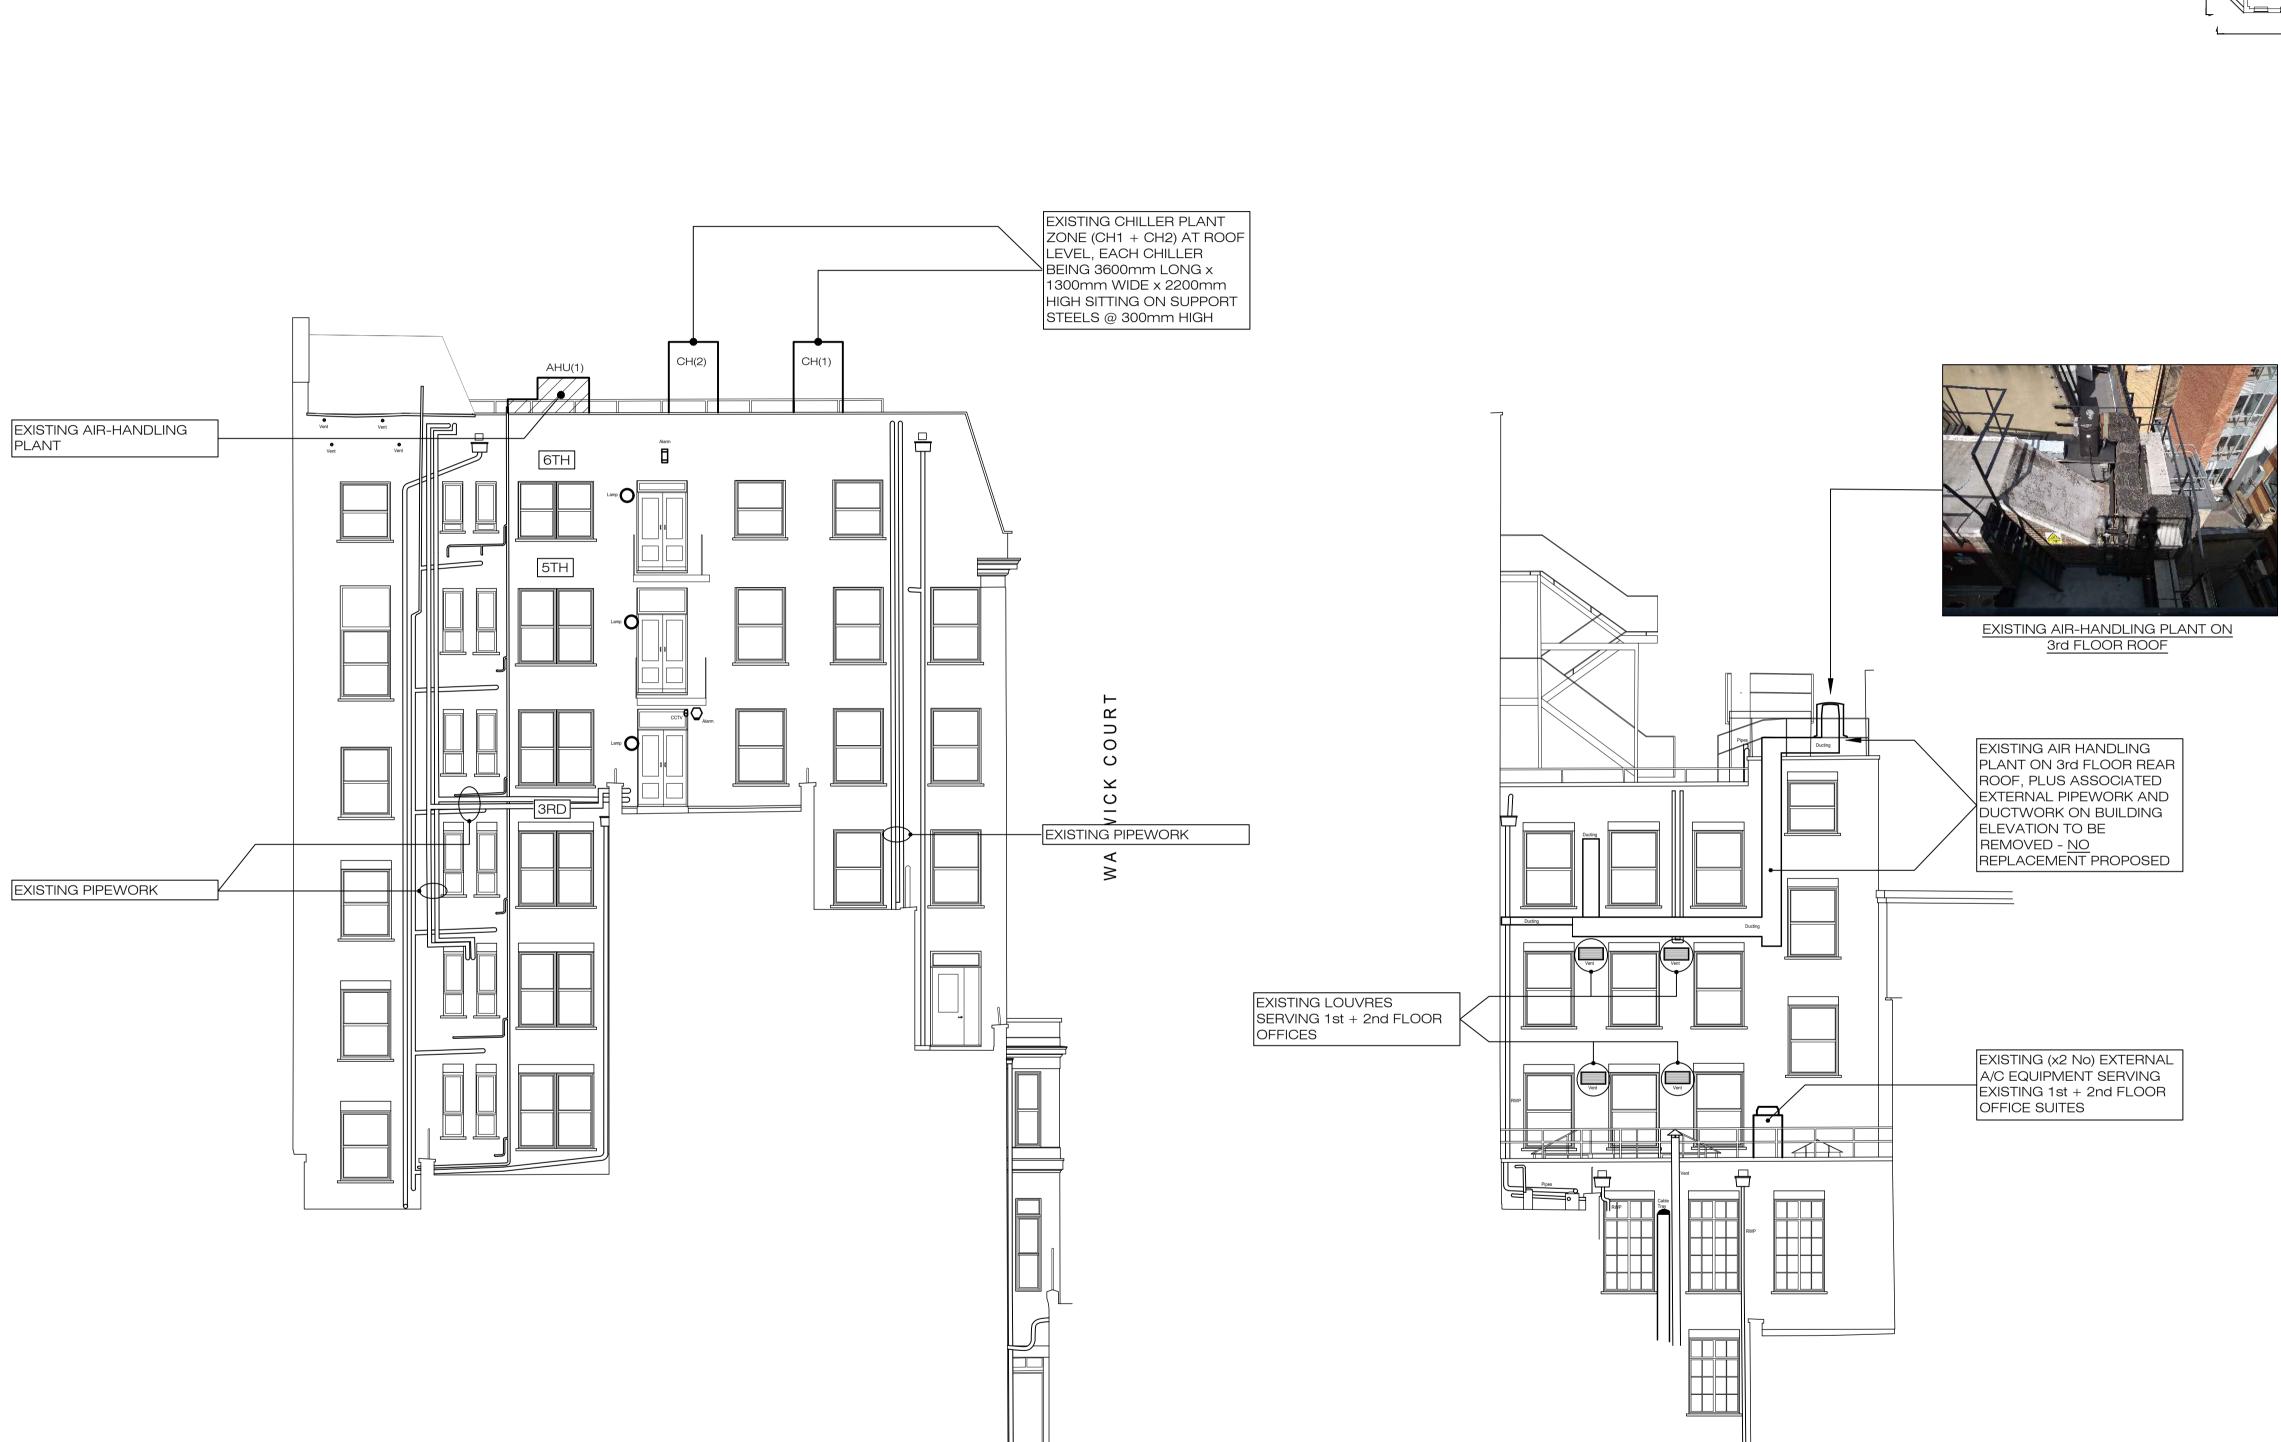

LIGHTWELL ELEVATION

\_\_\_\_\_

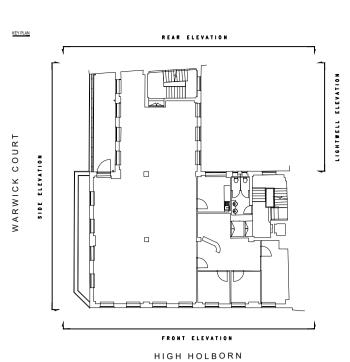

C

U K

≥



<u>FRONT ELEVATION</u>


1:100



KEY PLAN

<u>SIDE ELEVATION</u>

	Project No: D6146 Data Data Drawing No: PA.05 - Title: Front & Side Elevation Plant Layout Proposed		
TOUT ELEVATION HIGH HOLBORN	Notes:         No:       Detail:         1.       DIMENSIONS Figured dimensions are to be taken in preference to scaled dimensions. All dimensions are to be verified on site prior to work commencing.         2.       DISCREPANCIES Any discrepancy is to be referred to the consultant before proceeding.         3.       COPYRIGHT © 2022 Copyright in this drawing is the property of Michael Jones & Associates LLP and must not be reproduced nor amended nor used for the execution of any woks whether in connection with the proposed works for which it is prepared or otherwise without the express consent of Michael Jones & Associates LLP. All rights reserved.         4.       RELATED DOCUMENTS This drawing shall be read in conjunction with the relevant written Specification of Works, accompanying drawings equipment schedules and all other relevant documents connected to those works shown on this drawing.		
ATCHED ZONE EPRESENTS PROPOSED DITION OF REPLACEMENT TERNAL PLANT ONTAINED WITHIN AN ALL FOOTPRINT OF 20mm LONG x 1685mm GH x 760mm DEEP TING ON EXISTING JPPORT STEELS			
	Image: Sept 2022       Planning Application         No:       Date:       Amendment:         Revision:       Image: Sept 2022		
	Revision:         In chael Jones & Associates LLP         N G I N E E R I N G C O N S U L T A N T S         Crossway House         8 London Road, Reigate, Surrey, RH2 9HY.         Tel: +44(0)1737 245610 Fax: +44(0)1737 241142         e.mail: info@mjassociates.co.uk         www.mjassociates.co.uk         Scale:         1:100@A1         Date:         Aug 2022         Drawn:         Chkd:         MJA    Client: ACAI (Swan House) Ltd          Project:         Swan House         37-39 High Holborn         London WC1V 6AA         Title:         Front & Side Elevation         Plant Layout         Proposed		
NNING APPLICATION	Project No: D6146 PA.05 -		

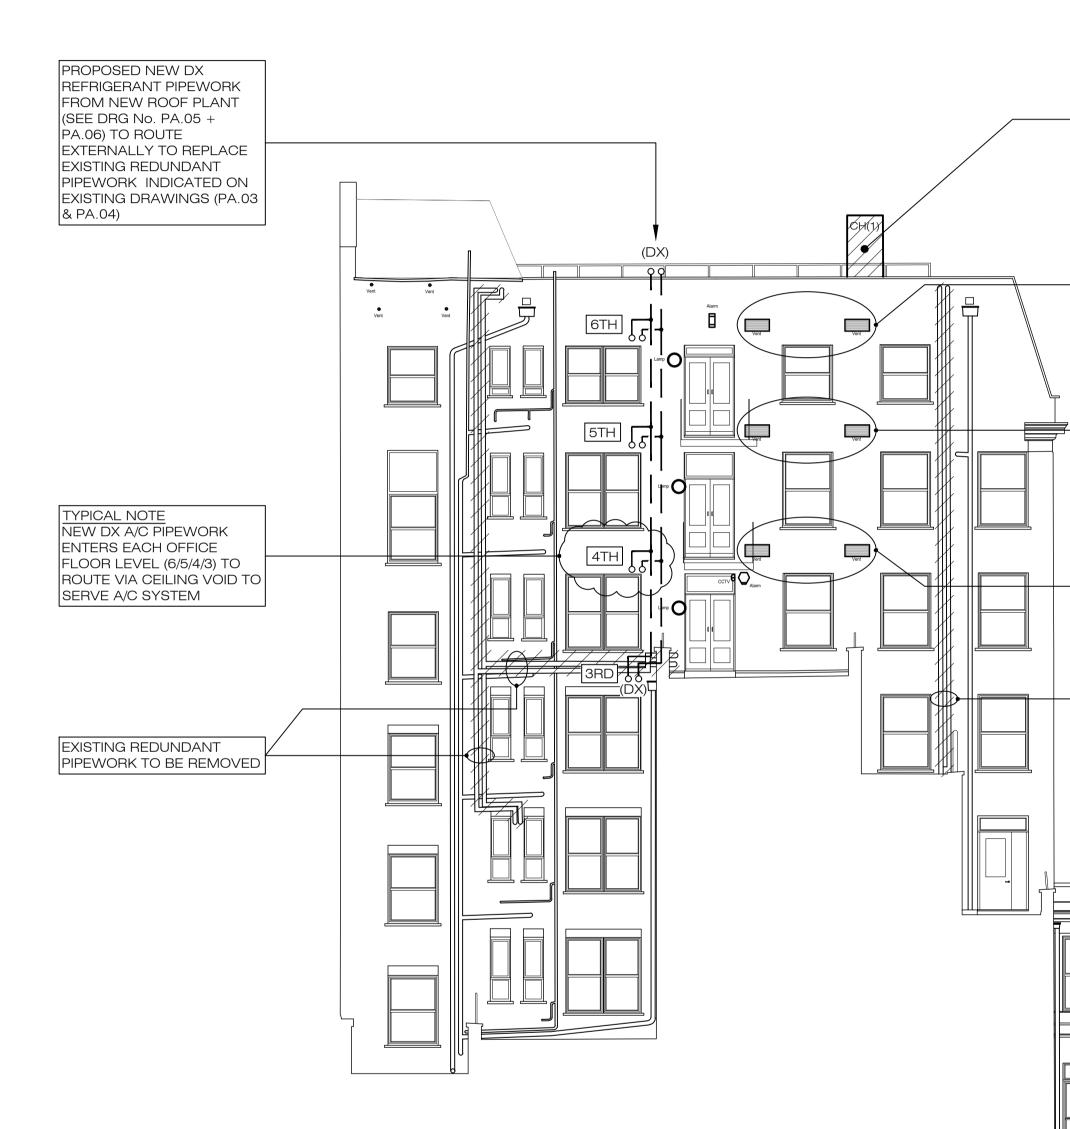


REAR ELEVATION

LEVEL


LEVEL

LEVEL

1:100

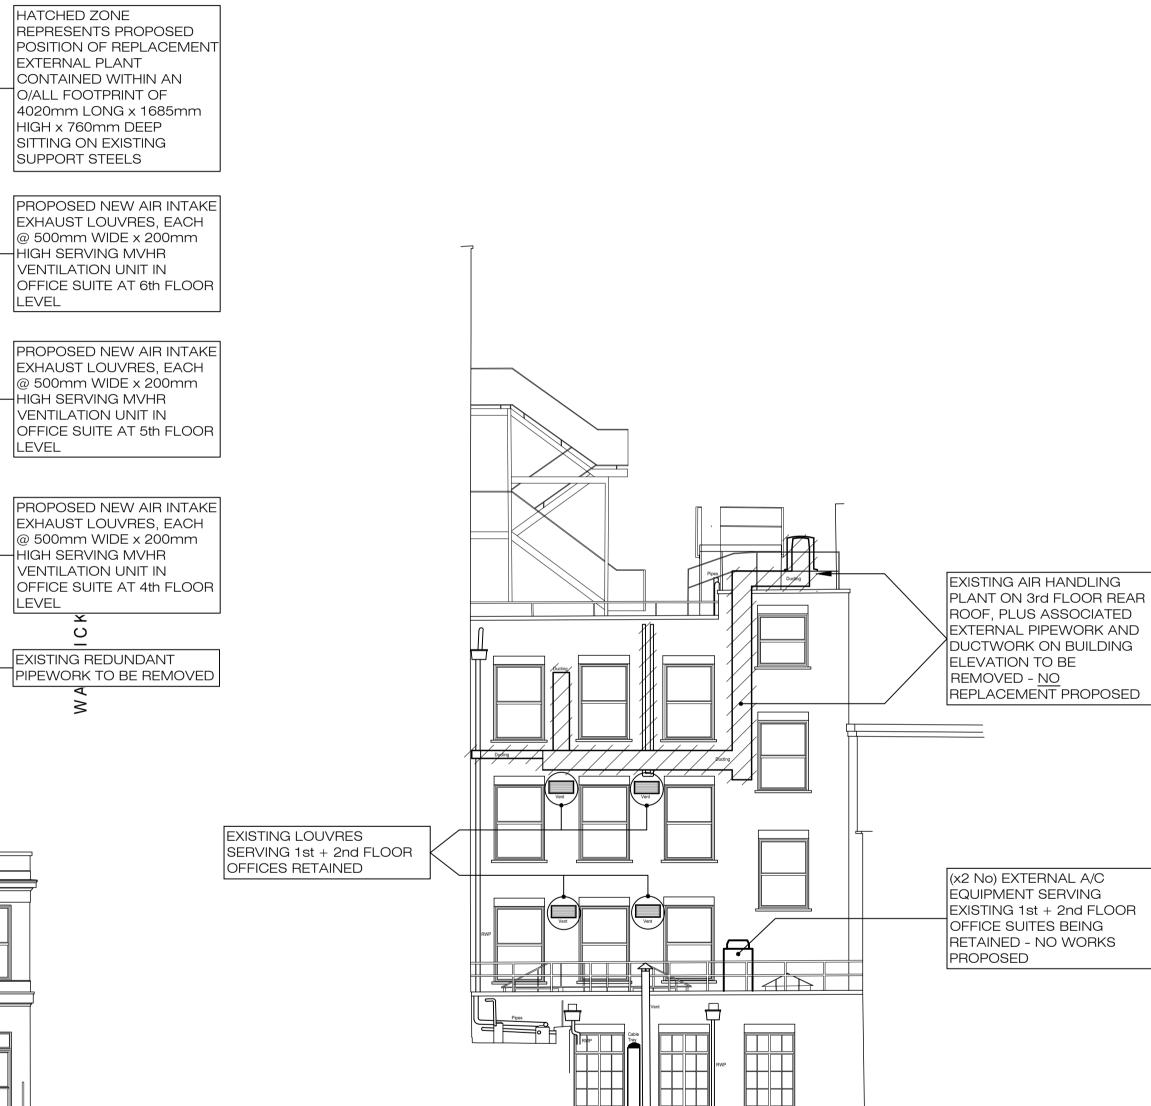

<u>LIGHTWELL ELEVATION</u>

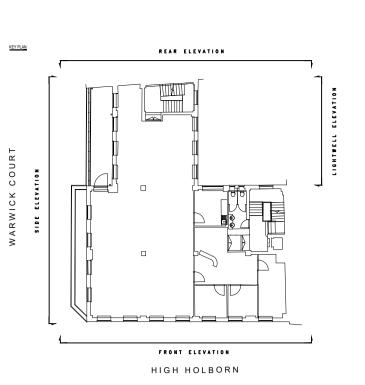

Project No:

Revision no:

Drawing No:

D6146	PA.06	_	
Title: Rear & Lightwell Elevation Plant Layout Propsed			
Notes:			
No:       Detail:         1.       DIMENSIONS Figured dimensions are to be taken in preference to scaled dimensions. All dimensions are to be verified on site prior to work commencing.         2.       DISCREPANCIES Any discrepancy is to be referred to the consultant before proceeding.			
<ol> <li><u>COPYRIGHT ©_2022</u></li> <li>Copyright in this drawing is the property of Michael Jones &amp; Associates LLP and must not be reproduced nor amended nor used for the execution of any woks whether in connection with the proposed works for which it is prepared or otherwise without the express consent of Michael Jones &amp; Associates LLP. All rights reserved.</li> </ol>			
4. <u>RELATED DOCUMENTS</u> This drawing shall be read in conjunction with the relevant written Specification of Works, accompanying drawings equipment schedules and all other relevant documents connected to those works shown on this drawing.			
A Sept 2022 Planning A	pplication		
-     Aug 2022     Planning A       No:     Date:     Amendment	2022       No:     Date:       Amendment:		
Revision:			
ichael Jones & Associates LLP NGINEERING CONSULTANTS Crossway House 8 London Road, Reigate, Surrey, RH2 9HY. Tel: +44(0)1737 245610 Fax: +44(0)1737 241142 e.mail: info@mjassociates.co.uk www.mjassociates.co.uk			
Scale: 1:100@A1 Date: Aug 2022 Drawn: EF MJA			
<sup>Client:</sup> ACAI (Swan Ho	Client: ACAI (Swan House) Ltd		
Project: Swan House 37-39 High Holborn London WC1V 6AA			
Title: <u>Rear &amp; Lightwell Elevation</u> Plant Layout Proposed			
Project No:	Drawing No:	Revision No:	
D6146	PA.06	-	