


**Location Plan** Scale 1:1250



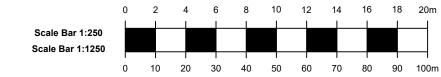

#### GENERAL NOTES

1. Dimensions should not be scaled from the drawings where accuracy is essential.

2. Details dimensions and levels to be checked on site by builder prior to commencement of works. Any works commenced prior to all necessary local authority approvals are entirely at the risk of the owner & builder.

3. Structural details are subject to exposure of existing construction and verification by L.A Surveyor and any necessary revised details are to be agreed with the L.A Surveyor prior to carrying out the affected works.

4. All materials are to be used in accordance with the manufacturers' guidelines and all relevant British Standards Codes of Practice & Regulation 7 of Building Regs.

5. All works are to be carried out in accordance with Local Authority requirements.

6. The intended works fall within the Party Wall Act 1996 and any adjoining owners affected must be notified prior to commencement of any works.

7. Thames Water Authority permission to be obtained if building over or adjacent to sewers within 3 metres.( Tel: 08459 200 800)

8. No part of the extension to project into adjoining boundary lines.



Lyondale Planning & Design Crown House Homesdale Gardens Dartford, Kent, DA1 1DZ 0800 677 1999

Client:	Tasty Africa
---------	--------------

Project: 11 Frognal Parade NW3 5HH

Title:

Proposed Extraction System for A3 Restaurant/Cafes


**Drawn: Location Plan** 


Drawing No.: Y562/2020/01

Scale: 1:1250 & A3

Date: 22 June 2021

20m

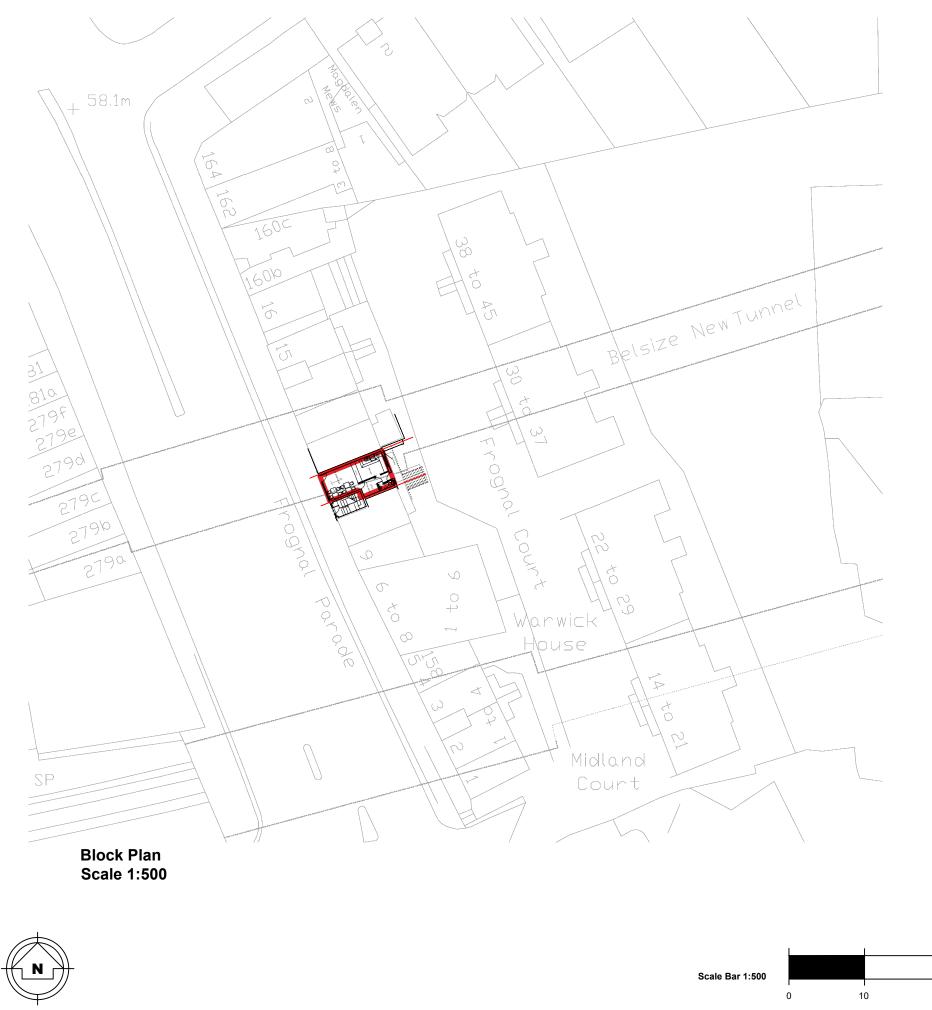

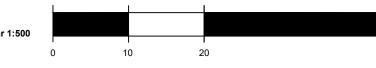

#### GENERAL NOTES

1. Dimensions should not be scaled from the drawings where accuracy is essential.

2. Details dimensions and levels to be checked on site by builder prior to commencement of works. Any works commenced prior to all necessary local authority approvals are entirely at the risk of the owner & builder.

3. Structural details are subject to exposure of existing construction and verification by L.A Surveyor and any necessary revised details are to be agreed with the L.A Surveyor prior to carrying out the affected works.

4. All materials are to be used in accordance with the manufacturers' guidelines and all relevant British Standards Codes of Practice & Regulation 7 of Building Regs.

5. All works are to be carried out in accordance with Local Authority requirements.

6. The intended works fall within the Party Wall Act 1996 and any adjoining owners affected must be notified prior to commencement of any works.

7. Thames Water Authority permission to be obtained if building over or adjacent to sewers within 3 metres.( Tel: 08459 200 800)

8. No part of the extension to project into adjoining boundary lines.



Lyondale Planning & Design Crown House Homesdale Gardens Dartford, Kent, DA1 1DZ 0800 677 1999

Tasty Africa Client:

Project: 11 Frognal Parade NW3 5HH

Title:

Proposed Extraction System for A3 **Restaurant/Cafes** 


Drawn: Block Plan

Drawing No.: Y562/2020/02

Scale: 1:500 & A3

Date: 22 June 2021

50

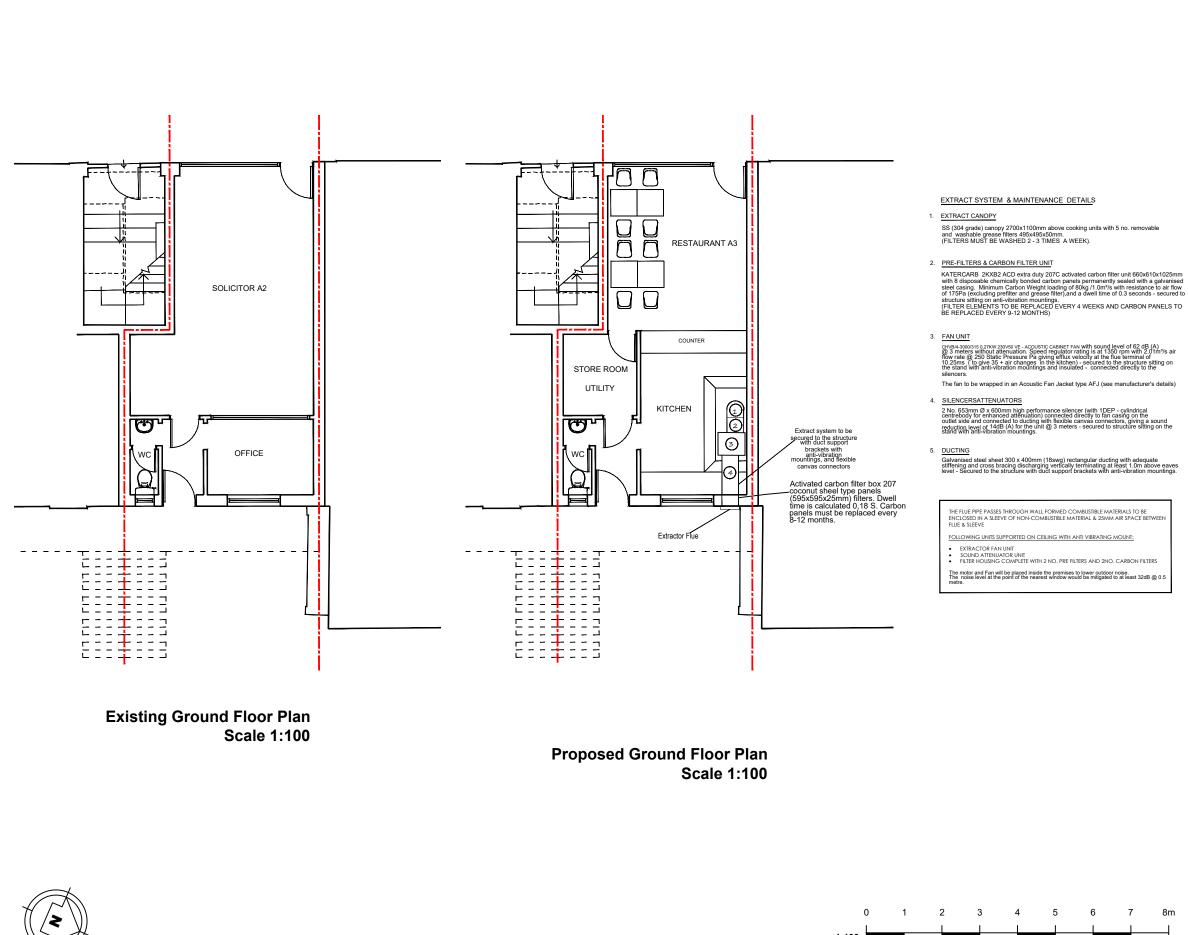

1:100 1:200 8 12

Ο 4

#### GENERAL NOTES

1. Dimensions should not be scaled from the drawings where accuracy is essential.

2. Details dimensions and levels to be checked on site by builder prior to commencement of works. Any works commenced prior to all necessary local authority approvals are entirely at the risk of the owner & builder.

3. Structural details are subject to exposure of existing construction and verification by L.A Surveyor and any necessary revised details are to be agreed with the L.A Surveyor prior to carrying out the affected works.

4. All materials are to be used in accordance with the manufacturers' guidelines and all relevant British Standards Codes of Practice & Regulation 7 of Building Regs.

5. All works are to be carried out in accordance with Local Authority requirements.

6. The intended works fall within the Party Wall Act 1996 and any adjoining owners affected must be notified prior to commencement of any works.

7. Thames Water Authority permission to be obtained if building over or adjacent to sewers within 3 metres.( Tel: 08459 200 800)

8. No part of the extension to project into adjoining boundary lines.



Lyondale Planning & Design **Crown House** Homesdale Gardens Dartford, Kent, DA1 1DZ 0800 677 1999

Client:	Tasty	Africa

Project: 11 Frognal Parade NW3 5HH

Title:


**Proposed Extraction System for A3 Restaurant/Cafes** 


Drawn. Gro	ound Floor Plans and Extractor stem Details
Sv:	stem Details
-	o.: Y562/2020/03

Scale: 1:200 & A3


Date: 22 June 2021

16m

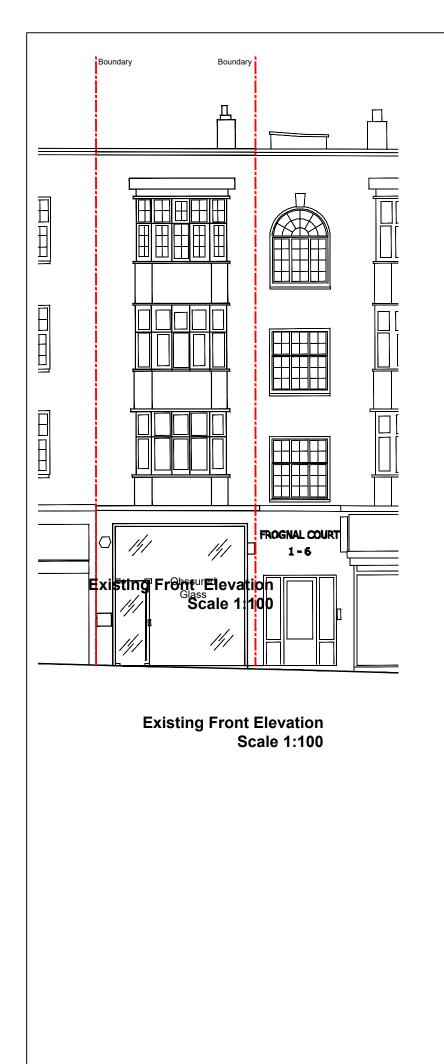

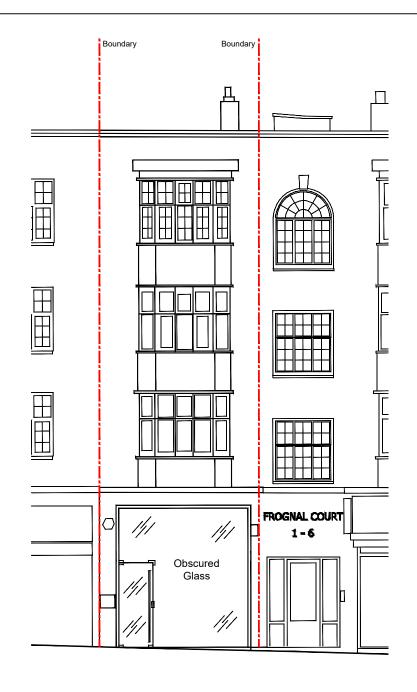

Proposed Front Elevation Scale 1:100

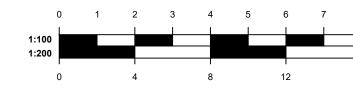

## GENERAL NOTES

1. Dimensions should not be scaled from the drawings where accuracy is essential.

2. Details dimensions and levels to be checked on site by builder prior to commencement of works. Any works commenced prior to all necessary local authority approvals are entirely at the risk of the owner & builder.

3. Structural details are subject to exposure of existing construction and verification by L.A Surveyor and any necessary revised details are to be agreed with the L.A Surveyor prior to carrying out the affected works.

4. All materials are to be used in accordance with the manufacturers' guidelines and all relevant British Standards Codes of Practice & Regulation 7 of Building Regs.

5. All works are to be carried out in accordance with Local Authority requirements.

6. The intended works fall within the Party Wall Act 1996 and any adjoining owners affected must be notified prior to commencement of any works.

7. Thames Water Authority permission to be obtained if building over or adjacent to sewers within 3 metres.( Tel: 08459 200 800)

8. No part of the extension to project into adjoining boundary lines.



Lyondale Planning & Design Crown House Homesdale Gardens Dartford, Kent, DA1 1DZ 0800 677 1999

Client: Tasty Africa

Project: 11 Frognal Parade NW3 5HH

Title:

Proposed Extraction System for A3 Restaurant/Cafes

Drawn: Front Elevations

Drawing No.: Y562/2020/04


Scale: 1:100 & A3

16m


Date: 22 June 2021



**Existing Rear Elevation** Scale 1:100

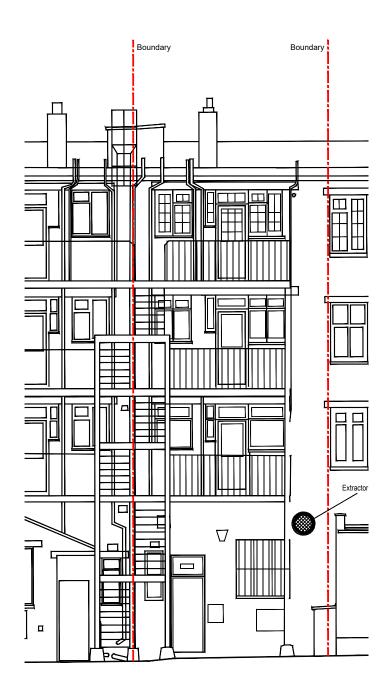

**Proposed Rear Elevation** Scale 1:100

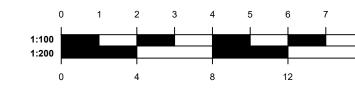

#### GENERAL NOTES

1. Dimensions should not be scaled from the drawings where accuracy is essential.

2. Details dimensions and levels to be checked on site by builder prior to commencement of works. Any works commenced prior to all necessary local authority approvals are entirely at the risk of the owner & builder.

3. Structural details are subject to exposure of existing construction and verification by L.A Surveyor and any necessary revised details are to be agreed with the L.A Surveyor prior to carrying out the affected works.

4. All materials are to be used in accordance with the manufacturers' guidelines and all relevant British Standards Codes of Practice & Regulation 7 of Building Regs.

5. All works are to be carried out in accordance with Local Authority requirements.

6. The intended works fall within the Party Wall Act 1996 and any adjoining owners affected must be notified prior to commencement of any works.

7. Thames Water Authority permission to be obtained if building over or adjacent to sewers within 3 metres.( Tel: 08459 200 800)

8. No part of the extension to project into adjoining boundary lines.



Lyondale Planning & Design Crown House Homesdale Gardens Dartford, Kent, DA1 1DZ 0800 677 1999

Client: Tasty Africa

Project: 11 Frognal Parade NW3 5HH

Title:

**Proposed Extraction System for A3** Restaurant/Cafes


**Drawn: Rear Elevations** 


Drawing No.: Y562/2020/05

Scale: 1:100 & A3


16m

Date: 22 June 2021

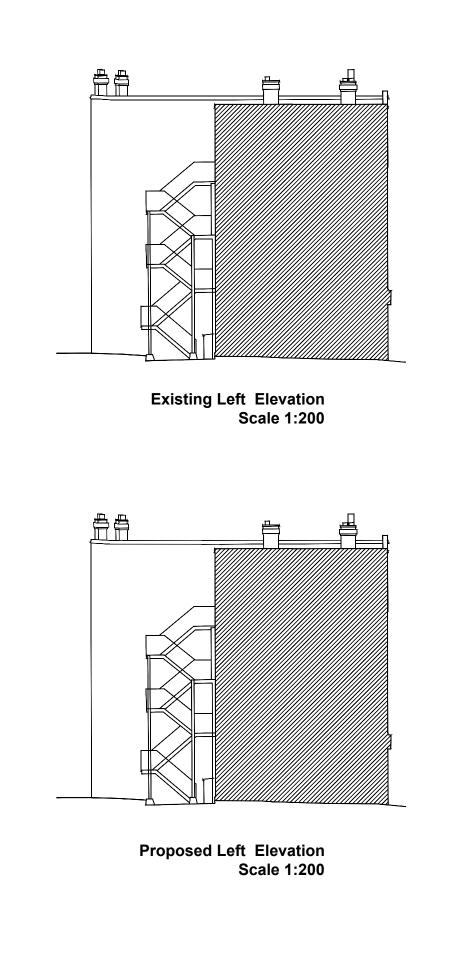


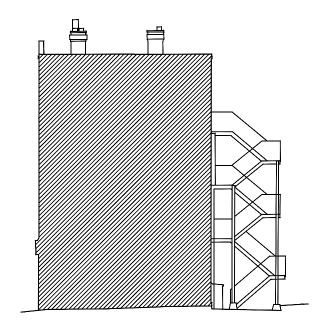

Existing Right Elevation Scale 1:200

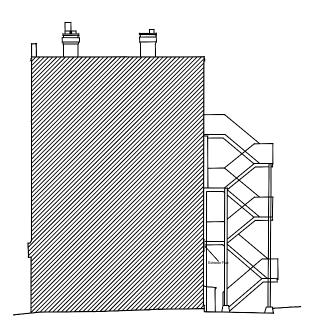

Proposed Right Elevation Scale 1:200

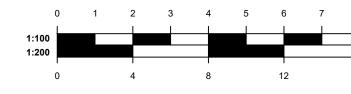

#### GENERAL NOTES

1. Dimensions should not be scaled from the drawings where accuracy is essential.

2. Details dimensions and levels to be checked on site by builder prior to commencement of works. Any works commenced prior to all necessary local authority approvals are entirely at the risk of the owner & builder.

3. Structural details are subject to exposure of existing construction and verification by L.A Surveyor and any necessary revised details are to be agreed with the L.A Surveyor prior to carrying out the affected works.

4. All materials are to be used in accordance with the manufacturers' guidelines and all relevant British Standards Codes of Practice & Regulation 7 of Building Regs.

5. All works are to be carried out in accordance with Local Authority requirements.

6. The intended works fall within the Party Wall Act 1996 and any adjoining owners affected must be notified prior to commencement of any works.

7. Thames Water Authority permission to be obtained if building over or adjacent to sewers within 3 metres.( Tel: 08459 200 800)

8. No part of the extension to project into adjoining boundary lines.



Lyondale Planning & Design Crown House Homesdale Gardens Dartford, Kent, DA1 1DZ 0800 677 1999

Client: Tasty Africa

Project: 11 Frognal Parade NW3 5HH

Title:

Proposed Extraction System for A3 Restaurant/Cafes

Drawn: Side Elevations

Drawing No.: Y562/2020/06

Scale: 1:200 & A3

16m

Date: 22 June 2021



# **CHVB/CHVT**




# 5148139200 - CHVB/4-3000/315 0,27KW 230V50 VE - ACOUSTIC CABINET FANS

Cabinet fan for air stream temperature up to 120°C. Certified F400 120 for smoke extraction in fire conditions. Manufactured from galvanised sheet steel, with double panel (sandwich type) internally line with 25 mm thickness fireproof fibre-glass acoustic insulation (M0). Direct drive backward curved centrifugal impeller with motor fitted outside of the air stream. Motors are single phase or three phase IP55 with thermal protection. S&P model CHVB/4-3000/315 0,27KW 230V50 VE


#### 5148139200 - CHVB/4-3000/315 0,27KW 230V50 VE


Theoretical Working Point	
9	
Airflow	-
Static Pressure	0,000 Pa
Temperature	20 °C
Altitude	0 m
Density	1,2 kg/m³
Frequency	50 Hz
Construction	
Discharge diameter	315 mm
Fan size	315
Weight	46,00 kg
Motor Characteristics	
Number of poles	4
Voltage	1-230V-50Hz
Maximum absorbed current	1,3 A
IP Rating	IP55
Motor insulation class	

# Drawing

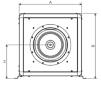




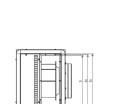

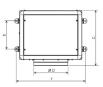

A	В	с	D	E	F	н	а	al
	573							118
a2	a3	b	b2	b3				
162	183	429	441	463				

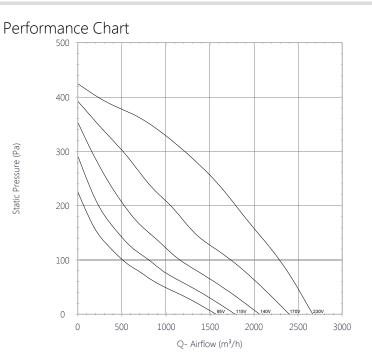


# Sound Performance

63	125	250	500	1k	2k	4k	8k	Overall
44	63	67	67	69	68	63	60	75
33	52	56	56	58	57	52	49	64
42	62	67	68	69	69	63	60	75
31	51	56	57	58	58	52	49	64
	•	•			•		•	
37	56	60	55	55	55	54	48	64
26	45	49	44	44	44	43	37	53
	44 33 42 31 37 26	44         63           33         52           42         62           31         51           37         56           26         45	1         1           44         63         67           33         52         56           42         62         67           31         51         56           7         56         60           26         45         49	1         1         1         1           44         63         67         67           33         52         56         56           42         62         67         68           31         51         56         57           37         56         60         55           26         45         49         44	1         1 <th1< th=""> <th1< th=""> <th1< th=""> <th1< th=""></th1<></th1<></th1<></th1<>	1         1         1         1         1           44         63         67         67         69         68           33         52         56         56         58         57           42         62         67         68         69         69           31         51         56         57         58         58           37         56         60         55         55         55           26         45         49         44         44	110         110         110         110         110           44         63         67         67         69         68         63           33         52         56         56         58         57         52           42         62         67         68         69         69         63           31         51         56         57         58         58         52           37         56         60         55         55         54           26         45         49         44         44         43	44         63         67         67         69         68         63         60           33         52         56         56         58         57         52         49           42         62         67         68         69         69         63         60           31         51         56         57         58         58         52         49           42         62         67         68         69         69         63         60           31         51         56         57         58         58         52         49           44         51         56         57         58         58         52         49









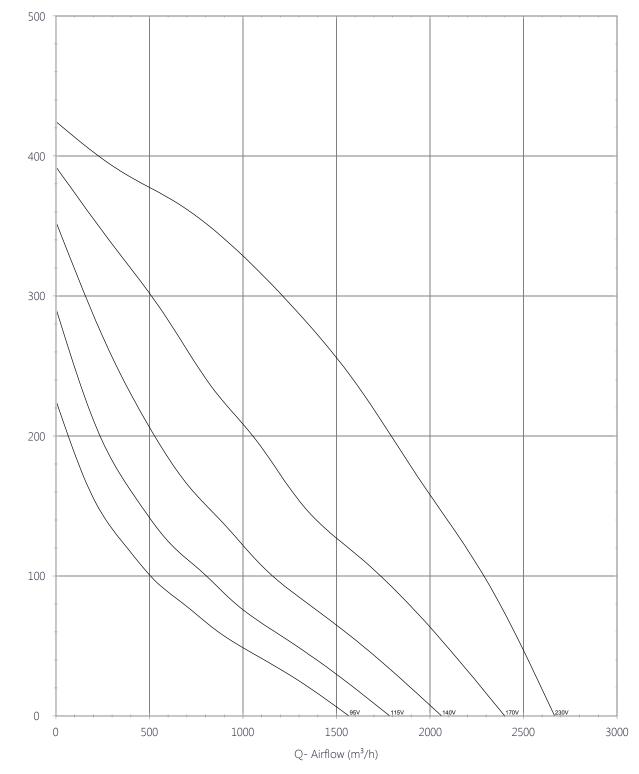

Static Pressure (Pa)

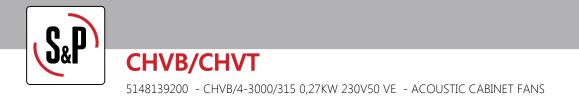

# Drawing

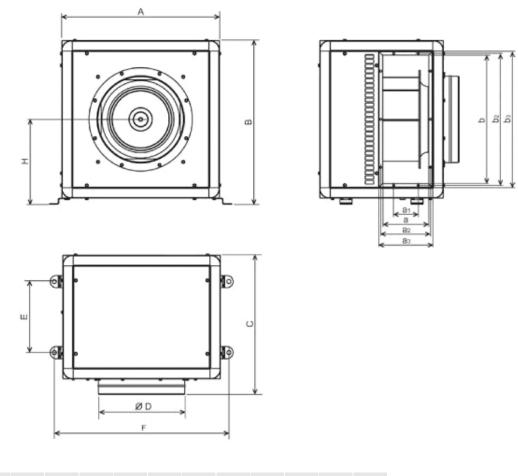

A	В	с	D	E	F	н	а	a1	a2	a3	b	b2	b3
548	573	527	315	247	618	299	149	118	162	183	429	441	463




# Accessories

5416740700 - FD-3000




# DISCHARGE FLANGE

5130861700 - KSE-45

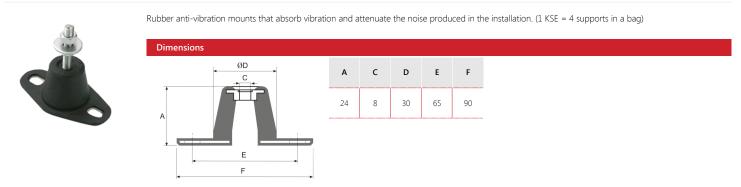


# 5416763100 - CTI CHV-3000

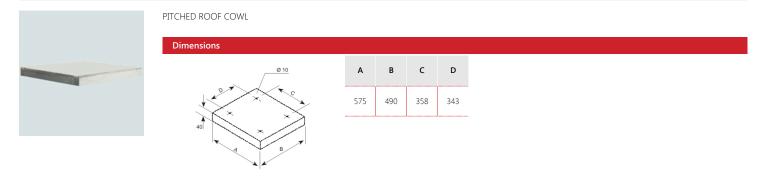




#### 5402032800 - ACOP RECT F400-3000

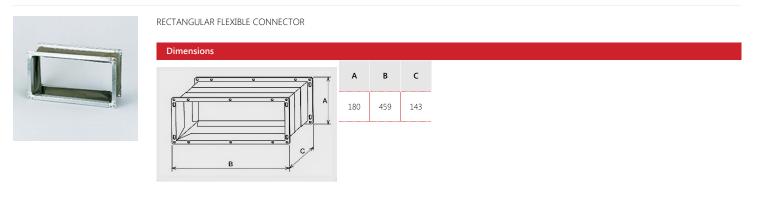

## 5138920900 - ACOPEL F400-315/160 N

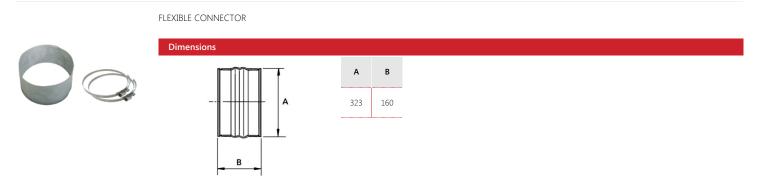

**CHVB/CHVT** 5148139200 - CHVB/4-3000/315 0,27KW 230V50 VE - ACOUSTIC CABINET FANS

	63	125	250	500	1k	2k	4k	8k	Overall
Inlet (LwA)	44	63	67	67	69	68	63	60	75
Inlet LpA @ 1m	33	52	56	56	58	57	52	49	64
Outlet (LwA)	42	62	67	68	69	69	63	60	75
Outlet LpA @ 1m	31	51	56	57	58	58	52	49	64
		L	L	L		L	L		L
Breakout (LwA)	37	56	60	55	55	55	54	48	64
Breakout LpA @ 1m	26	45	49	44	44	44	43	37	53

# Sound Performance

