

# SQUIRE & PARTNERS

# Space House

# Non Material Amendment Document

For Seaforth Land

July 2022

# Document History

Rev	Date	Purpose of Issue	Author	Reviewer
А	22.07.22	Non Material Amendment	MPa	CW

# Contents

- 1.0 Executive summary
- 2.0 Demolition scope update
- 3.0 Appendices

# 1.0 Executive Summary

The document has been prepared to support an application for nonmaterial amendments to planning permission ref: 2022/2170/P and listed building consent ref: 2022/2134/L at Space House ('the site'). This document provides an update to the demolition scope approved at the site under planning permission (ref. 2021/1058/P) as amended by non-material amendment (ref: 2022/0751/P) approved on 5 April 2022, and by non-material amendment (ref. 2022/2170/P) approved on 28 June 2022, and Listed Building Consent (ref: 2022/2134), also approved on 28 June 2022.

This document provides an update to the consented demolition scope to the Section 73 (ref. 2021/1058/P) as amended by non-material amendment (ref: 2022/0751/P) and Section 19 (ref. 2022/0740/L) permissions, approved on 5 April 2022, and by non-material amendment (ref. 2022/2170/P) and Section 19 (ref. 2022/2134/L) permissions, approved on 28 June 2022 at Space House.

This application covers the following non-material amendments to the demolition scope: a) Kingsway loading bay wall and b) the Kingsway stair. This was presented to and discussed with Camden planning and design officers in the monthly Post-application agreement (PAA) meeting held on the 13th July 2022.

Camden planning and design officers indicated during the meeting that the changes were acceptable and could be sought via a non material amendment and Section 19 application.

# 2.0 Demolition scope update

## 2.1 Kingsway block loading bay brickwork wall

Fig. 2.1.1 and 2.1.2 reflect the demolition scope consented under the Non Material Amendment (ref. 2022/0751/P) and Section 19 (ref. 2022/0740/L) permissions at Space House.

Upon strip out of the area, the consented lift shaft wall is located closer to the facade than anticipated. In order to construct the consented lift shaft, the existing brickwork facade (GF1.1 on Fig 2.1.3) is required to be demolished to allow for formwork of the concrete lift shaft.

The existing brickwork wall is formed by 2no. layers of brickwork. It is evident (once stripped back) that the inner face of this wall is in poor condition; made of patchwork of brickwork and blockwork and structurally precarious. For this reason, the structural engineer recommends that this wall is rebuilt entirely.

GFI.1 - The proposal is to is to remove this brickwork facade and rebuild it in the same place using the existing brickwork.

The planning officers requested details for the methodology of removal of bricks to the area to ensure that the amount of brickwork to be reinstated could be maximised. The main contractor methodology is highlighted in page 7.

See Fig. 2.1.3 for additional demolition location.


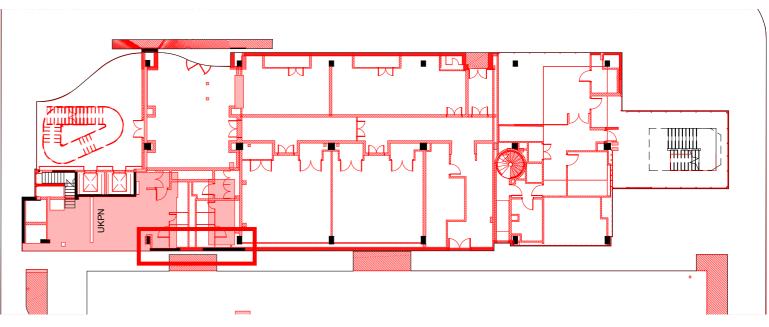



Fig. 2.1.1 Consented Ground Floor Plan - Loading Bay Wall Location

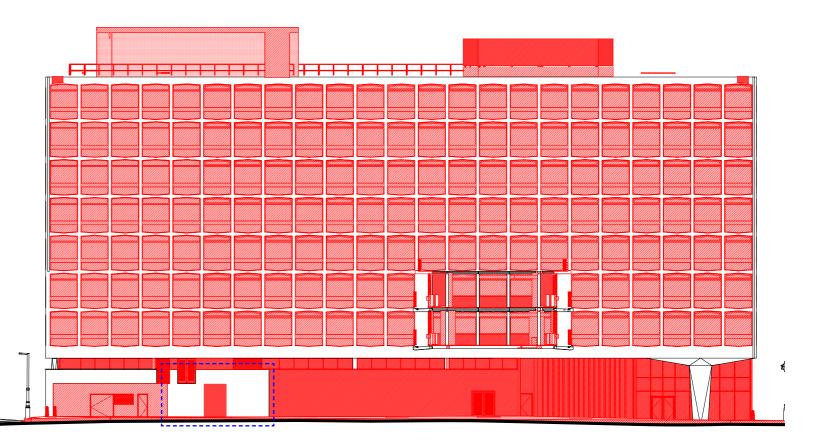


Legend:

Consented demolition

Fig. 2.1.2 Consented West Elevation

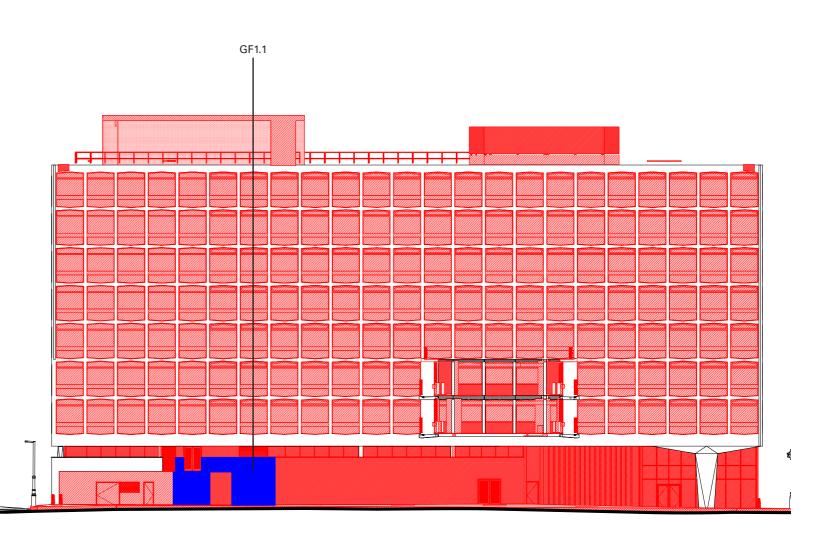

### Legend:

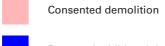

Proposed additional demolition

Fig. 2.1.3 Proposed Amendments to Consented Elevation

## **Removal and Reinstatement of Listed Brick Facework Methodology**

## Preparation

Prior to removal, the existing wall will be photographed to record condition. The brick gauge, coursing and bed joint measurement will be recorded. The quantity of bricks available and the number needed for rebuilding will be calculated to allow monitoring of the methodology. A sample of the existing brickwork will be taken for matching to allow replacement in the event of a shortfall reclamation. Brick matches will be presented for agreement with the Architect and Camden Planning. A mortar match will be established with the existing brickwork.

### <u>Removal</u>

Once preparation is complete, hand removal of existing cavity brickwork will commence utilising external scaffold. The external facework wall and the internal skin will be carefully taken down simultaneously, course by course working from the top down.

Removal will be undertaken using small hand drills together with hammer & bolster to save as many face bricks as possible.

Bricks will be cleaned of old mortar with a hammer and bolster as removal progresses. Cleaned bricks will be stacked neatly on pallets and wrapped in film. Pallets of reclaimed face brickwork will be stored on the ground floor in a designated position where they should not require moving until we are ready to rebuild. Inner skin (non face) bricks will not be retained and will be disposed of.

A check of salvaged brick quantity will be undertaken against the requirements for rebuild to confirm any replacement quantity.

## **Rebuilding**

The brickwork will be rebuilt to approved details utilising the record photographs recorded before removal. All work will be undertaken by trained competent bricklayers.

Face brickwork will be drawn and mixed from the pallets of existing bricks. Where any new replacement bricks are to be required these will be mixed with the existing before laying to avoid patch appearance.

A new internal skin will be constructed following the project specifications. Both skins will be constructed in parallel to ensure stability and consistency of tying.

Record photographs will be taken to document the works and record the history of the building. Upon completion the wall will be offered for final sign off by Architect and Camden Planning.



Fig. 2.1.4 Existing Wall External View

GF1.1



Fig. 2.1.5 Existing Wall External View - Proposed additional demolition

### Legend:



Consented demolition

Proposed additional demolition




Fig. 2.1.6 Existing Wall Internal View



GF1.1 -

Fig. 2.1.7 Existing Wall internal View - Proposed additional demolition

Legend:

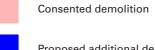

Proposed additional demolition

### 2.2 Kingsway block stair support level 7/8

Fig. 2.2.1 represents the demolition scope consented under to the Non Material Amendment (ref. 2022/0751/P) and Section 19 (ref. 2022/0740/L) permissions at Space House.

L7.1 - Existing blockwork wall to be removed to allow for new steelwork to support the consented stair. New wall to be rebuilt in the same location of the existing wall. This wall separates the service riser and the existing stairwell. The wall on the stairwell side will be finished to match existing.

See Fig. 2.2.2 and 2.2.3 for additional demolition location.


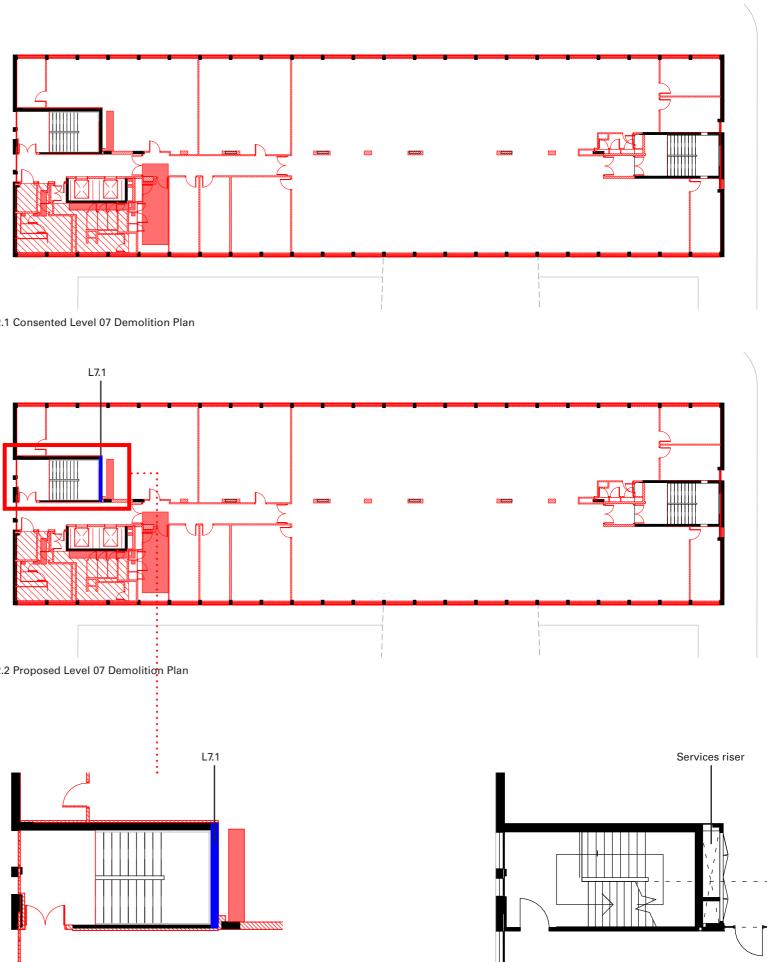


Fig. 2.2.1 Consented Level 07 Demolition Plan





### Legend:

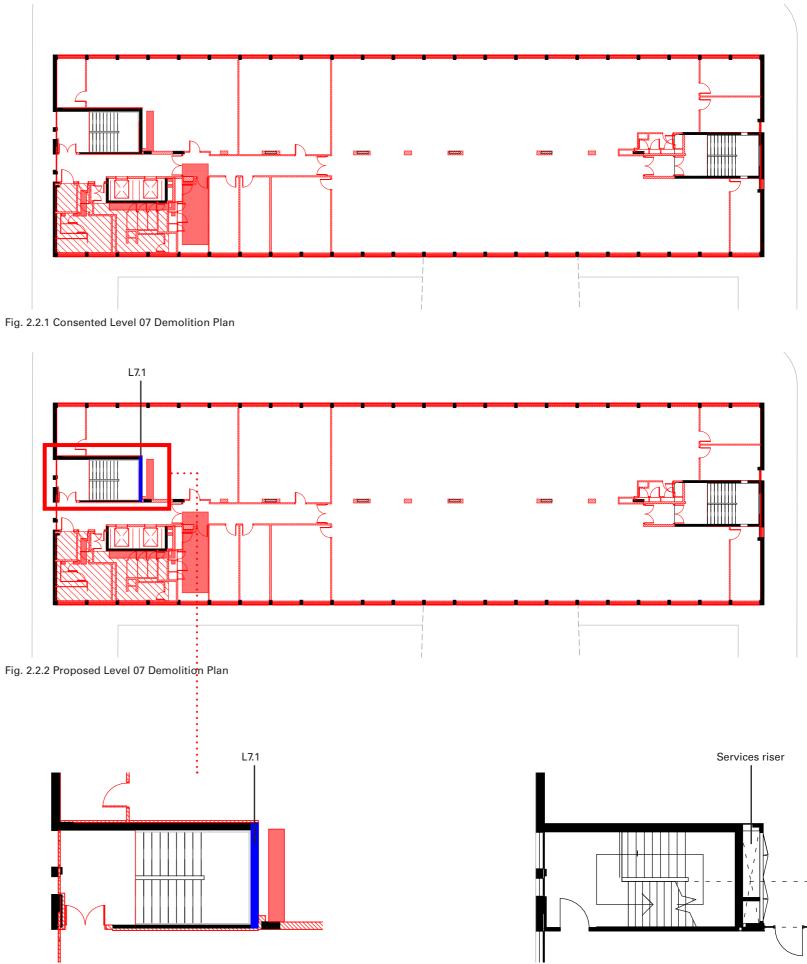



Proposed additional demolition

Fig. 2.2.4 Consented Level 07 Plan - Detail View

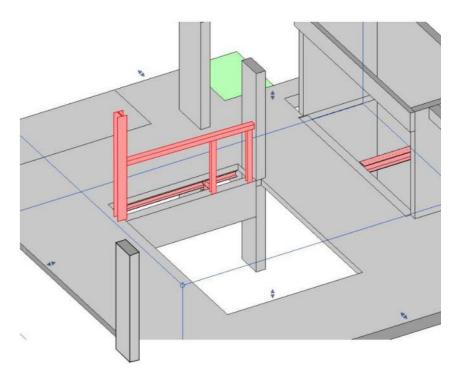

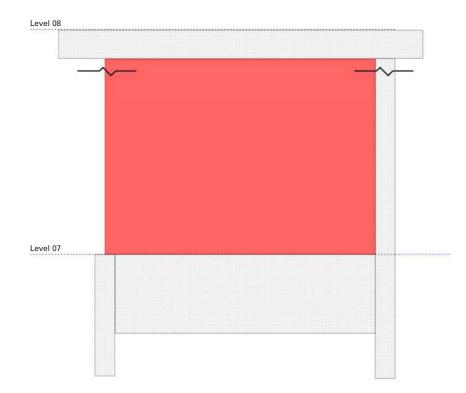

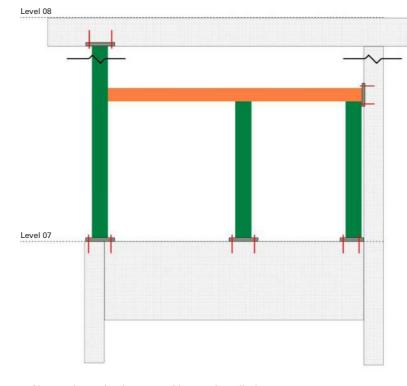

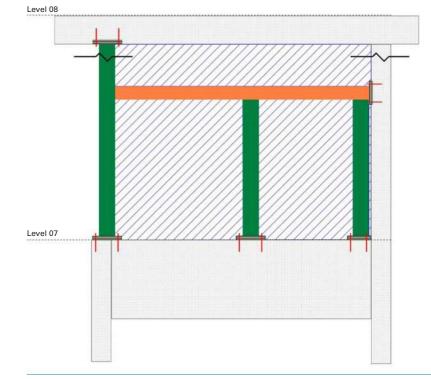

1. Demolition of existing wall

2. New stair steel columns and beams installation

Fig. 2.2.5 3D Illustration of proposed stair steel support

3. New blockwork wall infills installation


3.0 Appendices

Clean and bubbled demolition drawings

The list below sets out the revised drawings for which permission is sought to be reflected on the decision notices under this application.

# Drawing List

Number	Title	Rev
18077-SQP-01-ZZ-DE-A-PL01304	West Elevation Demolition	Rev E
18077-SQP-ZZ-07-DP-A-PL01012	Level 07 - Demolition Plan	Rev E

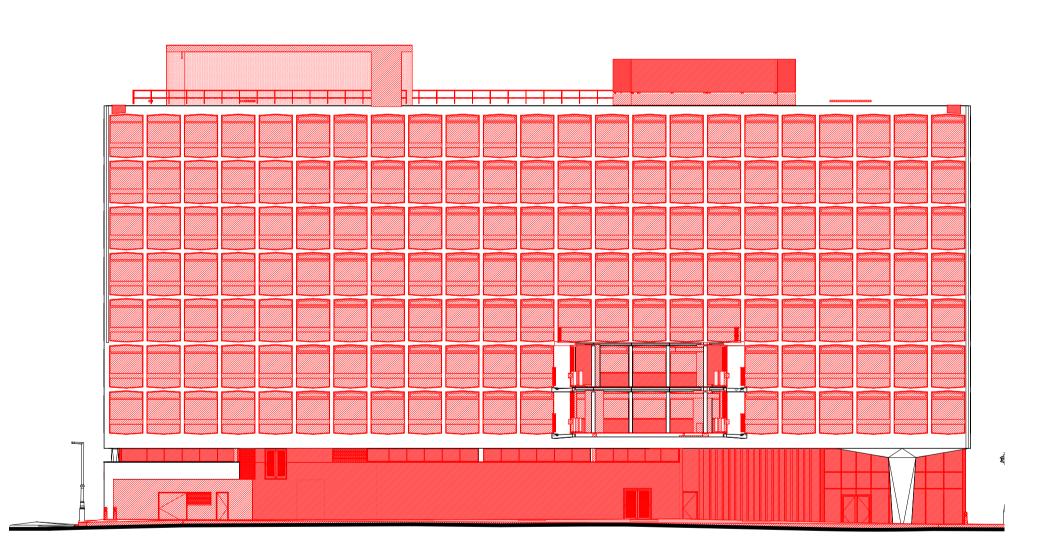


Scale 1:250

0 2.5 5 7.5 10 12.5



Do not scale from this drawing. All dimensions to be checked on site. All omissions and discrepancies to be reported to the Architect immediately

This work is copyright and shall not be reproduced or used for any other purpose without the written permission of Squire and Partners.

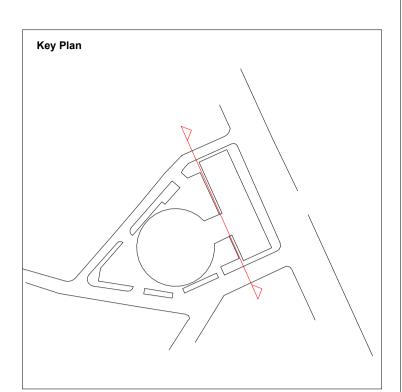

# Demolished Structural Elements Refer to structural engineers' drawings.

# Fabric to be demolished

\* Typical floor demolition is windows only
\* All floor finishes and raised floor to be removed.

Existing pre-cast concrete panels to be retained and reused for the new level 17 cap. Refer to Structural Engineer's drawings.

Description	Date	Chk	Rev
Planning Submission	24/05/19	SQP	A
Planning Substitution	20/09/19	SQP	В
Pre-Application Advice	08/07/20	SQP	С
Non-Material Amendment Issue	09/02/22	SQP	D
Non-Material Amendment Issue	22/07/22	SQP	E

# SQUIRE & PARTNERS

Squire and Partners LLP The Department Store 248 Ferndale Road, London SW9 8FR T: 020 7278 5555

info@squireandpartners.com www.squireandpartners.com


Pr	oje	ect

Space House London WC2

## \_\_\_\_\_ Title

West Elevation Demolition

Status				
Planning Submission				
Date	Scale @ ISO A1	Job Number		
24/05/19	1 : 250	18077		
Drawing Number		Revision		
18077-SQP-01-ZZ	-DE-A-PL01304	E		

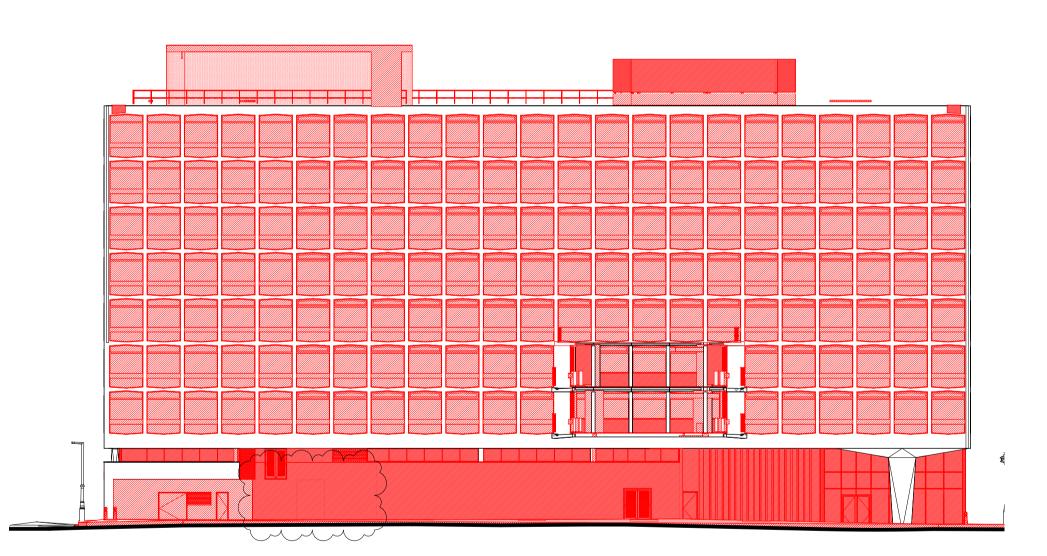


Scale 1:250

0 2.5 5 7.5 10 12.5



Do not scale from this drawing. All dimensions to be checked on site. All omissions and discrepancies to be reported to the Architect immediately

This work is copyright and shall not be reproduced or used for any other purpose without the written permission of Squire and Partners.

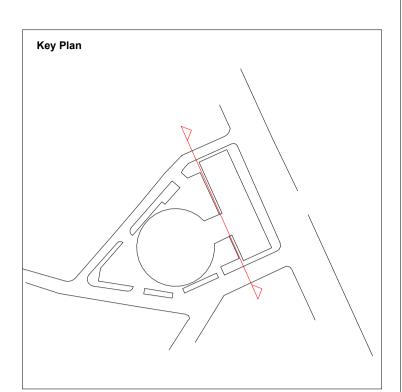

# Demolished Structural Elements Refer to structural engineers' drawings.

# Fabric to be demolished

\* Typical floor demolition is windows only
\* All floor finishes and raised floor to be removed.

Existing pre-cast concrete panels to be retained and reused for the new level 17 cap. Refer to Structural Engineer's drawings.

Description	Date	Chk	Rev
Planning Submission	24/05/19	SQP	A
Planning Substitution	20/09/19	SQP	В
Pre-Application Advice	08/07/20	SQP	С
Non-Material Amendment Issue	09/02/22	SQP	D
Non-Material Amendment Issue	22/07/22	SQP	E

# SQUIRE & PARTNERS

Squire and Partners LLP The Department Store 248 Ferndale Road, London SW9 8FR T: 020 7278 5555

info@squireandpartners.com www.squireandpartners.com


Pr	oje	ect


Space House London WC2

## \_\_\_\_\_ Title

West Elevation Demolition

Status				
Planning Submission				
Date	Scale @ ISO A1	Job Number		
24/05/19	1 : 250	18077		
Drawing Number		Revision		
18077-SQP-01-ZZ	-DE-A-PL01304	E		

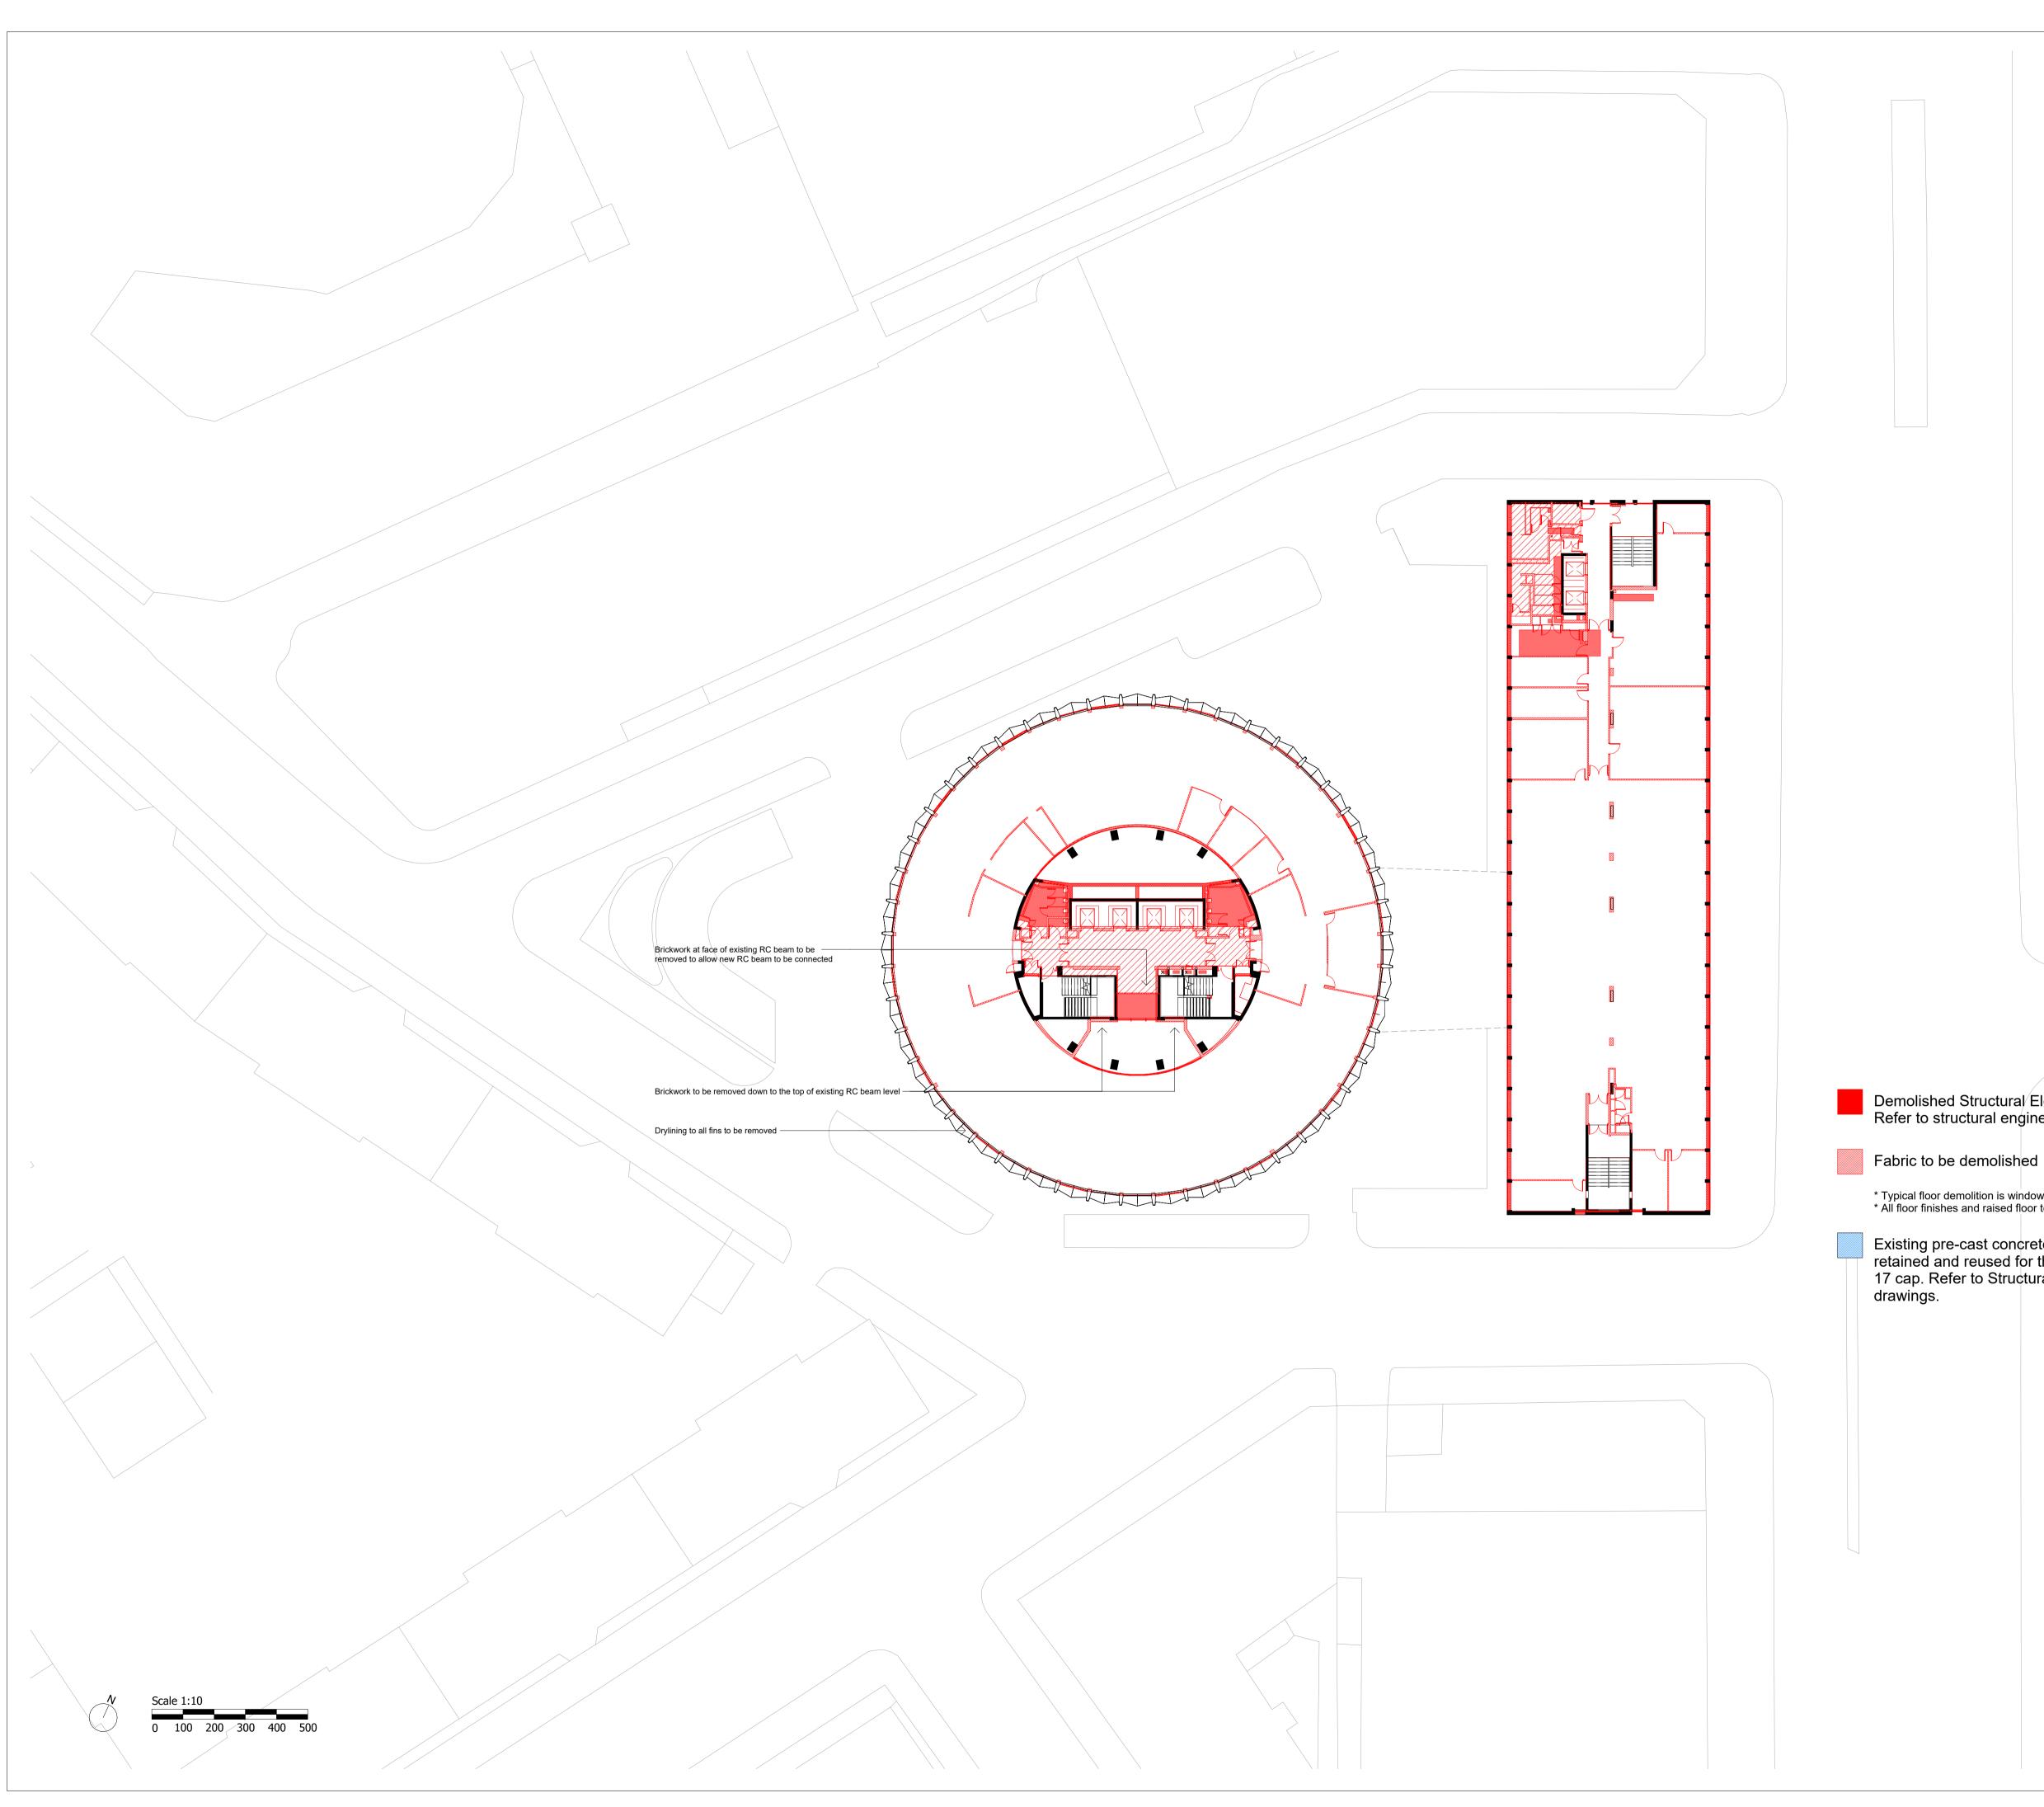

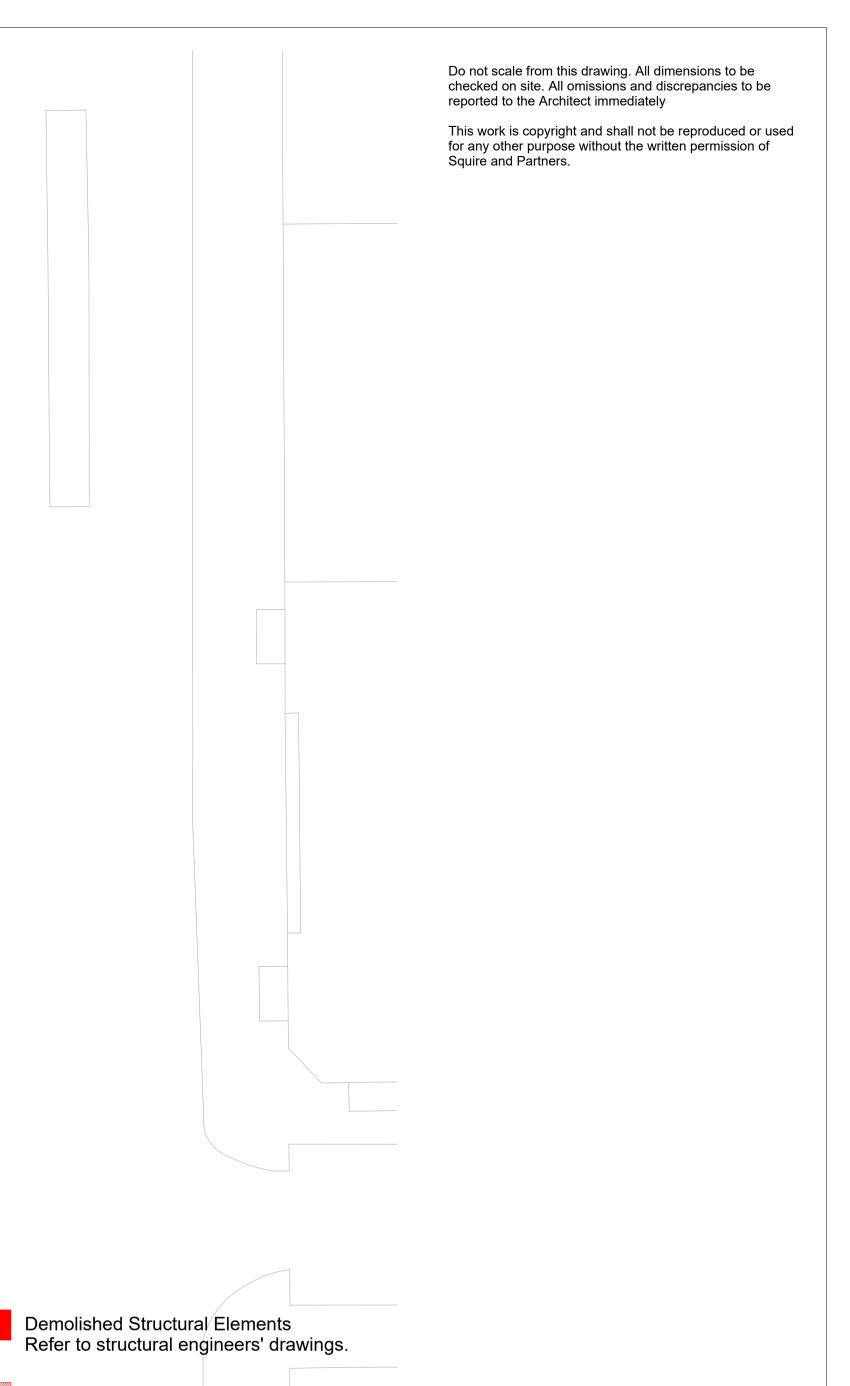

\* Typical floor demolition is windows only\* All floor finishes and raised floor to be removed.

Existing pre-cast concrete panels to be retained and reused for the new level 17 cap. Refer to Structural Engineer's drawings.

Non-Material Amendment Issue	22/07/22	SQP	E
Non-Material Amendment Issue	16/05/22	SQP	D
Non-Material Amendment Issue	09/02/22	SQP	С
Pre-Application Advice	08/07/20	SQP	В
Planning Submission	24/05/19	SQP	А
Description	Date	Chk	Rev

# SQUIRE & PARTNERS

Squire and Partners LLP The Department Store 248 Ferndale Road, London SW9 8FR T: 020 7278 5555

info@squireandpartners.com www.squireandpartners.com

Project	
Space House	

London WC2


# \_\_\_\_\_ Title


Level 07 **Demolition Plan** 

Status	
--------	--

Planning Submission				
Date	Scale @ ISO A1	Job Number		
24/05/19	1 : 250	18077		
Drawing Number		Revision		

18077-SQP-ZZ-07-DP-A-PL01012 E

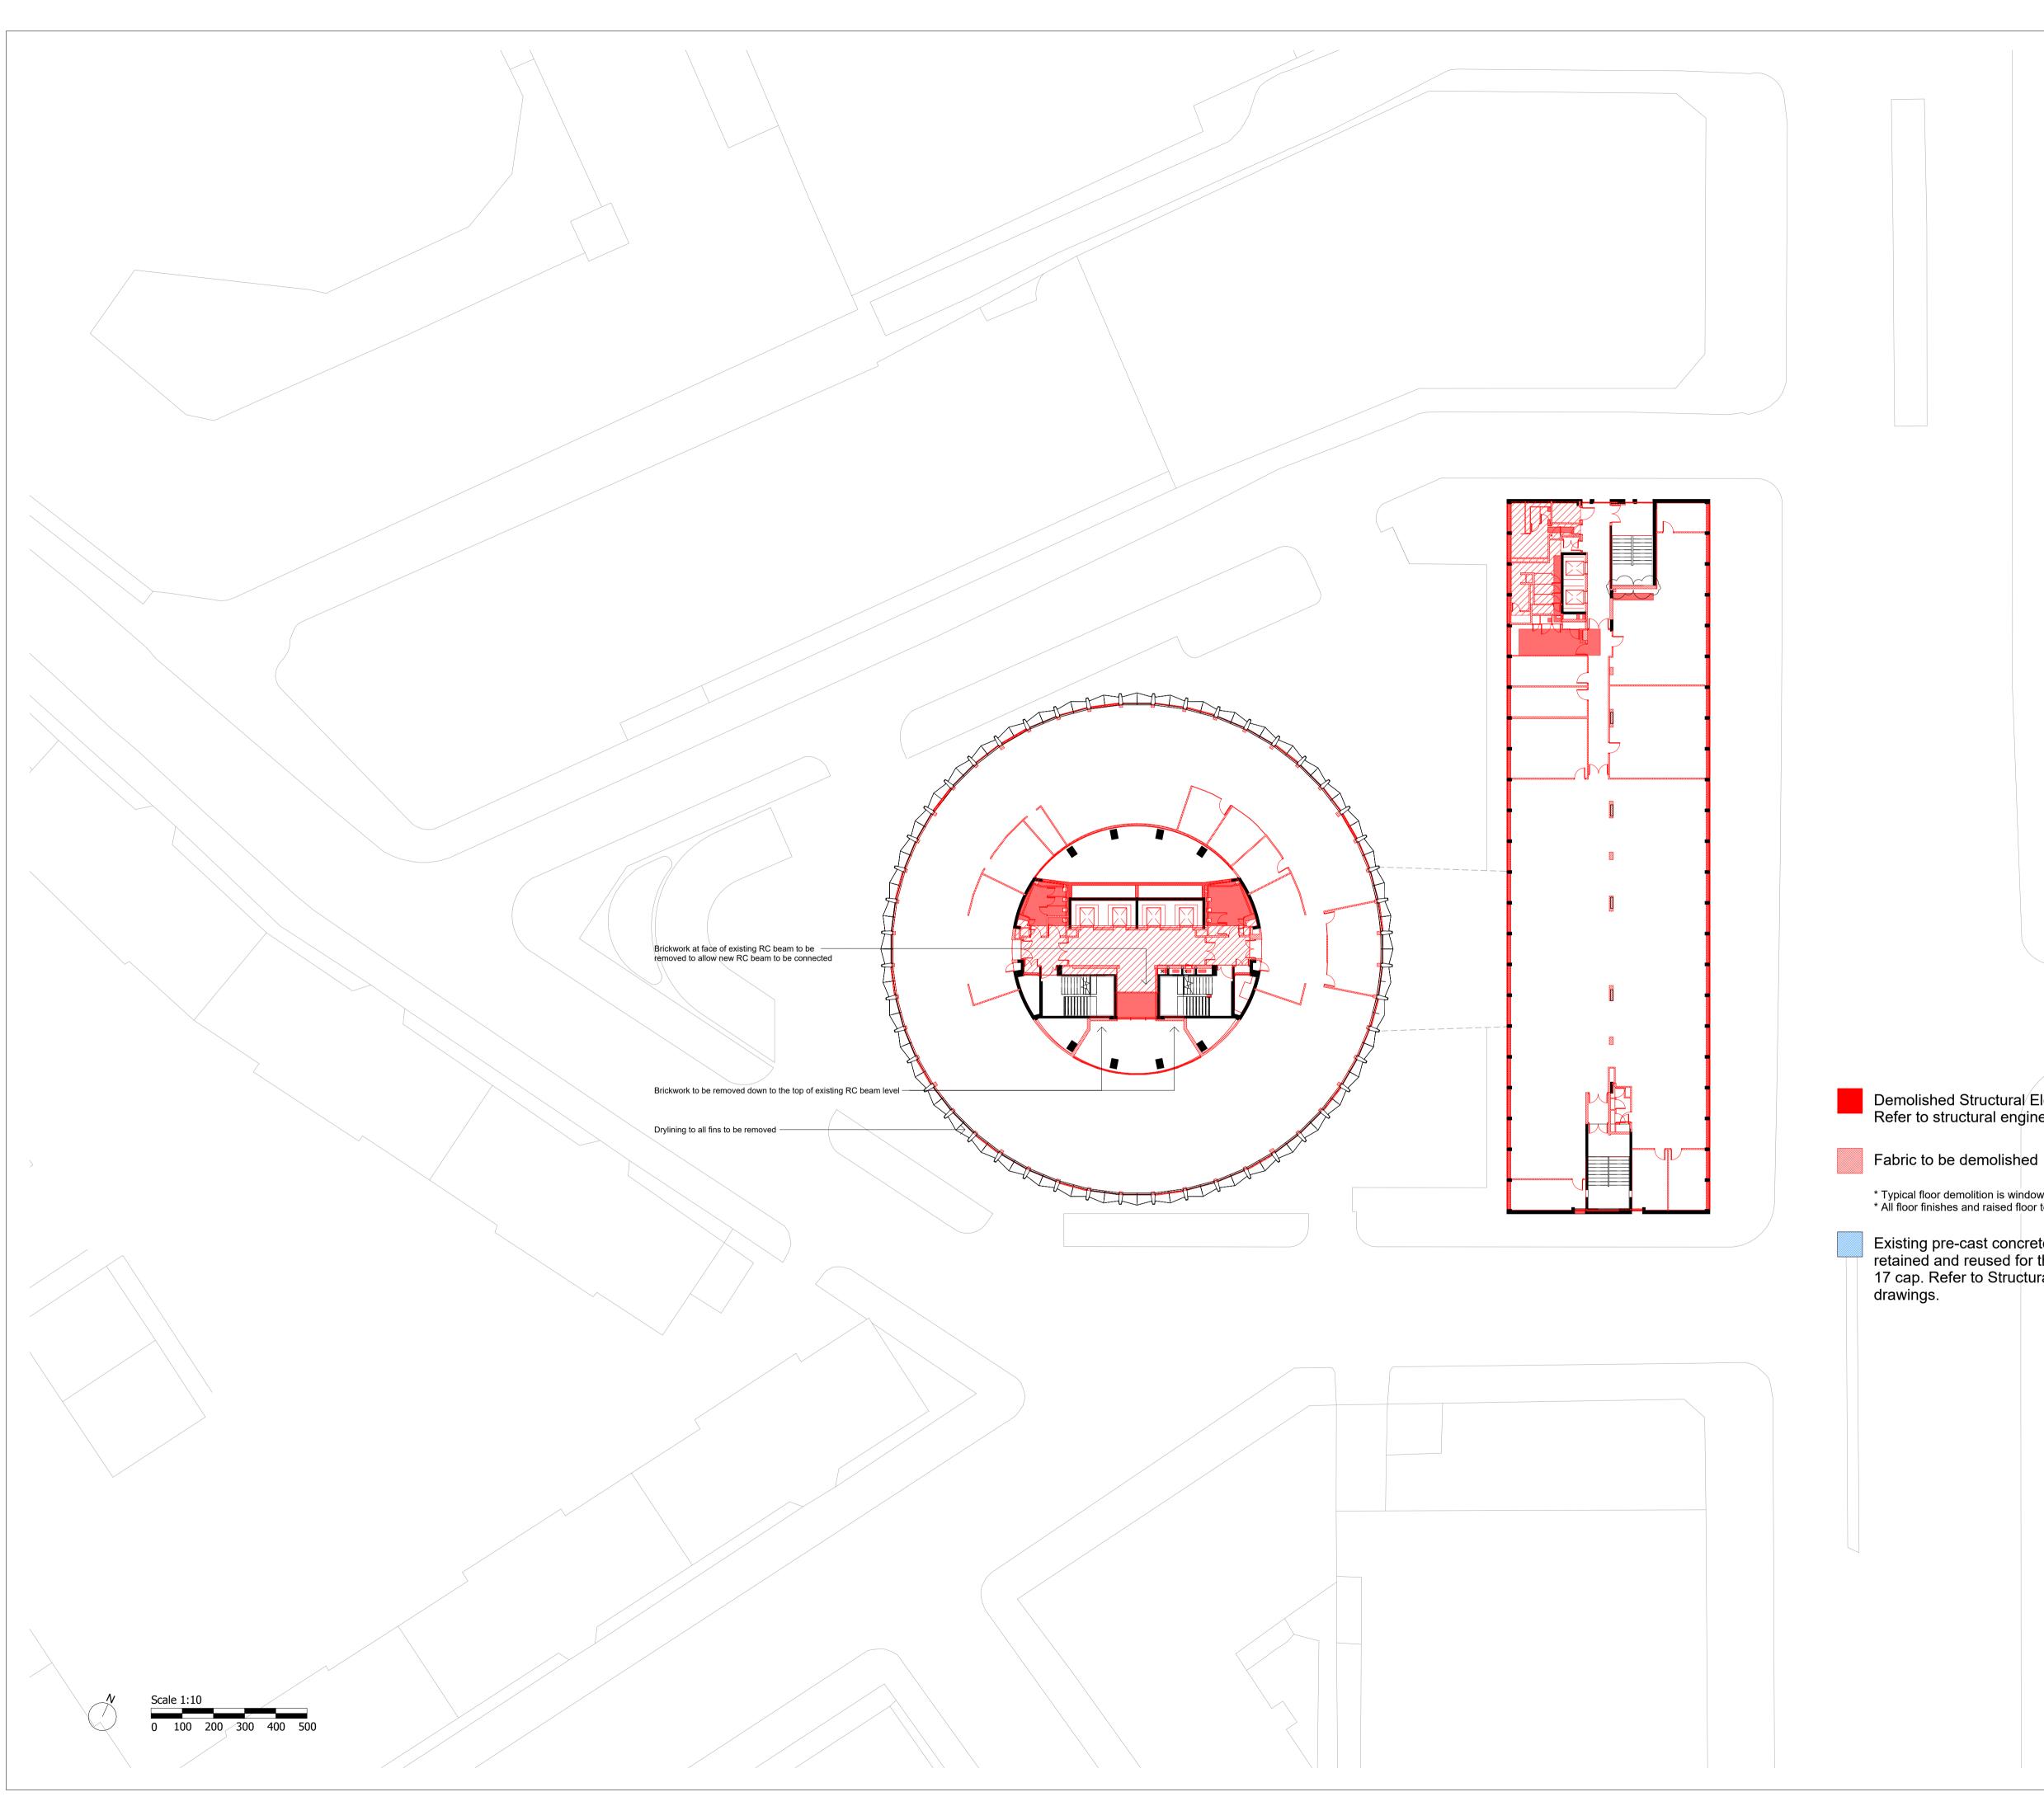

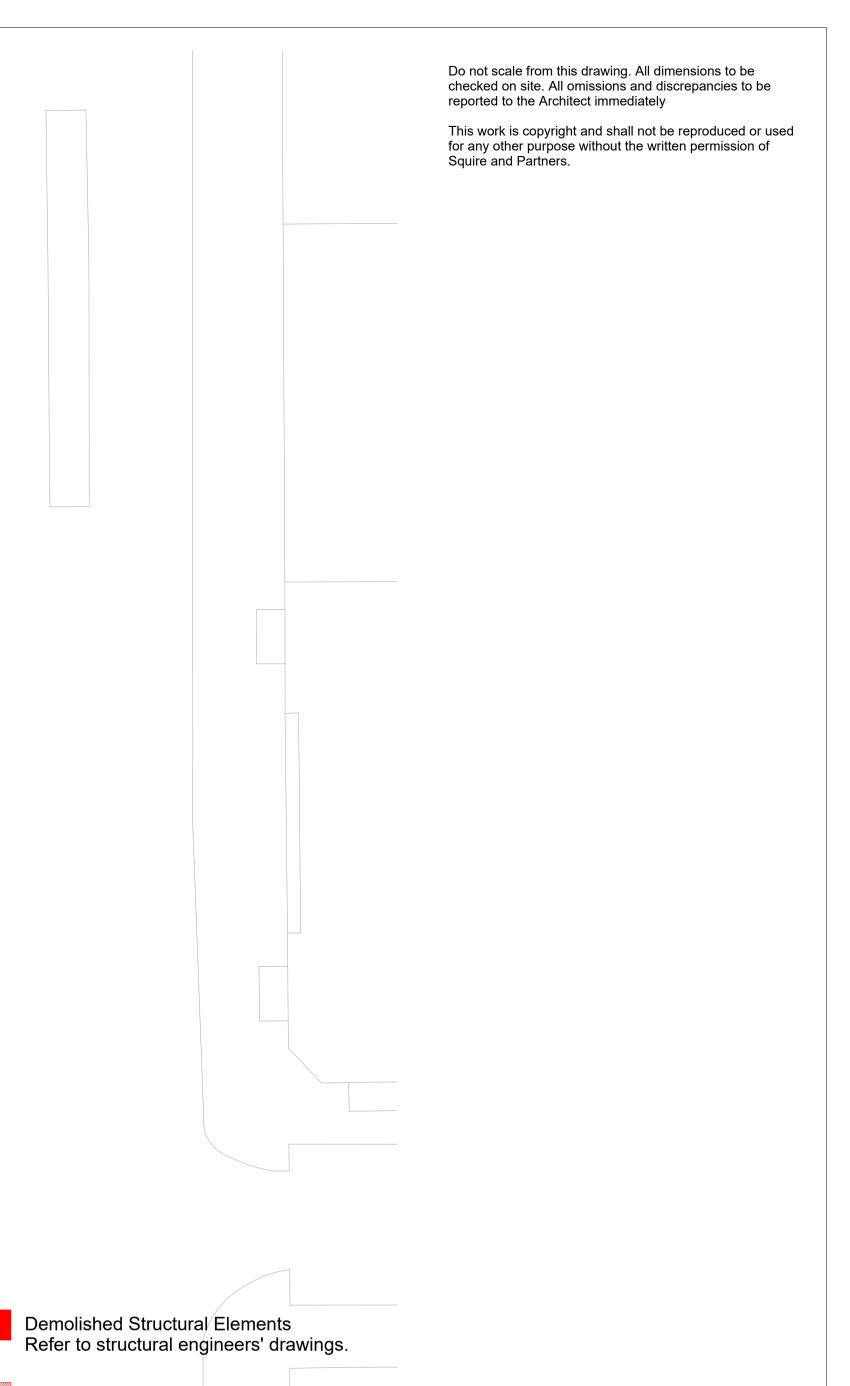

\* Typical floor demolition is windows only\* All floor finishes and raised floor to be removed.

Existing pre-cast concrete panels to be retained and reused for the new level 17 cap. Refer to Structural Engineer's drawings.

Non-Material Amendment Issue	22/07/22	SQP	E
Non-Material Amendment Issue	16/05/22	SQP	D
Non-Material Amendment Issue	09/02/22	SQP	С
Pre-Application Advice	08/07/20	SQP	В
Planning Submission	24/05/19	SQP	А
Description	Date	Chk	Rev

# SQUIRE & PARTNERS

Squire and Partners LLP The Department Store 248 Ferndale Road, London SW9 8FR T: 020 7278 5555

info@squireandpartners.com www.squireandpartners.com

Project	
Space House	

London WC2

# \_\_\_\_\_ Title

Level 07 **Demolition Plan** 

Status	
--------	--

Planning Submiss	sion	
Date	Scale @ ISO A1	Job Number
24/05/19	1 : 250	18077
Drawing Number		Revision

18077-SQP-ZZ-07-DP-A-PL01012 E

Squire & Partners LLP The Department Store 248 Ferndale Road, London SW9 8FR 020 7278 5555 info@squireandpartners.com squireandpartners.com