

External Facade Elevation With Grille Location
 Scale: 1:50 @ A1



North Elevation - pt 1 of 2

Revision	Date	Description
1.0	21-12-2020	Issued for planning application
2.0	19-07-2022	Scope updated ready for planning application issue

Do not reproduce this drawing without written permission.
 All dimensions are in millimetres unless stated otherwise.

Drawing Not For Construction

High Speed (HS2) Limited
 1st-3rd Floor
 The Podium
 1 Eversholt Street
 London NW1 2DN

Costain Skanska Joint Venture
 3rd Floor
 Addison Lee Compound
 Granby Terrace
 London NW1 3SA

Site Address 3-14 Mornington Terrace, London, NW1			
Drawing Title External Elevation-Existing			
Drawn by AP	Reviewed by AP	Checked by MA	Presentation Scale 1:50 @ A1
Date 18-12-2020	Drawing No. EW-NI-MORNINGTON TER-EX-EL-01		Revision 2.0

External Facade Elevation With Grille Location
 Scale: 1:50 @ A1



North Elevation - pt 2 of 2

Revision	Date	Assessment
1.0	21-12-2020	Issued for planning application
2.0	19-07-2022	Scope updated ready for planning application issue

Do not reproduce this drawing without written permission.
 All dimensions are in millimetres unless stated otherwise.


Drawing Not For Construction

High Speed (HS2) Limited
 1st-3rd Floor
 The Podium
 1 Eversholt Street
 London NW1 2DN

Costain Skanska Joint Venture
 3rd Floor
 Addison Lee Compound
 Granby Terrace
 London NW1 3SA

Site Address 3-14 Mornington Terrace, London, NW1			
Drawing Title External Elevation-Existing			
Drawn by AP	Reviewed by AP	Checked by MA	Presentation Scale 1:50 @ A1
Date 18-12-2020	Drawing No. EW-NI-MORNINGTON TER-EX-EL-01		Revision 2.0

External Facade Elevation With Grille Location
Scale: 1:50 @ A1

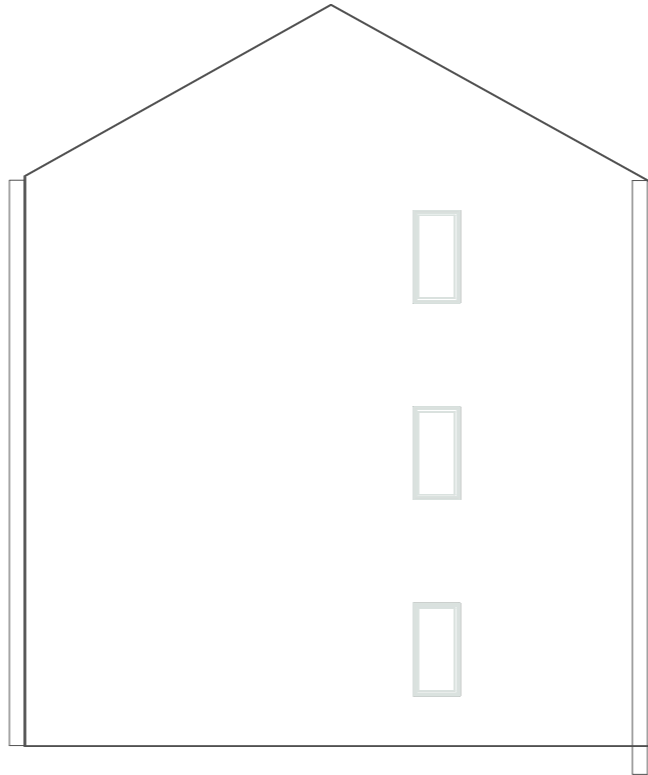

West Elevation

Revision	Date	Description
1.0	21-12-2020	Issued for planning application
2.0	19-07-2022	Scope updated ready for planning application issue

Do not reproduce this drawing without written permission.
All dimensions are in millimetres unless stated otherwise.


Drawing Not For Construction

High Speed (HS2) Limited
1st-3rd Floor
The Podium
1 Eversholt Street
London NW1 2DN

Costain Skanska Joint Venture
3rd Floor
Addison Lee Compound
Granby Terrace
London NW1 3SA

Site Address			
3-14 Mornington Terrace, London, NW1			
Drawing Title			
External Elevation-Existing			
Drawn by	Reviewed by	Checked by	Presentation Scale
AP	AP	MA	1:50 @ A1
Date	Drawing No.	Revision	
18-12-2020	EW-NI-MORNINGTON TER-EX-EL-01	2.0	

External Facade Elevation With Grille Location
 Scale: 1:50 @ A1

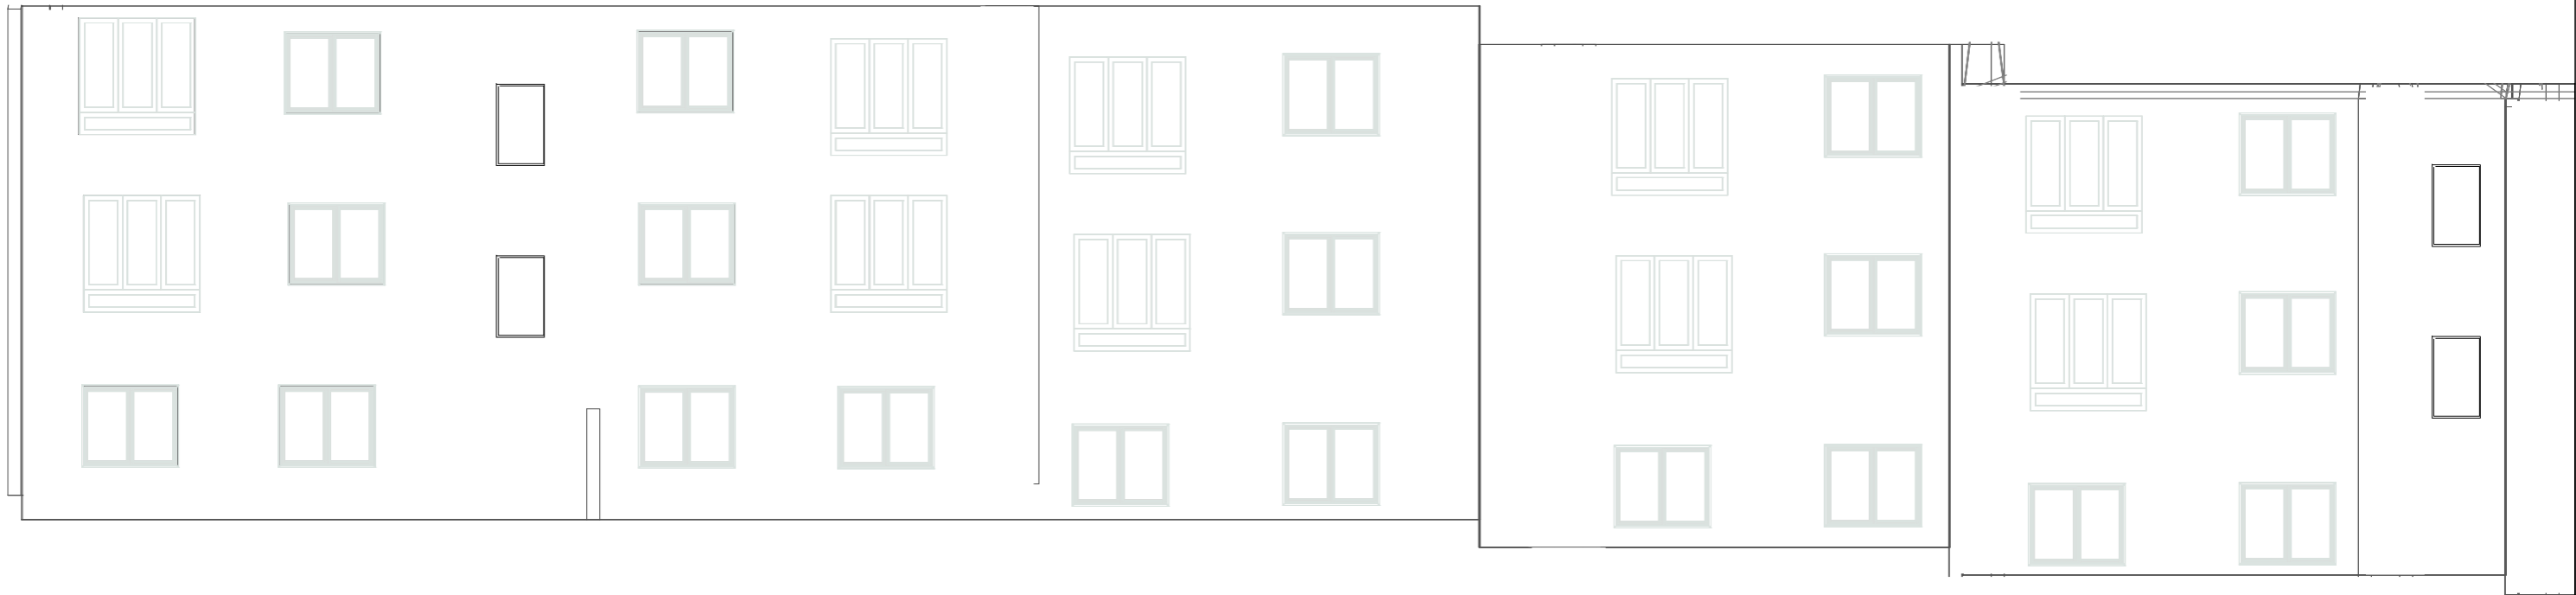

South Elevation - pt 1 of 2

Revision	Date	Assessment
1.0	21-12-2020	Issued for planning application
2.0	19-07-2022	Scope updated ready for planning application issue

Do not reproduce this drawing without written permission.
 All dimensions are in millimetres unless stated otherwise.

High Speed (HS2) Limited
 1st-3rd Floor
 The Podium
 1 Eversholt Street
 London NW1 2DN

Costain Skanska Joint Venture
 3rd Floor
 Addison Lee Compound
 Granby Terrace
 London NW1 3SA

Site Address			
3-14 Mornington Terrace, London, NW1			
Drawing Title			
External Elevation-Existing			
Drawn by	Reviewed by	Checked by	Presentation Scale
AP	AP	MA	1:50 @ A1
Date	Drawing No.	Revision	
18-12-2020	EW-NI-MORNINGTON TER-EX-EL-01	2.0	

Drawing Not For Construction

External Facade Elevation With Grille Location
 Scale: 1:50 @ A1



South Elevation - pt 2 of 2

Revision	Date	Description
1.0	21-12-2020	Issued for planning application
2.0	19-07-2022	Scope updated ready for planning application issue

Do not reproduce this drawing without written permission.
 All dimensions are in millimetres unless stated otherwise.

High Speed (HS2) Limited
 1st-3rd Floor
 The Podium
 1 Eversholt Street
 London NW1 2DN

Costain Skanska Joint Venture
 3rd Floor
 Addison Lee Compound
 Granby Terrace
 London NW1 3SA

Site Address 3-14 Mornington Terrace, London, NW1			
Drawing Title External Elevation-Existing			
Drawn by AP	Reviewed by AP	Checked by MA	Presentation Scale 1:50 @ A1
Date 18-12-2020	Drawing No. EW-NI-MORNINGTON TER-EX-EL-01		Revision 2.0

Drawing Not For Construction