

DO NOT SCALE FROM THIS DRAWING. ALL DIMENSIONS TO BE CHECKED ON SITE.

1. THIS DRAWING IS TO BE READ IN CONJUNCTION WITH THE ARCHITECTS AND STRUCTURAL ENGINEERS DRAWINGS AND WITH THE PROJECTS SCHEDULES

THIS DRAWING IS TO BE READ IN CONJUNCTION WITH THE RELEVANT DETAILS AND SCHEMATICS.

30-03-2021 ALL LARGE AC UNITS RELOCATED TO BACK ROW AWAY
FROM AUTO OPENING VENT

03-12-2020 ISSUED FOR APPROVAL
P00

Stephenson House - Residential

Roof Level Combined Services Co-ordinated Services Layout


Marks Barfield Architects



DRG No. 8555-MALA-PR-RF-DR-X-7106

CONSTRUCTION ISSUE SCALE As indicated @ A0 DRAWN CADTECH DATE 03/12/20

C00

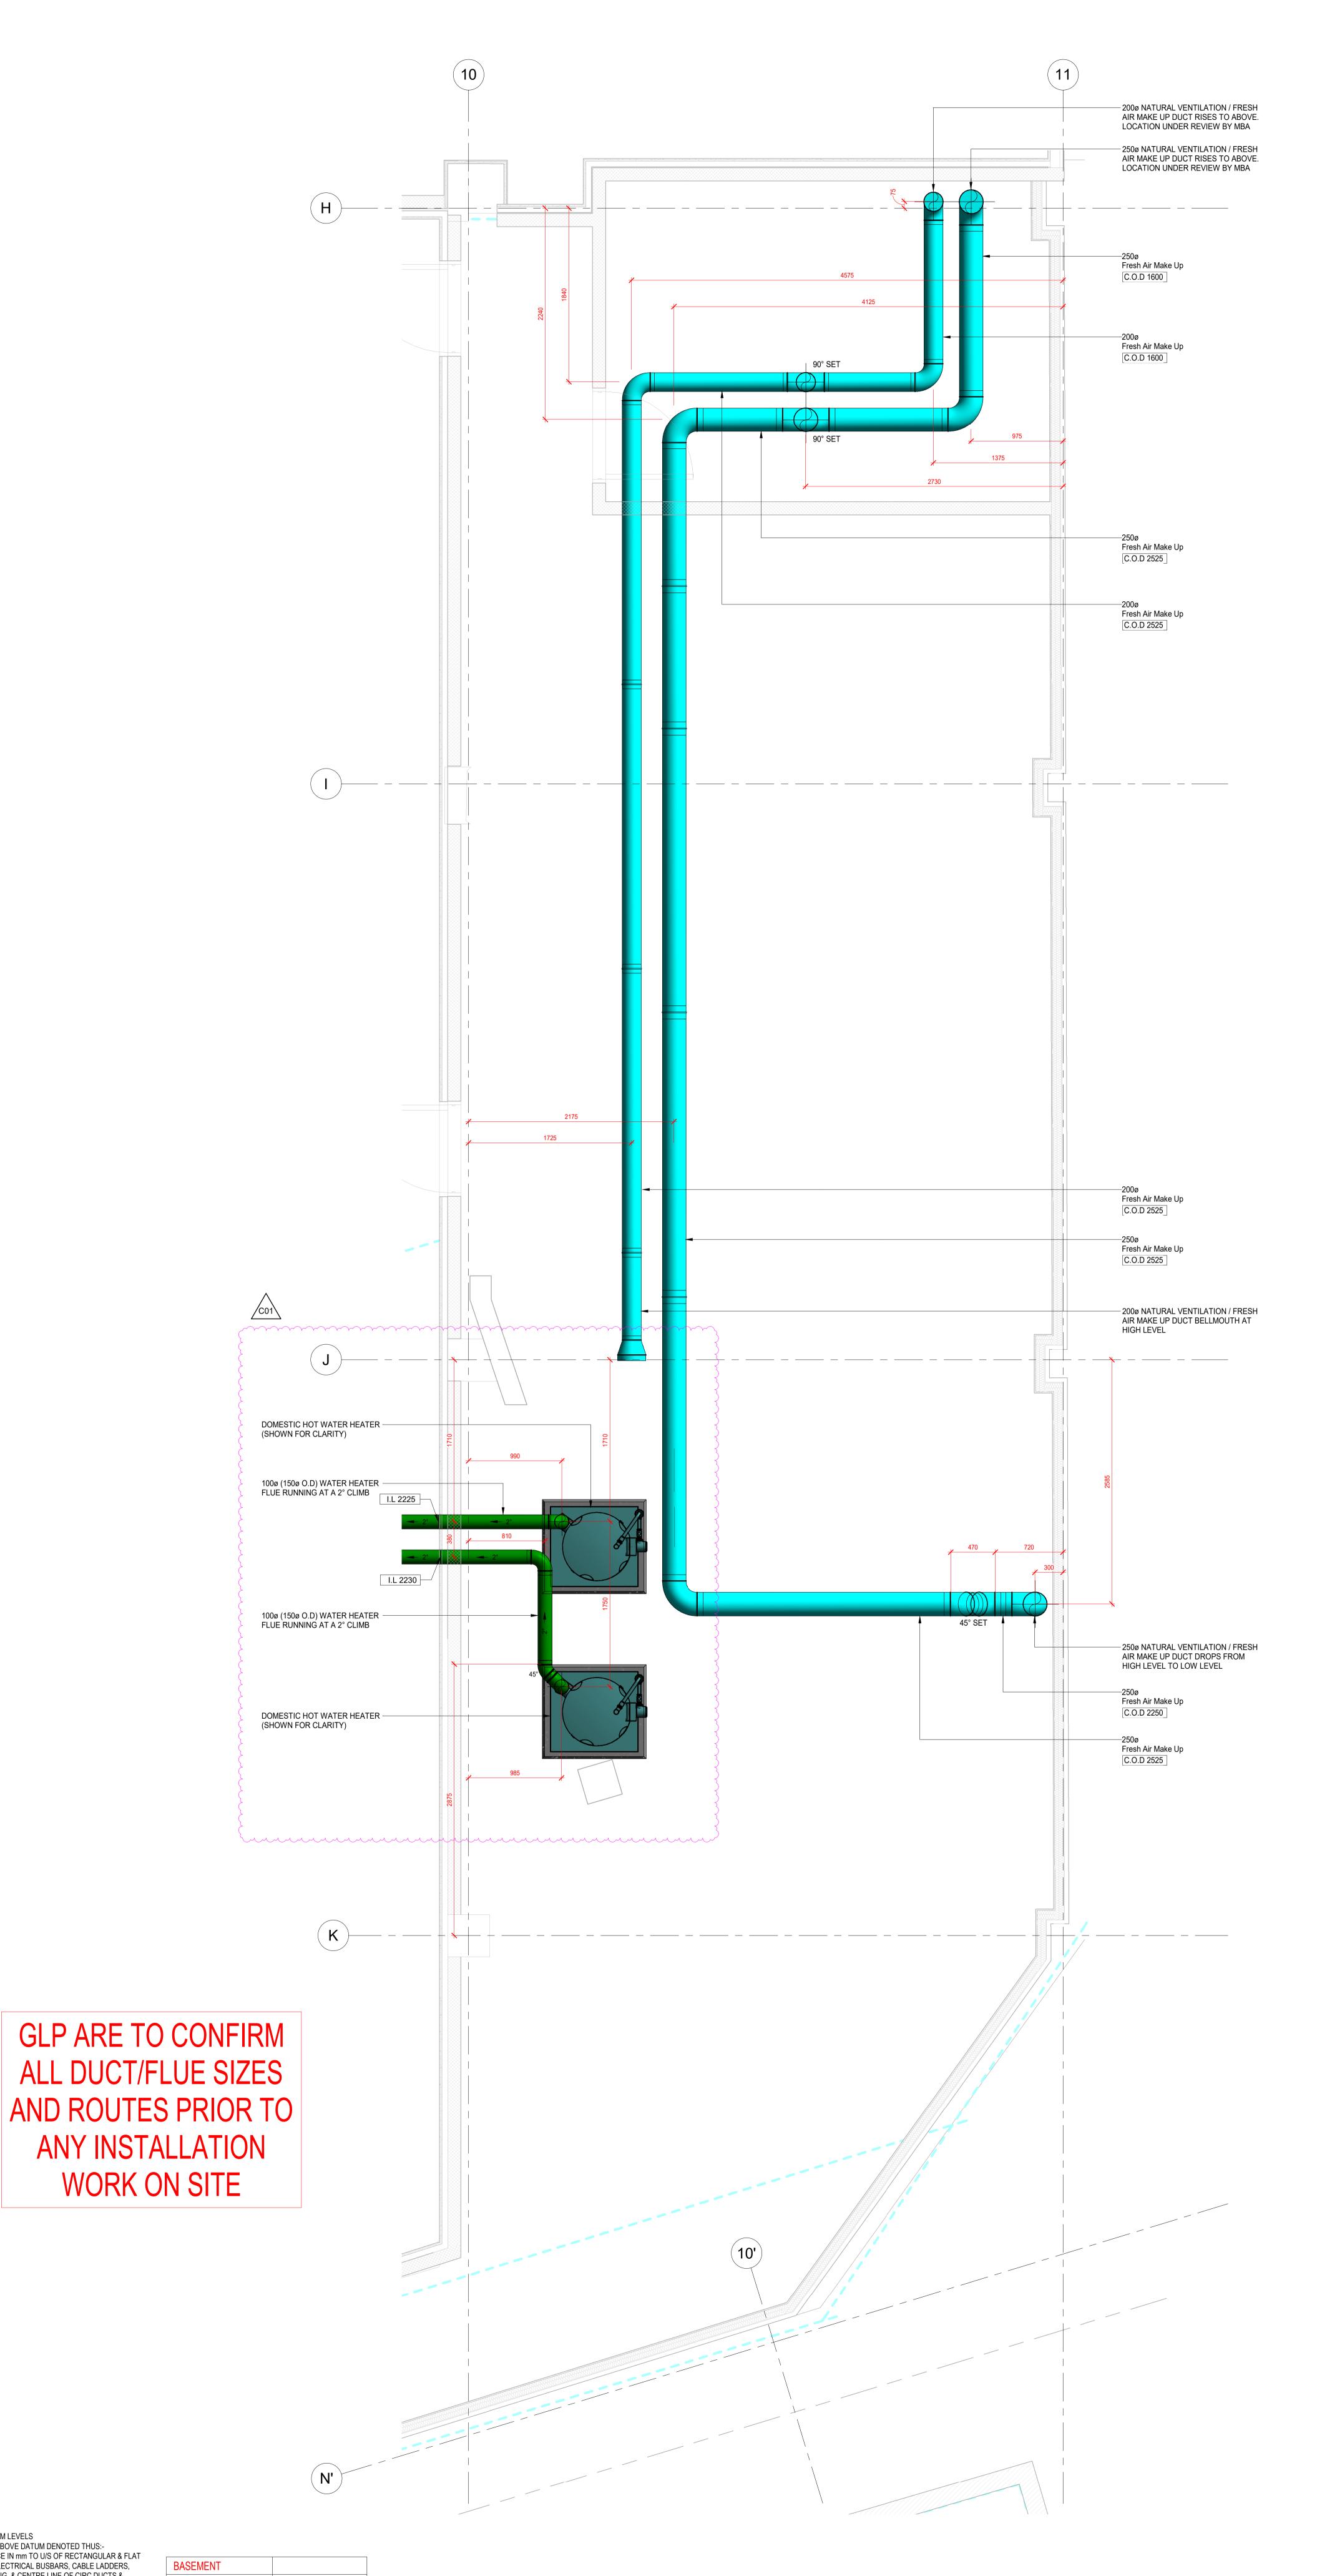

ALL INVERT LEVELS FOR DRAINAGE, RAINWATER AND CONDENSATE PIPEWORK ARE SHOWN TO THE UNDERSIDE OF THE PIPE FROM THE DATUM LEVEL SHOWN IN THE BOTTOM LEFT

ALL LEVELS SHOWN ON THIS DRAWING REFER TO THE SERVICES SETTING OUT DATUM LEVEL. ANY DIMENSIONS OR SERVICES ELEVATIONS SHOWN ARE ASSOCIATED WITH THIS DATUM. FOR ALL ARCHITECTURAL FINISHED FLOOR LEVELS AND RAISED FLOOR LEVELS PLEASE REFER TO ARCHITECTURAL INFORMATION

CORNER OF THE DRAWING

KEY PLAN

02-12-2020 ISSUED FOR CONSTRUCTION. WATER HEATER LOCATIONS & FLUE ROUTE UPDATED

27-10-2020 ISSUED FOR CONSTRUCTION C00

26-06-2020 ISSUED FOR APPROVAL P00

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2. THIS DRAWING IS TO BE READ IN CONJUNCTION WITH THE RELEVANT

4. ALL METAL DUCTWORK TO BE IN ACCORDANCE WITH HVCA DW/144

5. FIRE DAMPERS TO BE PROVIDED AT ALL INTERSECTIONS WITH THE FIRE COMPARTMENTATION LAYOUT. MOTORISED FIRE AND SMOKE DAMPERS TO

AND FIRE COMPARTMENT WALLS FOR HORIZONTAL PROGRESSIVE

BE PROVIDED WHERE SERVICES PENETRATE PROTECTED ESCAPE ROUTES

6. PROVIDE ACCESS DOORS IN ACCORDANCE WITH DW/144. WHERE POSSIBLE,

LOCATE DAMPERS IN PROXIMITY TO ONE ANOTHER TO SHARE A COMMON

ACCESS DOOR AND MINIMISE CEILING VOID ACCESS. WHERE POSSIBLE, LOCATE ACCESS DOORS WITHIN EASILY ACCISSIBLE AREAS SUCH AS CORE

7. LOCATE VOLUME CONTROL DAMPERS IN ACCORDANCE WITH MANUFACTURER REQUIREMENTS AND WHEREVER PRACTICABLE

PROVISIONS FOR INSULATION AND /OR BRACKETRY.

3. DUCT SIZES ARE BASED ON INTERNAL DIMENSIONS AND DO NOT INCLUDE

AND SPECIFICATIONS.

EVACUATION

<u>LEGEND</u>

AREAS AND RISERS.

SD - SMOKE DAMPER

C.O.D - CENTRE OF DUCT

B.O.D - BOTTOM OF DUCT

EG - EXTRACT GRILLE

SG - SUPPLY GRILLE

EV - EXTRACT VALVE

SV - SUPPLY VALVE

FCU - FAN COIL UNIT

VCD - VOLUME CONTROL DAMPER

NRD - NON RETURN DAMPER

HRU - HEAT RECOVERY UNIT

TEF - TOILET EXTRACT FAN

FC - FLEXIBLE CONNECTION

FD - FIRE DAMPER

ON STRAIGHT LENGTHS OF DUCT.

DETAILS AND SCHEMATICS.

CONTRACT

Stephenson House

TITLE

Basement Commercial Plantroom Mechanical Services Ventilation Layout

Marks Barfield Architects CONSULTANT GLP




ISSUED FOR CONSTRUCTION

DRAWN CADTECH DATE 22/06/20 SCALE 1:25 @ A0 DRG No. 8555-MALA-PR-B1-DR-X- 7300

SERVICES DATUM LEVELS ALL SERVICES ABOVE DATUM DENOTED THUS:-XXXX DISTANCE IN mm TO U/S OF RECTANGULAR & FLAT OVAL DUCTS, ELECTRICAL BUSBARS, CABLE LADDERS, TRAYS, TRUNKING, & CENTRE LINE OF CIRC DUCTS & PIPEWORK. LEVELS PREFIXED I.L INDICATES INVERT LEVEL OF SOIL, GRAVITY RAINWATER & CONDENSATE PIPE ABOVE DATUM LEVEL. LEVELS PREFIXED T.O.P INDICATES LEVEL TO TOP OF PIPE FOR SIPHONIC RAINWATER ABOVE DATUM


DATUM LEVEL 23.350 23.108

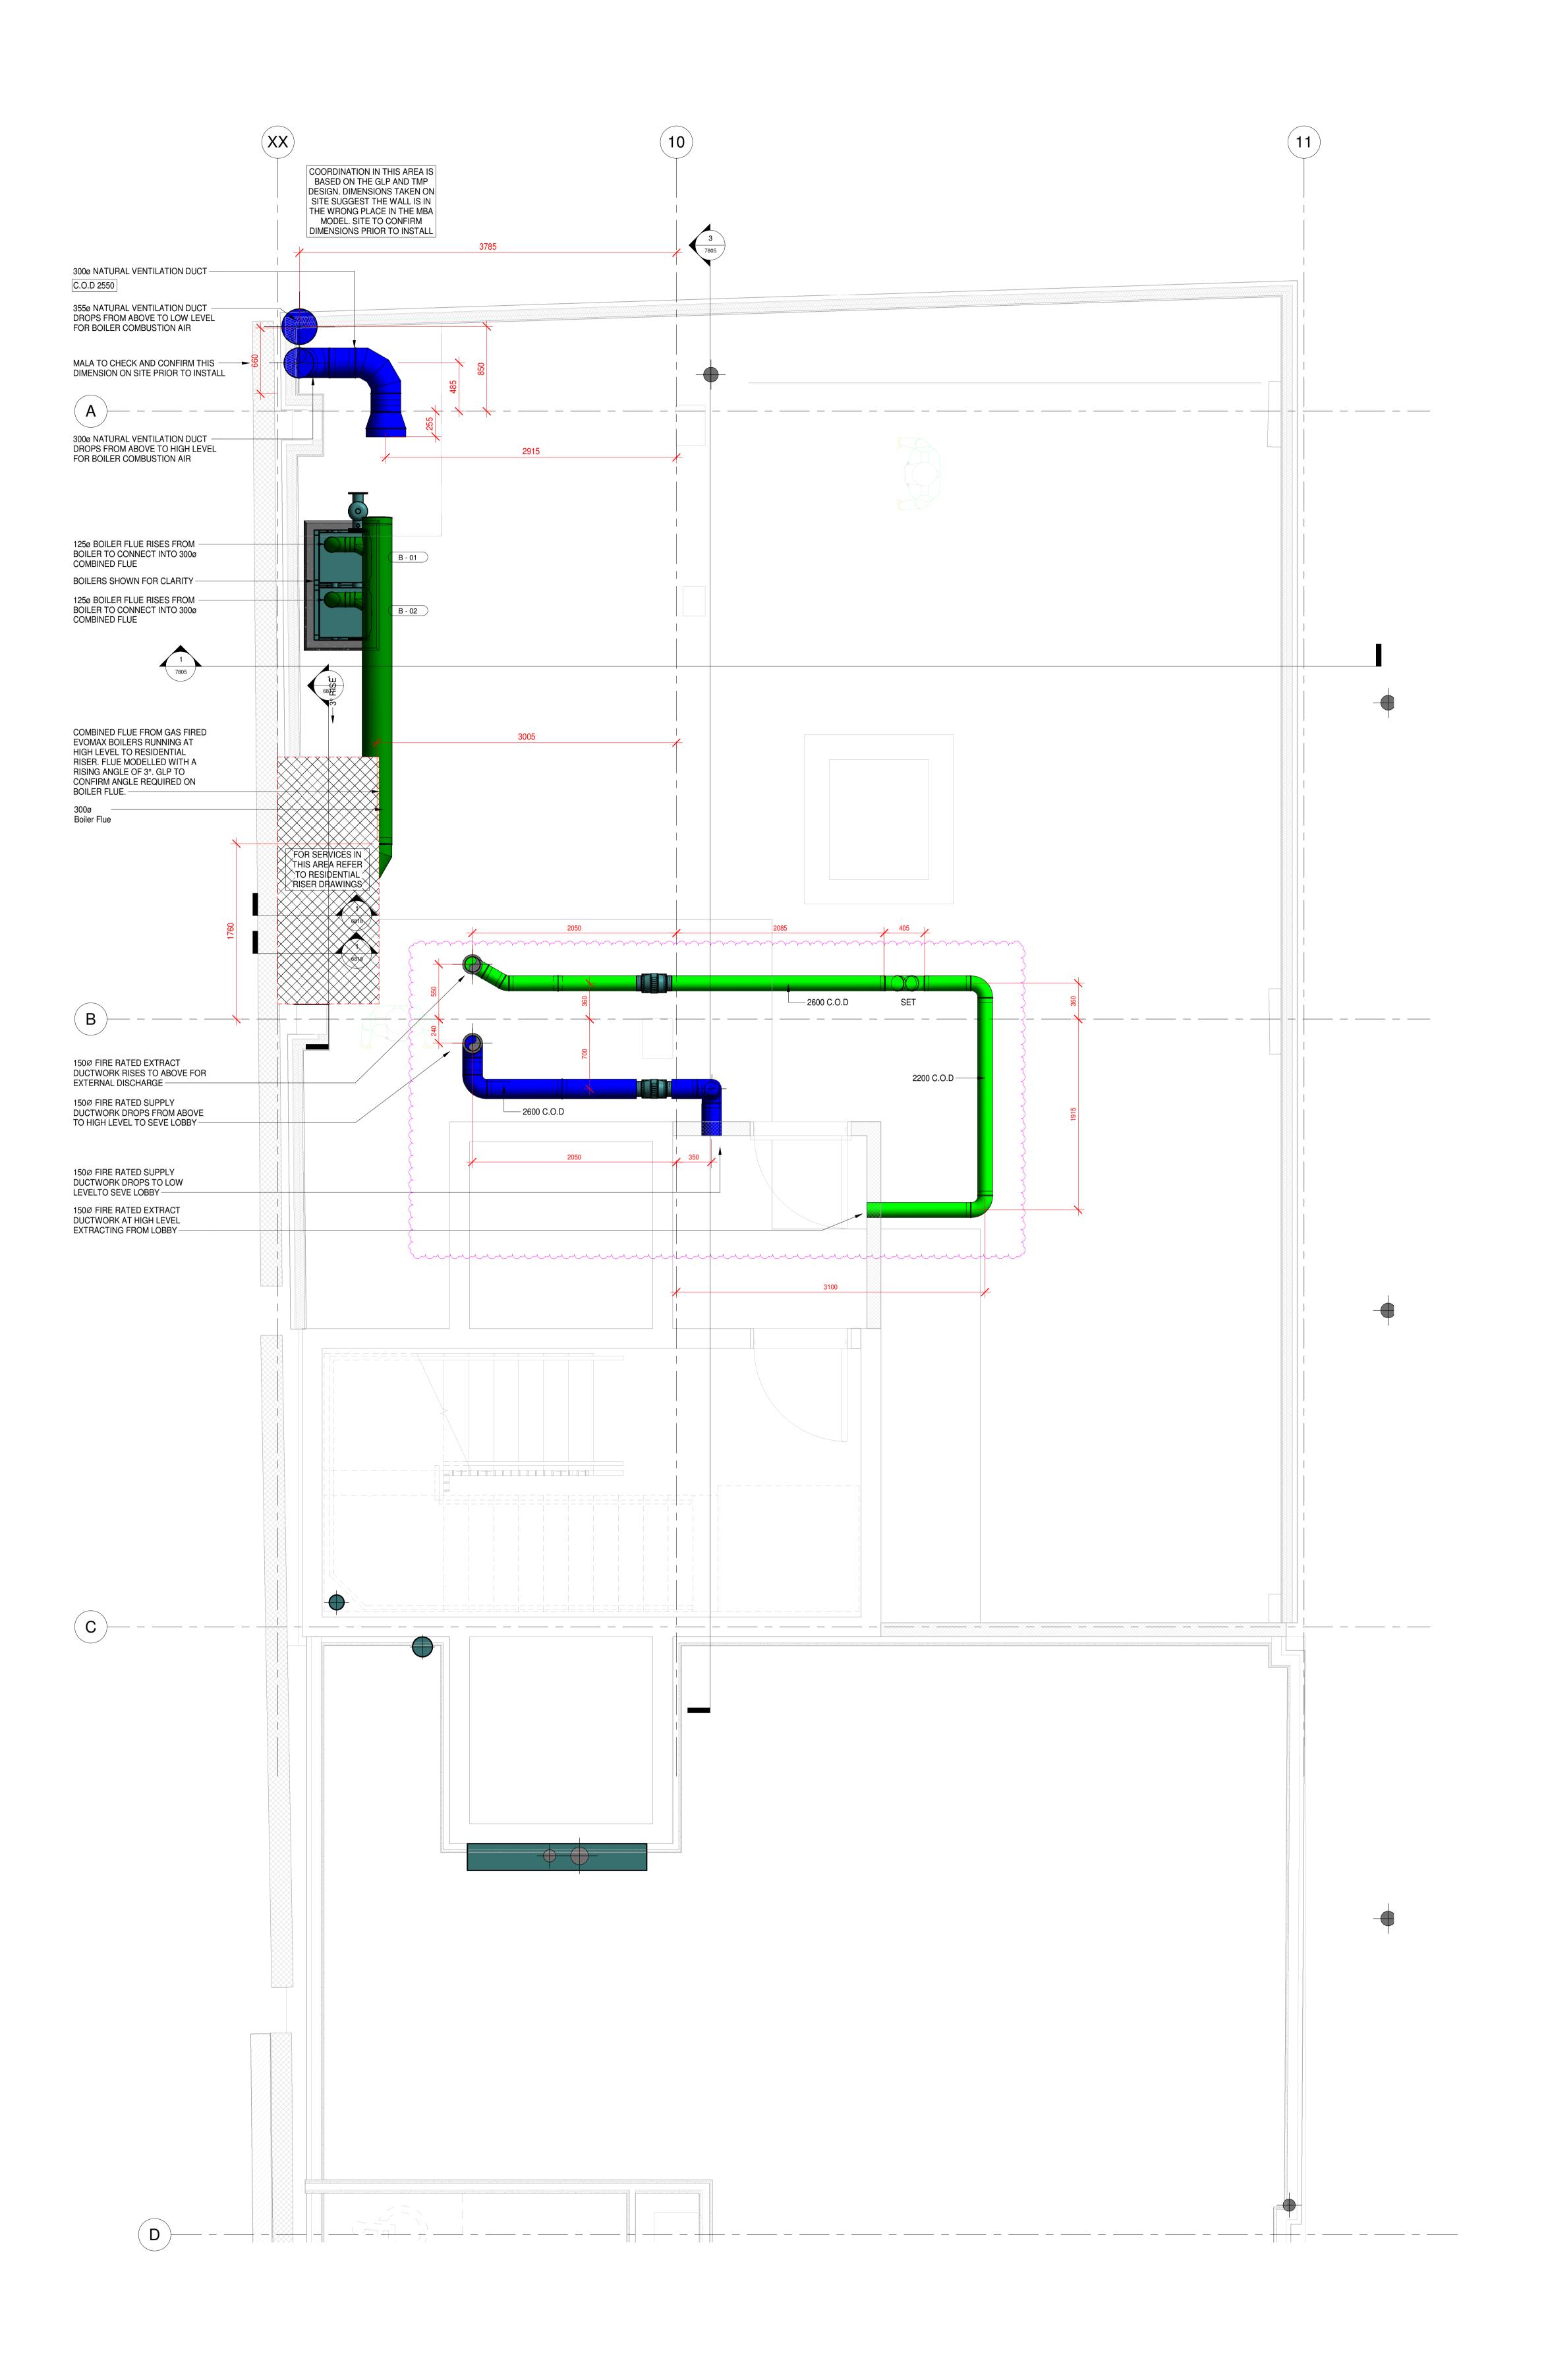

ALL LEVELS SHOWN ON THIS DRAWING REFER TO SERVICES SETTING OUT DATUM LEVELS. ANY DIMENSIONS OR SERVICES ELEVATIONS SHOWN ARE ASSOCIATED WITH THIS DATUM. FOR ALL ARCHITECTURAL FINISHED FLOOR LEVELS AND RAISED FLOOR LEVELS PLEASE REFER TO ARCHITECTURAL INFORMATION

SERVICES DATUM LEVELS ALL SERVICES ABOVE DATUM DENOTED THUS:-XXXX DISTANCE IN mm TO U/S OF RECTANGULAR & FLAT OVAL DUCTS, ELECTRICAL BUSBARS, CABLE LADDERS, TRAYS, TRUNKING, & CENTRE LINE OF CIRC DUCTS & PIPEWORK. LEVELS PREFIXED I.L INDICATES INVERT LEVEL OF SOIL, GRAVITY RAINWATER & CONDENSATE PIPE ABOVE DATUM LEVEL. LEVELS PREFIXED T.O.P INDICATES LEVEL TO TOP OF PIPE FOR SIPHONIC RAINWATER ABOVE DATUM

BASEMENT DATUM LEVEL 23.350 30.460

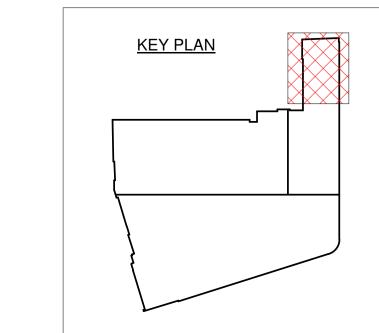

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<u>LEGEND</u>

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NRD - NON RETURN DAMPER

HRU - HEAT RECOVERY UNIT

FCU - FAN COIL UNIT

TEF - TOILET EXTRACT FAN

FC - FLEXIBLE CONNECTION

25.09.2020 UPDATED TO SUIT MBA COMMENTS AND GLP RE-DESIGN
01-06-2020 ISSUED FOR CONSTRUCTION
21-04-2020 ISSUED FOR APPROVAL C00 P00 Rev Date

CONTRACT Stephenson House - Residential

Basement Residential Plantroom Mechanical Services

Ventilation Layout

Marks Barfield Architects CONSULTANT GLP



Drawing Status CONSTRUCTION ISSUE

DRAWN CADTECH DATE 20/04/20 SCALE 1:25@A0 DRG No. 8555-MALA-PR-B1-DR-X- 7305