

Ground Stability Data (1:50,000)

Map ID		Details	Quadrant Reference (Compass Direction)	Estimated Distance From Site	Contact	NGR
	CBSCB Compensa	ation District				
	The site does not fa	all within the brine compensation area.				
	Brine Subsidence	Solution Area				
	The site does not fa	all within the brine subsidence solution area.				
	Potential for Colla	psible Ground Stability Hazards				
12	Hazard Potential: Source:	Very Low British Geological Survey, National Geoscience Information Service	A13SE (SE)	0	1	527015 183850
	Potential for Compressible Ground Stability Hazards					
	Hazard Potential: Source:	No Hazard British Geological Survey, National Geoscience Information Service	A13SE (SE)	0	1	527015 183850
	Potential for Ground Dissolution Stability Hazards					
	Hazard Potential: Source:	No Hazard British Geological Survey, National Geoscience Information Service	A13SE (SE)	0	1	527015 183850
	Potential for Landslide Ground Stability Hazards					
13	Hazard Potential: Source:	Very Low British Geological Survey, National Geoscience Information Service	A13SE (SE)	0	1	527015 183850
	Potential for Runn	ing Sand Ground Stability Hazards				
14	Hazard Potential: Source:	Very Low British Geological Survey, National Geoscience Information Service	A13SE (SE)	0	1	527015 183850
	Potential for Shrinking or Swelling Clay Ground Stability Hazards					
15	Hazard Potential: Source:	Moderate British Geological Survey, National Geoscience Information Service	A13SE (SE)	0	1	527015 183850

Order Number: 286852753_1_1 Date: 26-Oct-2021 rpr_ec_datasheet v53.0 A Landmark Information Group Service Page 2 of 6



Historical Map List

The following mapping has been analysed for Historical Land Use Information (1:2,500):

1:2,500	Mapsheet	Published Date
Ordnance Survey Plan	TQ2783	1954
Ordnance Survey Plan	TQ2784	1954

The following mapping has been analysed for Historical Land Use Information (1:10,000):

1:10,560	Mapsheet	Published Date
Middlesex	011_00	1873
Middlesex	016_00	1874
Middlesex	017_00	1882
London	002_SE	1896
London	006_NE	1896
London	007_NW	1896
Middlesex	011_SE	1896
Middlesex	016_NE	1896
Middlesex	017_NW	1896
London	001_00	1920
London	004_00	1920
London	005_00	1920
London	004_00	1938
London	005_00	1938
Middlesex	011_SE	1938
Ordnance Survey Plan	TQ28NE	1951
Ordnance Survey Plan	TQ28SE	1951
1:10,000	Mapsheet	Published Date
Ordnance Survey Plan	TQ28SE	1991
Ordnance Survey Plan	TQ28NE	1996



Data Currency

Mining and Cavities Data	Version	Update Cycle
BGS Recorded Mineral Sites		
British Geological Survey - National Geoscience Information Service	May 2021	Bi-Annually
Coal Mining Affected Areas		
The Coal Authority - Property Searches	March 2014	Annual Rolling Update
Man Made Mining Cavities		
Stantec UK Ltd	May 2021	Bi-Annually
Mining Instability		
Ove Arup & Partners	June 1998	Not Applicable
Natural Cavities		
Stantec UK Ltd	May 2021	Bi-Annually
Non Coal Mining Areas of Great Britain		
British Geological Survey - National Geoscience Information Service	May 2015	Not Applicable
Historical Land Use Information (1:2,500)	Version	Update Cycle
Subterranean Features		
Landmark Information Group Limited	February 2020	Bi-Annually
Ground Stability Data (1:50,000)	Version	Update Cycle
CBSCB Compensation District		
Cheshire Brine Subsidence Compensation Board (CBSCB)	August 2011	As notified
Potential for Collapsible Ground Stability Hazards		
British Geological Survey - National Geoscience Information Service	April 2020	Annually
Potential for Compressible Ground Stability Hazards		
British Geological Survey - National Geoscience Information Service	January 2019	Annually
Potential for Ground Dissolution Stability Hazards		
British Geological Survey - National Geoscience Information Service	January 2019	Annually
Potential for Landslide Ground Stability Hazards		
British Geological Survey - National Geoscience Information Service	January 2019	Annually
Potential for Running Sand Ground Stability Hazards		
British Geological Survey - National Geoscience Information Service	January 2019	Annually
Potential for Shrinking or Swelling Clay Ground Stability Hazards		
British Geological Survey - National Geoscience Information Service	January 2019	Annually
Brine Subsidence Solution Area		
Johnson Poole & Bloomer	December 2020	Annual Rolling Updat

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Data Suppliers

A selection of organisations who provide data within this report


Data Supplier	Data Supplier Logo
Ordnance Survey	Map data
British Geological Survey	British Geological Survey NATURAL ENVIRONMENT RESEARCH COUNCIL
The Coal Authority	The Coal Authority
Ove Arup	ARUP
Stantec UK Ltd	Stantec
Wardell Armstrong	wardell armstrong your earth our world
Johnson Poole & Bloomer	JPB




Useful Contacts

Contact	Name and Address	Contact Details
1	British Geological Survey - Enquiry Service British Geological Survey, Environmental Science Centre, Keyworth, Nottingham, Nottinghamshire, NG12 5GG	Telephone: 0115 936 3143 Fax: 0115 936 3276 Email: enquiries@bgs.ac.uk Website: www.bgs.ac.uk
-	Landmark Information Group Limited Imperium, Imperial Way, Reading, Berkshire, RG2 0TD	Telephone: 0844 844 9952 Fax: 0844 844 9951 Email: customerservices@landmarkinfo.co.uk Website: www.landmarkinfo.co.uk

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LANDMARK INFORMATION GROUP®

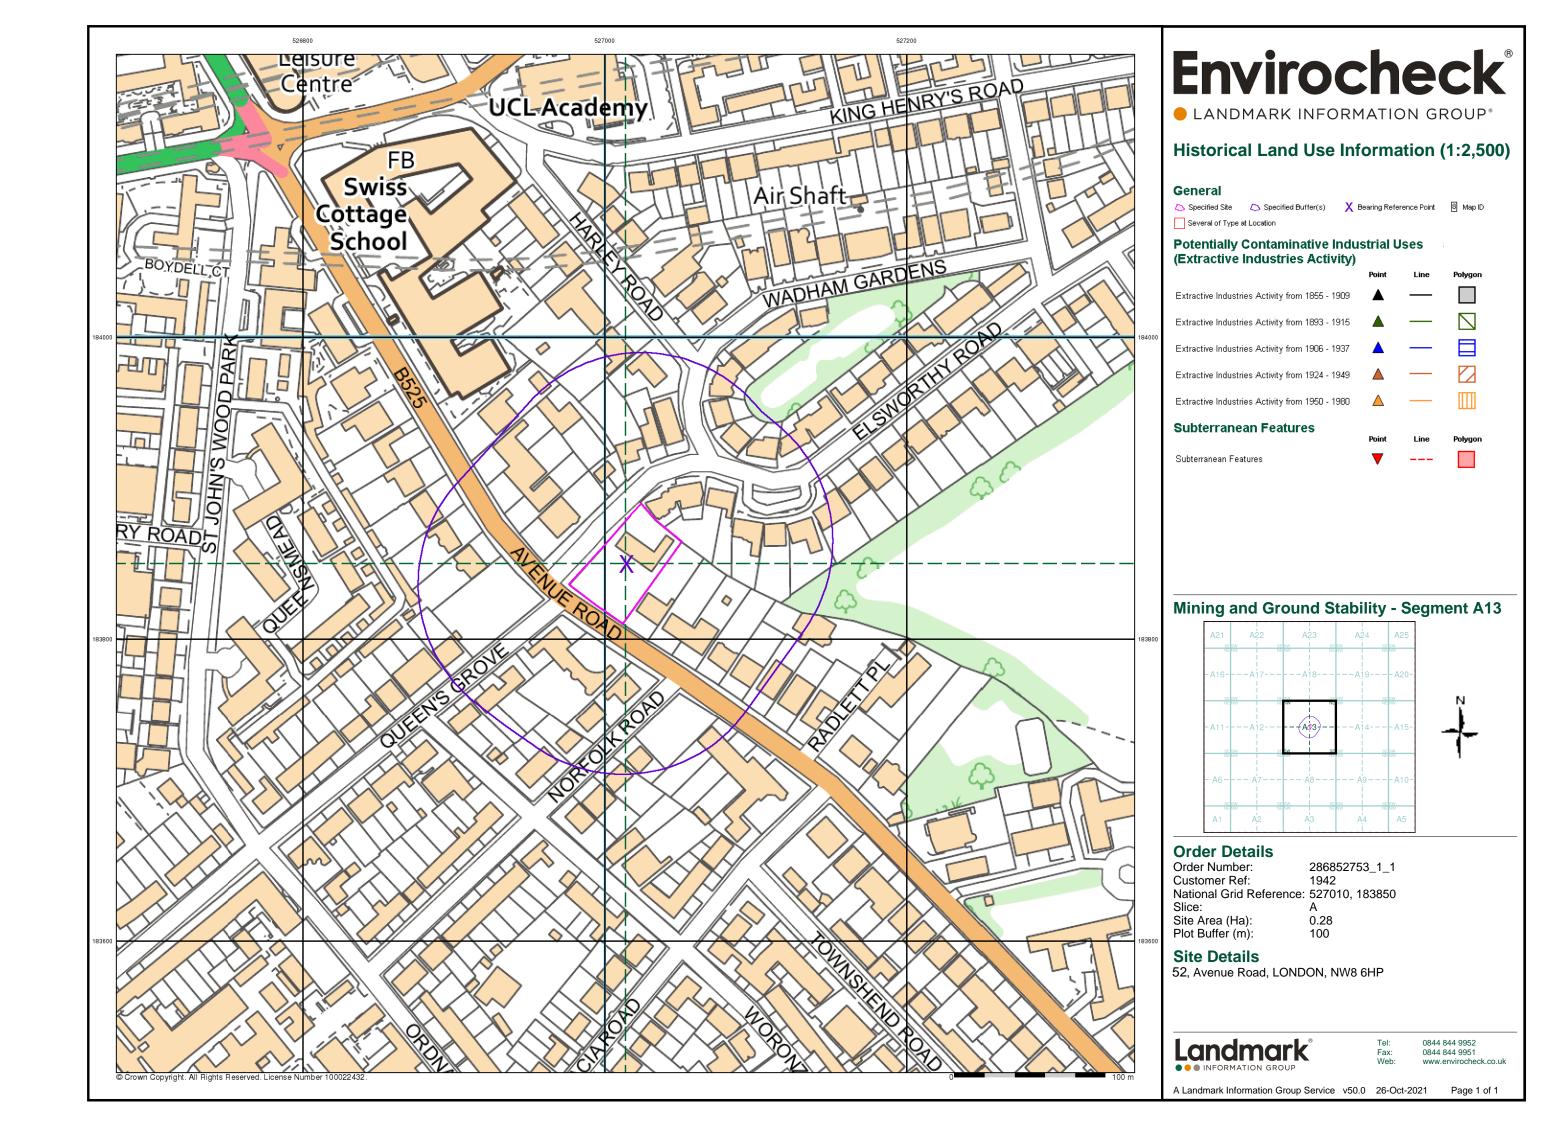Index Map

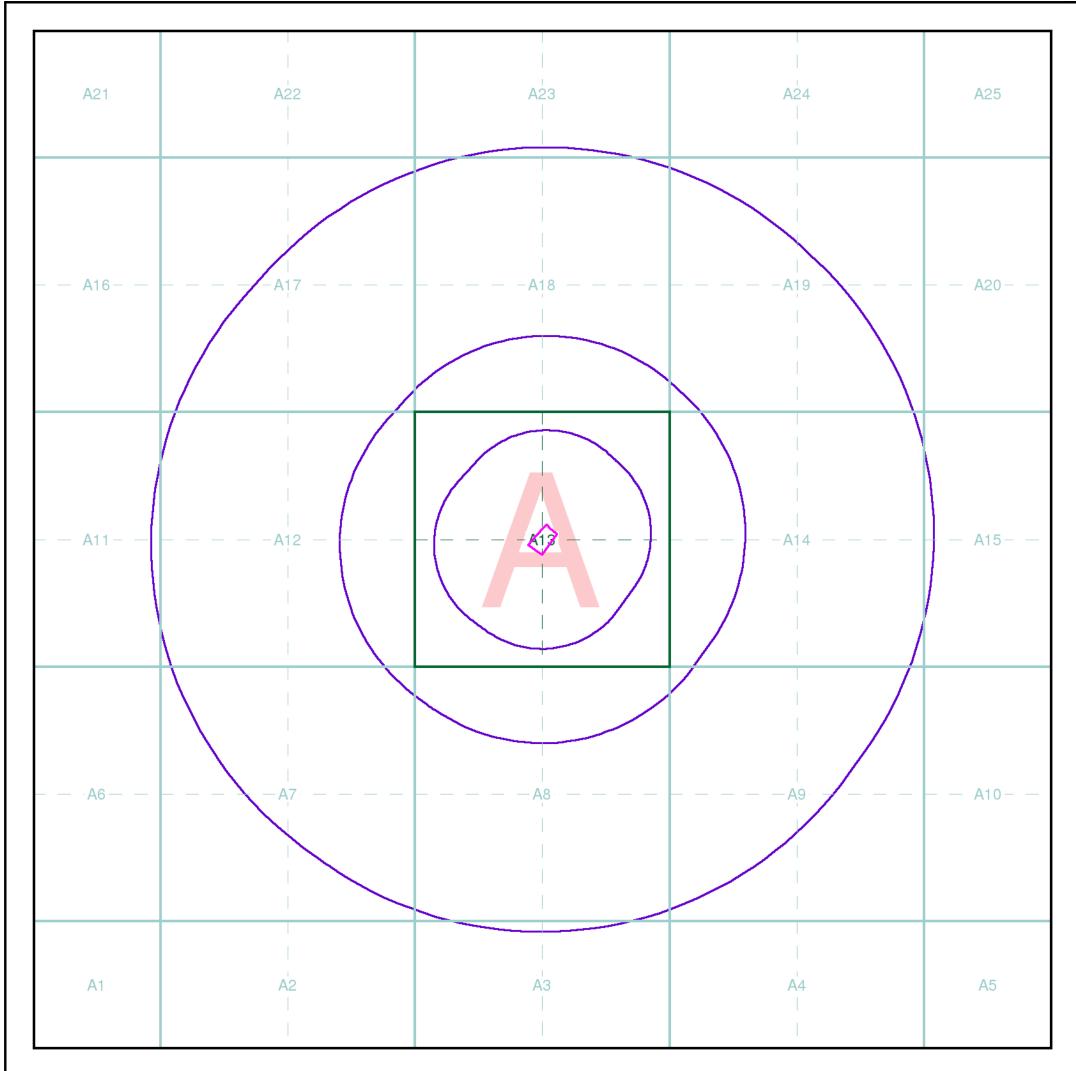For ease of identification, your site and buffer have been split into Slices, Segments and Quadrants. These are illustrated on the Index Map opposite and explained further below.

Slice

Each slice represents a 1:10,000 plot area (2.7km x 2.7km) for your site and buffer. A large site and buffer may be made up of several slices (represented by a red outline), that are referenced by letters of the alphabet, starting from the bottom left corner of the slice "grid". This grid does not relate to National Grid lines but is designed to give best fit over the site and buffer.

Segmen

A segment represents a 1:2,500 plot area. Segments that have plot files associated with them are shown in dark green, others in light blue. These are numbered from the bottom left hand corner within each slice.

Quadrant

A quadrant is a quarter of a segment. These are labelled as NW, NE, SW, SE and are referenced in the datasheet to allow features to be quickly located on plots. Therefore a feature that has a quadrant reference of A7NW will be in Slice A, Segment 7 and the NW Quadrant.

A selection of organisations who provide data within this report:









Envirocheck reports are compiled from 136 different sources of data.

Client Details

Mr A Fasano, A-squared Studio, 66 Church Road, Richmond, TW10 6LN

Order Details

Order Number: 286852753_1_1 Customer Ref: 1942

National Grid Reference: 527010, 183850

Site Area (Ha): 0.28 Search Buffer (m): 1000

Site Details

52, Avenue Road, LONDON, NW8 6HP

Full Terms and Conditions can be found on the following link: http://www.landmarkinfo.co.uk/Terms/Show/515



el: 0844 844 9952 ax: 0844 844 9951 (eb: www.envirocheck.co.uk

A Landmark Information Group Service v50.0 26-Oct-2021 Page 1 of 1



Appendix C: Unexploded Ordnance Risk Assessment

Landmark Information Group Ltd Imperium, Imperial Way Reading, Berkshire RG2 OTD, United Kingdom


T: +44 (0) 844 844 9952 W: www.envirocheck.co.uk





PRELIMINARY UNEXPLODED ORDNANCE (UXO) THREAT ASSESSMENT

Meeting the requirements of *CIRIA* C681 'Unexploded Ordnance (UXO) – A guide for the Construction Industry' Risk Management Framework

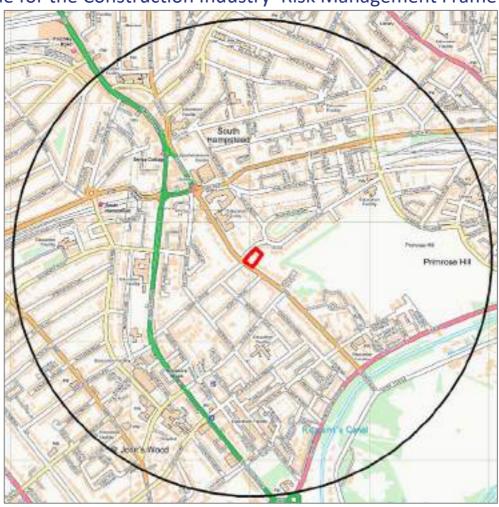

6 Alpha Project number	9313	ORIGINATOR	M. Stott
LANDMARK ORDER NUMBER	286852753_2	REVIEWED BY	L. Gregory
CLIENT REFERENCE	1942	RELEASED BY	L. Gregory
PROJECT	Avenue Road	DATE	28 th October 2021
RECOMMENDATION This Study Site requires a Detailed UXO Threat and Risk Assessment		hreat and Risk Assessment	

6 Alpha Project Number: 9313 Landmark Order Number: 286852753_2 Client Reference: 1942



UNEXPLODED ORDNANCE THREAT ASSESSMENT



STUDY SITE

The Study Site is described as "65, Avenue Road, London, NW8 6HP", and it is centred on National Grid Reference 527010, 183850.

THREAT POTENTIAL AND RECOMMENDATIONS

The potential for a UXO hazard to occur, and more specifically, the potential for unexploded WWI and WWII ordnance to exist at this site is assessed as being LIKELY (*Figure 2*).

In accordance with CIRIA C681 Chapter 5 on managing UXO risks, 6 Alpha recommends that the next stage in the risk management framework is:

DETAILED UXO THREAT & RISK ASSESSMENT

We would be pleased to provide this service, please contact *Envirocheck* for further details:



REPORT SUMMARY

During WWII, the Study Site was situated within *Hampstead Metropolitan Borough*, which recorded 35 High Explosive (HE) bomb strikes per 100 hectares; a "moderate" level of bombing.

Luftwaffe aerial reconnaissance photography associated with the Study Site identified *St Johns Wood Barracks* (285m south-west), a *Reservoir* (340m south-east) and *West Hampstead Station* (555m north-west) as primary bombing targets.

Air Raid Precaution (ARP) records did not identify any HE bomb strikes on-site. Nonetheless, five HE bomb strikes were recorded within 130m of the Site, the closest being 60m west-north-west. In addition, three unexploded bombs (UXBs) were also recorded within 960m of the Site, the closest being 845m north-east.

London County Council (LCC) bomb damage mapping documented 'Blast Damage; Minor in Nature' to structures on-site and immediately south of the Study Site boundary. In addition, an analysis of post-war mapping identified clearance areas 20m west and 'Ruins' 115m east and 140m west of the Study Site boundary, which an analysis of LLC mapping confirmed is indicative of further bomb damage.

Given that both bombing and bomb damage were recorded in close proximity; it would suggest that further action is warranted to address the potential for UXO encounter.

USING THIS REPORT

This Preliminary Assessment is designed to inform environmental and construction professionals of the potential threat of military related explosives and/or ordnance on, or in, the vicinity of the Study Site.

This assessment is designed to be employed as a site-screening tool to meet with the requirement of Phase One of the *CIRIA UXO Risk Management Framework*; there are two broad prospective outcomes; either the threat level requires a detailed threat & risk assessment; or no further action is required. In the former instance we can provide a report within 10 working days (or more quickly upon application).

Two figures accompany the report, the *Second World War* (WWII) High Explosive (HE) Bomb Density and the final Probability of UXO Encounter. The purpose of this approach is to demonstrate that whilst bomb density statistics give an indication for WWII bombing, they should not be relied upon exclusively to generate a holistic assessment.

For further information, please contact *Envirocheck*:

relephone

Telephone: +44 (0)844 844 9952

Website: http://www.envirocheck.co.uk

Email: customerservice@envirocheck.co.uk

6 Alpha Project Number: 9313 Landmark Order Number: 286852753_2



UNEXPLODED ORDNANCE THREAT ASSESSMENT



Data Findings			
Threat Source		Detail	
(within 1,000m)	Identified	Comments	
Military Facilities/Activity	~	St Johns Wood Barracks was located 285m south-west, and Regents Park, 685m south, was used for RAF training purposes during WWII.	
Ordnance Manufacture/Storage	×	None recorded within 1,000m.	
WWII Decoy Bombing Sites	×	None recorded within 1,000m.	
WWII Defensive Features	~	An Anti-Aircraft Artillery battery was located 550m east of the Study Site boundary.	
WWII <i>Luftwaffe</i> Designated Bombing Targets	~	Luftwaffe aerial photography identified three primary bombing targets, the closest being St Johns Wood Barracks (285m south-west).	
WWII Bomb Strikes (Study Site Boundary)	×	ARP records did not identify any HE bomb strikes on-site.	
WWII Bomb Strikes (Wider Area)	~	HE bomb strikes were identified 60m west-north-west, 95m north-east, 100m north-west, 115m north-east and 130m north-east.	
WWII Bomb Damage	~	Official bomb damage mapping recorded 'Blast Damage; Minor in Nature' to structures on-site.	
Abandoned Bomb Register	×	The official abandoned bomb list did not identify any abandoned bombs located on-site or within 1,000m of the Study Site boundary.	
Potential Threat Sources	~	The most probable UXO threat is posed by WWII <i>German</i> HE bombs, whilst IBs and <i>British</i> AAA projectiles pose a residual threat.	
WWII Bombing Density Per 100 Hectares	~	The Study Site was located within <i>Hampstead Metropolitan Borough</i> , which recorded 35 HE bomb strikes per 100 hectares.	

IMPORTANT NOTES

- 1. The term 'Preliminary UXO Threat Assessment' has been used to describe this report, to fall in line with the CIRIA C681 guidelines. Whilst the term 'Risk' can be justifiably used at this stage, the reader should note that the 'Consequence' function of 'Risk' is not considered. Should it be required, this would be addressed in the 'Detailed UXO Threat & Risk Assessment' (Stages 2 and 3).
- 2. This report is accurate and up to date at the time of writing.
- 3. The assessment levels have been generated from historical data and third party sources. Where possible *6 Alpha* have sought to verify the accuracy of such data, but cannot be held accountable for inherent errors that may be in third party data sets (e.g. *National Archives* or library sources).
- 4. 6 Alpha have exercised all reasonable care, skill and due diligence in producing this service.
- 5. Whilst every effort has been used to identify all potential UXO/explosive threats, there were a number of private facilities, which may not have released privately recorded information concerning UXO/explosive threats into the public domain. It is therefore possible that some of the aforementioned sites may not be included within the database.

6 Alpha Project Number: 9313 Landmark Order Number: 286852753_2 Client Reference: 1942



65, AVENUE ROAD, LONDON, NW8 6HP

BOMB SEARCH

WWII High Explosive Bomb Density





65, AVENUE ROAD, LONDON, NW8 6HP

BOMB SEARCH

Probability of UXO Encounter





Appendix D: Environment Agency Information Request

alex.corrigan@a2-studio.com


From: alex.corrigan@a2-studio.com
Sent: 29 October 2021 13:04

To: 'enquiries@environment-agency.gov.uk'

Subject: Information Request for 52 Avenue Road, London.

Hi,

A-Squared are preparing a geo-environmental desk study report. Please can you provide the requested information (see below) held by the Environment Agency (EA) with respect to the subject site shown on the below plans, if information is available. The site boundary is as shown by the red line. The site is located at 52 Avenue Road, London, NW8 6HP.

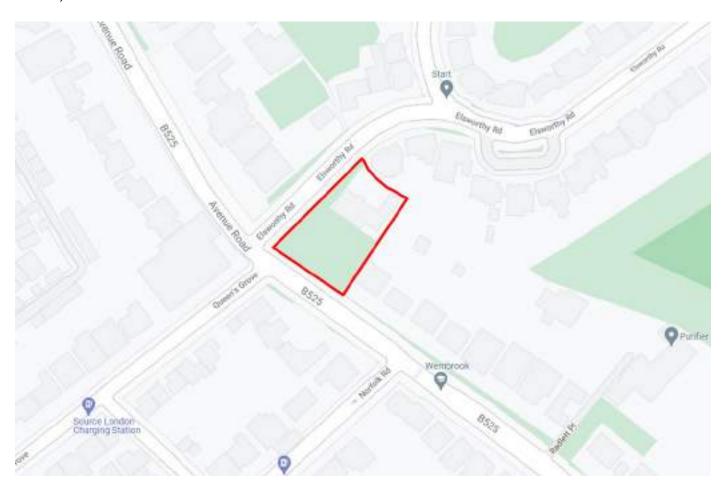

The site is located at approximate national grid reference: 527010, 183850.

The information specifically requested is any information held by the EA on the following bullet points, either for the site itself or within 500 m of the site boundary:

(information on the distance and direction to each identified feature is also requested)

- Background groundwater and surface water quality;
- Groundwater flow direction (for the various geological units) and general hydrogeological site setting / hydrogeological parameters;
- Licenced water abstractions (surface and groundwater) and details of the geological unit each abstracts from;
- Groundwater Source Protection Zones (SPZs);
- Licenced Discharge Consents;
- Records of any pollution incidents and remediation subsequently undertaken;

- Records of any 'Special Sites' as per Part 2a (EPA 1990);
- Details of any sites under consideration for investigation as a potential 'Special Site' as per Part 2a (EPA 1990);
- Records of current or historical landfill sites or waste sites;
- Details of any lined surface watercourses;
- Details of any culverted watercourses;
- Historical land uses (specifically for the site or immediately adjacent to it rather than within 500 m, in this case); and
- Any ground investigation data for the site or immediately surrounding area.

Kind regards, Alex

Alex Corrigan

Graduate Engineer BEng(Hons)



T: 020 7620 2868 | M: 078 0059 4755



Appendix E: Camden Council Information Request


alex.corrigan@a2-studio.com

From: alex.corrigan@a2-studio.com
Sent: 07 November 2021 22:21
To: 'foi.csf@camden.gov.uk'

Subject: Information Request for 52 Avenue Road, NW8 6HP

Hello,

A-Squared Studio Engineers Ltd are preparing a geo-environmental desk study report. Please can an Environmental Health Officer provide the requested information (see below) held by the local authority with respect to the subject site shown on the below plans, if information is available. The site boundary is as shown by the red line. The site is located on Avenue Road, NW8 6HP.

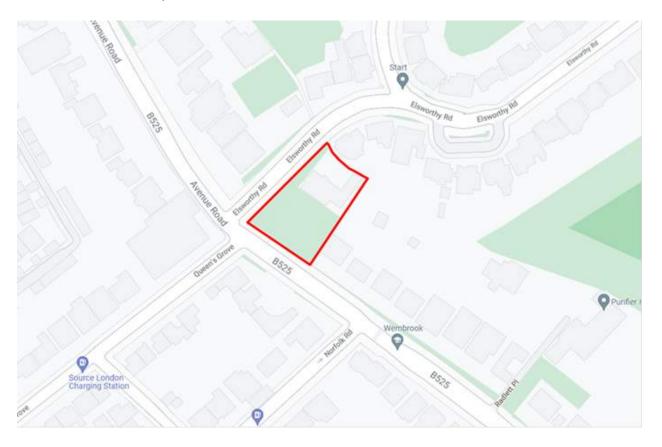

The site is located at approximate national grid reference: 527010, 183850.

The information specifically requested is any information held by the local authority on the following bullet-points. Information for the site or within 500 m of the site is generally requested. Information on the distance and direction of each identified feature from the site is also requested.

- Historical land uses (specifically for the site or immediately adjacent to it rather than within 500 m, in this case);
- Licenced private water abstractions (surface or groundwater) and details of the geological unit each abstracts from and water use;
- Recorded pollution incidents and the incident response / remediation details;
- Any Part 2a sites (EPA 1990);
- Any sites being considered for investigation under Part 2a (EPA 1990);
- Records of current or historical landfills and waste sites; and
- Any ground investigation data (specifically for the site or immediately adjacent to it rather than within 500 m, in this case).

Kind regards, Alex

Alex Corrigan

Graduate Engineer BEng(Hons)




T: 020 7620 2868 | M: 078 0059 4755



A-squared Studio Engineers Ltd

One Westminster Bridge Rd London, SE1 7XW

> 020 7620 2868 contact@a2-studio.com www.a2-studio.com

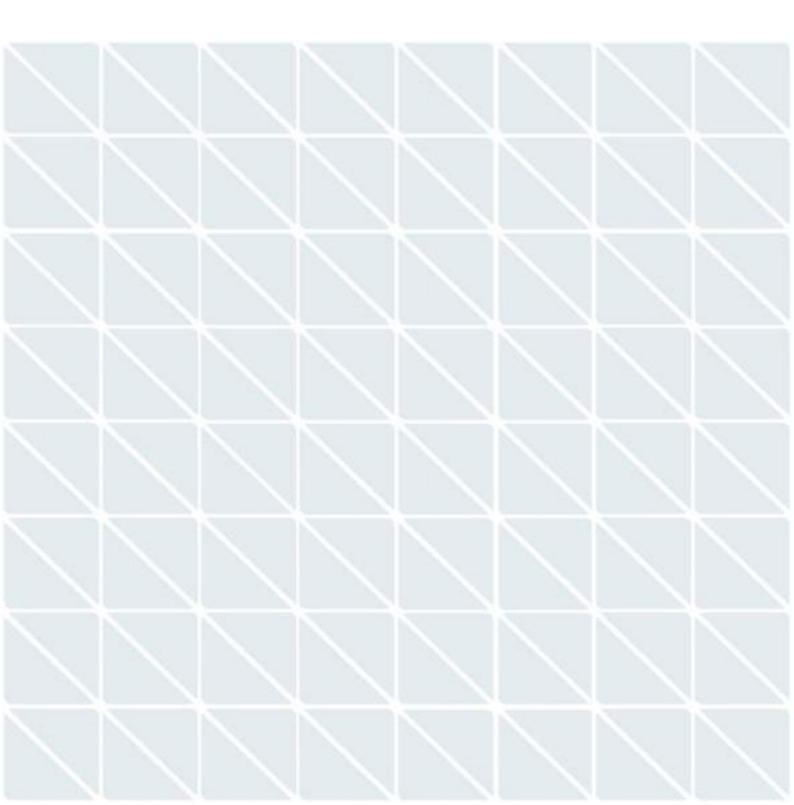




A2 Site Investigation Limited

One Westminster Bridge Rd London, SE1 7XW

020 7021 0376 info@a2-si.com www.a2-si.com

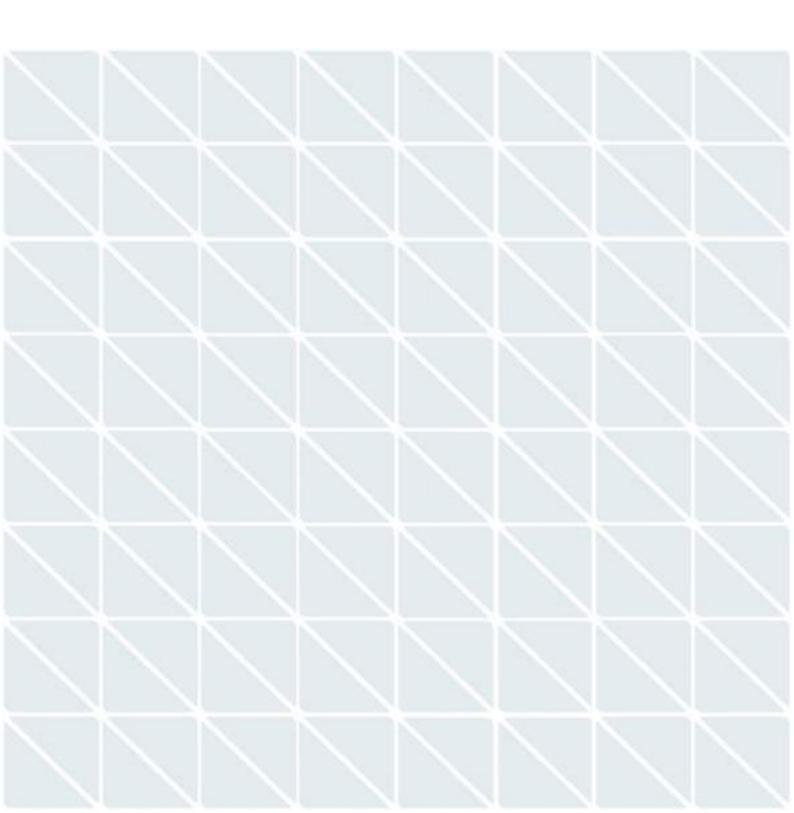




Appendix B: Proposed Development Plans





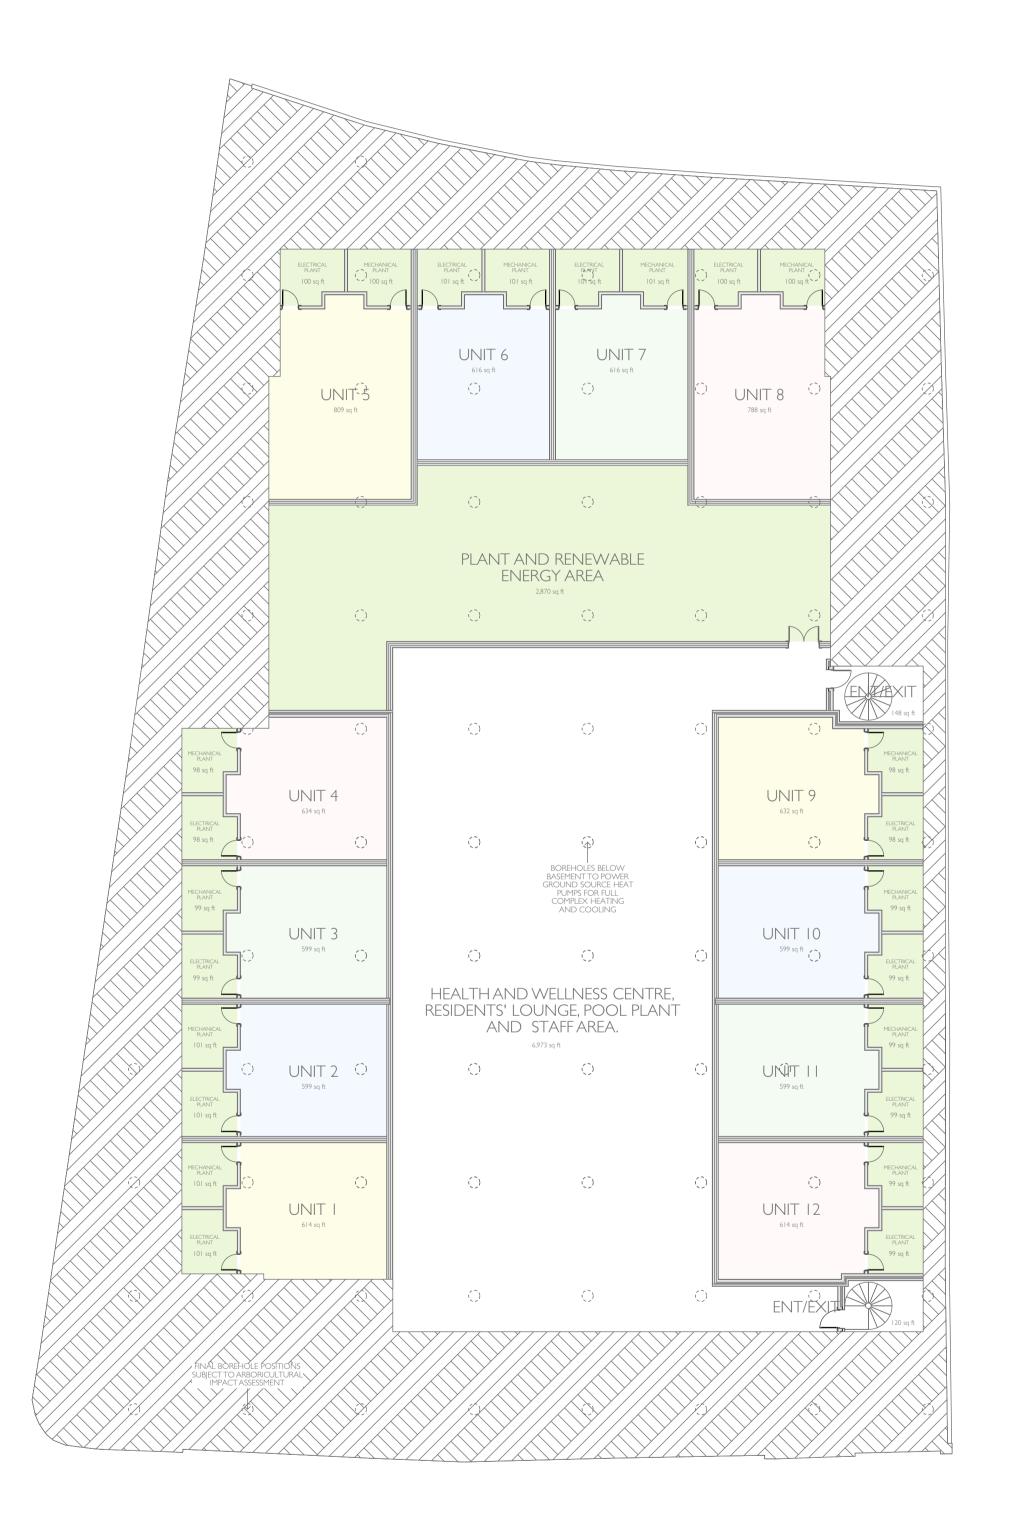

PLANNING



WWW.DOMVSLONDON.COM

PROJECT: AVENUE GARDENS

TITLE:

PROPOSED BASEMENT PLAN - 12 UNIT SCHEME


Date: APRIL 2022

Scale: 1:200 @ A1

Drawn: SDK

DRAWING NUMBER: 208-253B



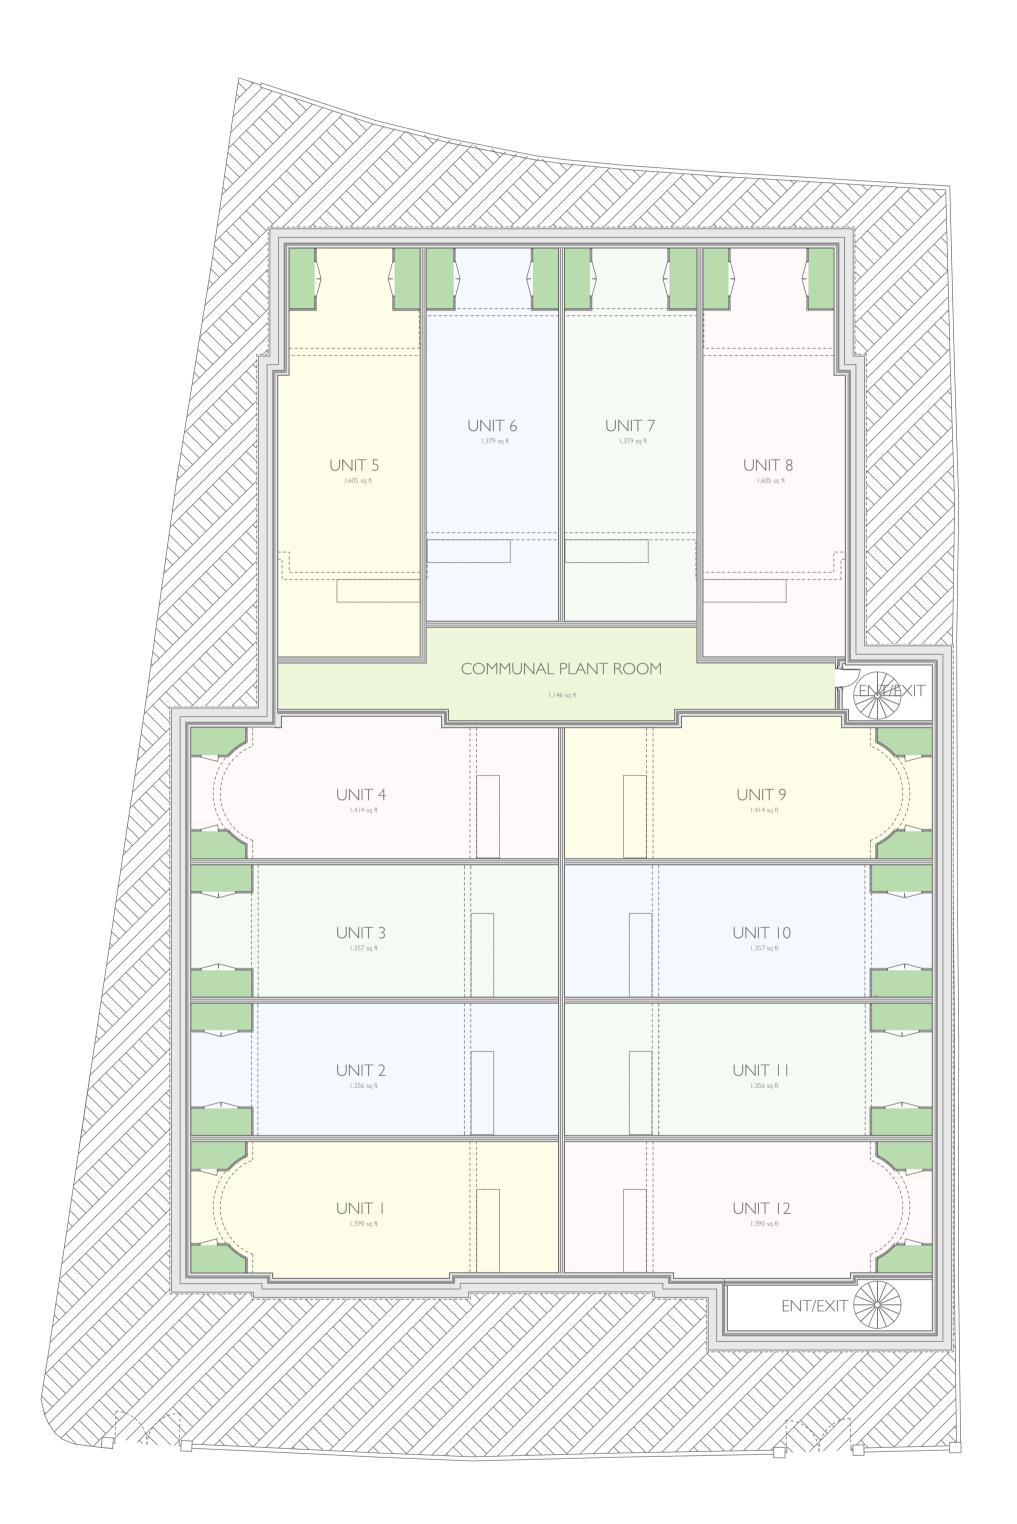

PLANNING



<u>www.domvslondon.com</u>

PROJECT: **AVENUE GARDENS**

TITLE: PROPOSED LOWER GROUND FLOOR PLAN - 12 UNIT SCHEME

Date: APRIL 2022

Scale: 1:200 @ A | Drawn: SDK

DRAWING NUMBER: 208-254B












ELEVATION I



ELEVATION 2




ELEVATION 3

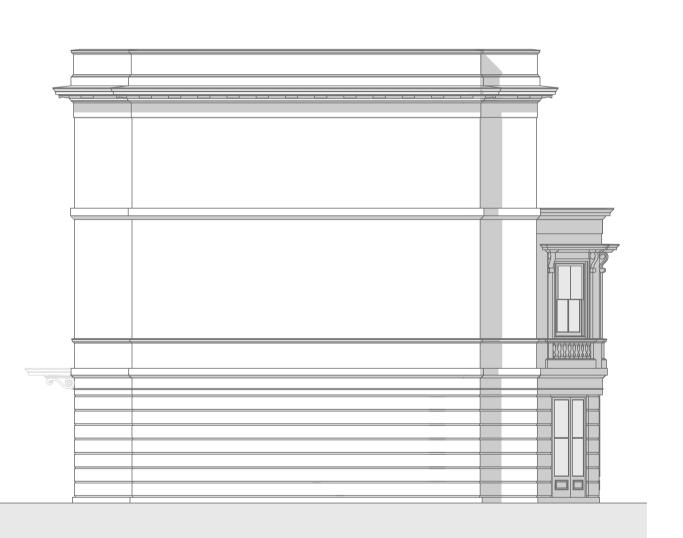

ELEVATION 4

WEST BUILDING 1:100

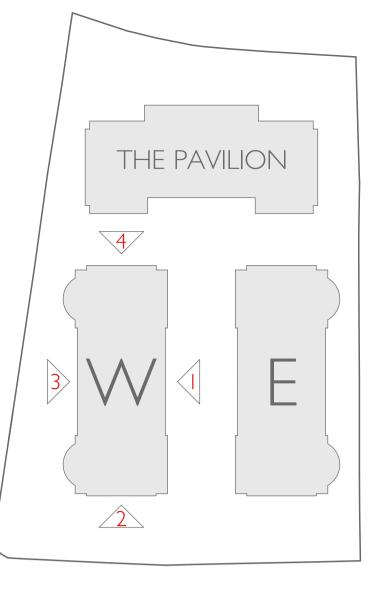



PLANNING



WWW.DOMVSLONDON.COM

PROJECT: **AVENUE GARDENS**

TITLE: WEST BUILDING PROPOSED ELEVATIONS - 12 UNIT SCHEME

Date: APRIL 2022


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Drawn: SDK


DRAWING NUMBER: 208-272B







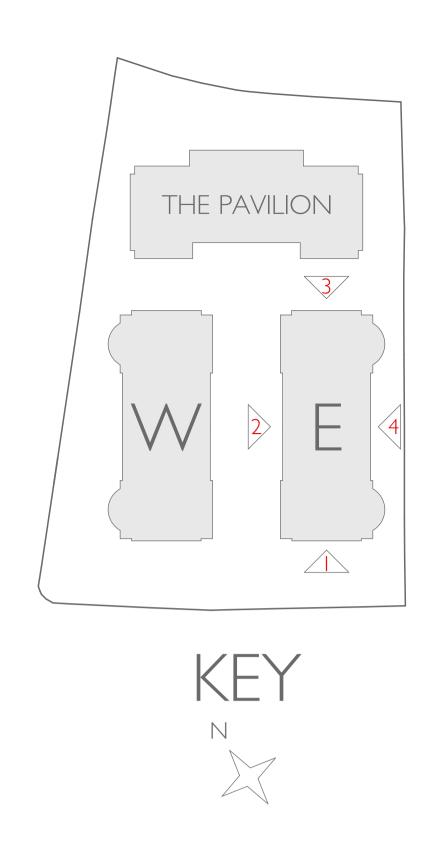

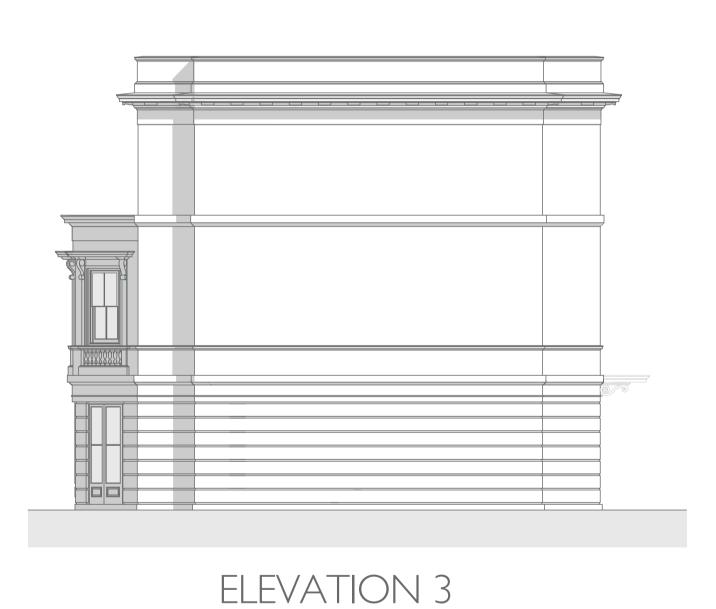



ELEVATION 4

EAST BUILDING 1:100

PLANNING



<u>www.domvslondon.com</u>

PROJECT: AVENUE GARDENS

TITLE:
EAST BUILDING
PROPOSED ELEVATIONS
- 12 UNIT SCHEME

Date: APRIL 2022

Scale: |: | 00 @ A |

Drawn: SDK

DRAWING NUMBER: 208-273B