

## PROPOSED DIGITAL ADVERTISING DISPLAY, 226 CAMDEN HIGH STREET, CAMDEN TOWN, LONDON, NW1 8QS

## Highway Safety Note

[VN212055]

#### Introduction

- 1. Vectos has been commissioned by London Lites Limited to support an advertisement application relating to a proposal for a digital advertising display at 226 Camden High Street in Camden Town, London. The proposal is to erect a 2m wide x 3m long static LED digital advertising display panel at the site.
- 2. The proposal site is located on the southern elevation of 226 Camden High Street, adjacent to the fourway signalised junction of Camden High Street / Hawley Crescent / Jamestown Road. The display will face in a southerly direction towards Camden High Street (S) and the bottom of the advertising screen is approximately 6m above ground level. The site location is shown below in **Figure 1**.



Figure 1 – Site Location

0161 228 1008



### Planning Background

3. The site has a long-established history of hosting advertisement displays at this location; a 48-sheet internally illuminated sign was in situ from the early 1990's and consent was later granted for a digital 48-sheet lightbox display that was in situ from around 2008, before it was removed in 2020. The relevant planning applications associated with the planning consents at the site are set out below:

2003/0565/A – The continued display of 3 internally illuminated signs on the front and site elevations.

2005/0934/P – Use of flank wall of the premiss for the display of an advertisement panel (6m x 3m) in accordance with the conditions and limitations of Class 13 of Schedule 3 to the Town and Country Planning (Control of Advertisements) Regulations.

2006/2766/A – Display of high level 48-sheet internally illuminated advertisement lightbox.

4. An application for the proposed 2m wide x 3m high digital advertising display has been submitted to the Camden London Borough Council (CLBC) *(application reference: 2021/0751/A)*. However, since the applications original submission in March 2021, the display has been repositioned in the centre of the gable end of 226 Camden High Street. This Highway Safety Note sets out a review of the proposal in terms of the highway safety implications and will be resubmitted together with the revised plans. The full plans for the proposed 2m x 3m digital display are attached as **Appendix A**.

#### Proposal Site Review

- 5. The proposal site is located adjacent to the Camden High Street / Hawley Crescent / Jamestown Road signalised junction, on the southern elevation of 226 Camden High Street. The surrounding area is predominantly commercial in nature, and the highway network is subject to a 20mph speed limit and is lit.
- 6. Hawley Crescent is the eastern arm of the adjacent signalised junction and is one-way only in a westbound direction. It is considered that the location of the advertising screen behind the footway on the northside of the carriageway and the elevated position will not interact with the sightline of drivers proceeding on this arm and there will be no safety conflict or interaction with the traffic signals.
- 7. Jamestown Road is the western arm of the adjacent signalised junction, and the approach is in an eastbound direction. Due to the side-on approach from this arm, the level of distraction from the proposed digital display would be minimised due to its acute angle. From this approach drivers can only make an unopposed left turn, with this left-turn only manoeuvre representing an uncomplicated road layout where the demands on the driver are lower, and therefore the siting of the digital display is not considered to be a conflict in relation to the safe operation of the Jamestown Road approach to the signalised junction. There is no interaction with the existing traffic signal heads on this approach.
- 8. Camden High Street (S) is a one-way only route, travelling northbound. On approach to the signalised junction drivers can either continue straight across onto Camden High Street (N) or turn left onto Jamestown Road. Camden High Street (S) is directly towards the proposal site and due to the straight carriageway alignment and wide layout with the buildings well setback, it is considered that approaching drivers will have a clear sight line towards the proposal site so that the advertising



screen and road / junction ahead could be assimilated at the same time without driver attention being diverted away from the road.

9. Camden High Street (S) comprises of two primary traffic signals at the stop line and a secondary traffic signal located at the other side of the junction. It is considered that the advertising screen position and the locations of the primary and secondary traffic signals on this arm will not interact in respect of approaching drivers at the 25m Stopping Sight Distance (critical decision-making distance) for the 20mph approach speed, and there will be no safety conflict – refer to **Figure 2**. Also, the approximate 6m height of the digital display on the gable end will be above the traffic signal heads, thus ensuring no interaction.

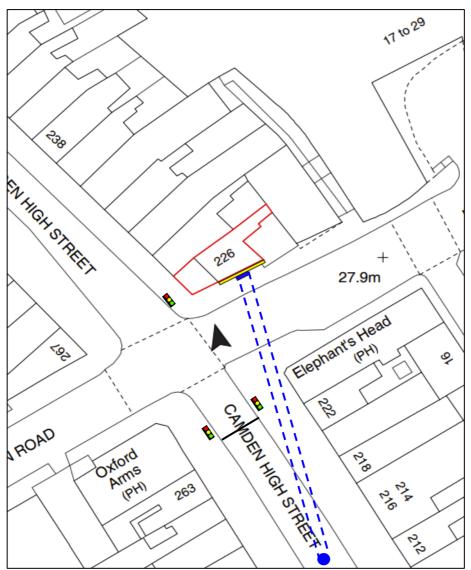


Figure 2 – Sketch of Driver Visibility Splay 25m from Junction Stopline

10. As discussed, a digital 48-sheet display panel (6m x 3m) occupied the site between 2008-2020. The new proposals will feature a reduced screen area (2m x 3m) and will be positioned more centrally on the gable end of No. 226 Camden High Street. As is shown in **Figure 3**, the proposals will improve



the previous situation, now avoiding conflict or overlap with the traffic signals as drivers approach the stop line on the Camden High Street (S) approach to the signalised junction.



Figure 3 – View to Previous Display in Situ 2008-2020 Vs Proposal Location (outlined in red)

- 11. Camden High Street (N) will not interact with the digital display as this approach is one-way northbound at the Camden High Street / Hawley Crescent / Jamestown Road signalised junction.
- 12. In conclusion, the proposals will not create an unacceptable impact in terms of driver distraction and risk to road safety for traffic passing the proposal site at the Camden High Street / Hawley Crescent / Jamestown Road signalised junction.
- 13. In terms of the pedestrian environment in the vicinity of the site, there are north, south, east and west desire lines through this area with footways on all approaches and controlled crossings provided across the four arms of the Camden High Street / Hawley Crescent / Jamestown Road signalised junction. There are facilities in place to ensure that pedestrians can cross the signalised junction adjacent to the proposal site in a controlled and safe manner. Also, the approximate 6m height of the digital display on the gable end will be above the pedestrian green and red man signal for northbound pedestrian movements across the Hawley Crescent arm of the signalised junction towards the proposal site. As a result of this arrangement, the proposal site is not going to conflict or interact with this controlled crossing.
- 14. It is concluded that the digital advertising display proposal would not raise any public safety issues for pedestrians.



#### **Proposed Advertising Controls**

- 15. The following planning conditions are proposed by the applicant to control the operation of the digital advertising display to ensure that the screen operates in a safe manner:
  - The display will be controlled by conditions in accordance with the Institution of Lighting Professionals 'Brightness of Illuminated Advertisements' (2015) guidance, with night time luminance limited to 300cd/m2 so as not to cause glare.
  - The advertising screen shall not display any moving, or apparently moving, images.
  - The sequential advertisements shall not change more than once every 10 seconds.
  - Any sequential change between advertisements will take place over a period no greater than one second unless otherwise agreed with the Local Authority.

#### Accident Data Review

- 16. In order to examine whether the digital advertising display at the proposal site is likely to cause a safety concern, accident data from Transport for London (TfL) for the five-year period from 1<sup>st</sup> March 2015 to 1<sup>st</sup> March 2020 has been obtained (excluding Covid-19).
- 17. A plan of accident locations from this five-year period is shown below in **Figure 4**, while the full TfL accident report has been included as **Appendix B** to this document.

# vectos.

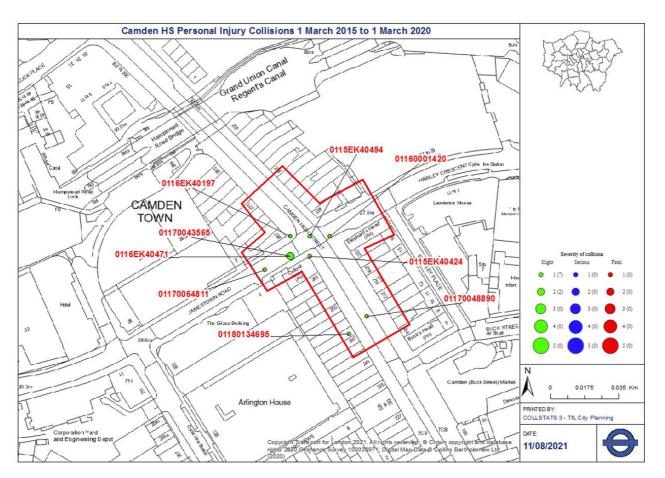


Figure 4 – Locations of Accidents in the Vicinity of the Proposal Site Source: Transport for London

- 18. This accident data shows that a total of nine accidents occurred in the five-year period, with all accidents being slight in severity.
- 19. Following a review of the TfL data, it is considered that the following accidents are not relevant in the context of the proposal for the south facing digital advertising display towards Camden High Street (S).
  - Accident 1170064811: This accident occurred on Jamestown Road and involved a cyclist as it collided with a parked / parking car. The direction of travel was westbound along Jamestown Road and hence the proposal would not have been in view at this location.
  - Accident 0115EK40494: This accident occurred as a pedestrian stepped into the road to confront a vehicle being abusive, when the vehicle turning left from Camden High Street onto Jamestown Road clipped the pedestrian. The direction of travel at the point the collision occurred and the circumstances that surround this accident make it unrelated to the proposal.

# vectos.

- Accident 0116EK40197: This accident was a rear-end shunt involving two vehicles as they were travelling from Camden High Street (S) onto Camden High Street (N). On review of the accident location the vehicles would have passed the proposal site.
- Accidents 0116EK40471 and 1170043565: both of these accidents occurred as a vehicle travelled westbound Jamestown Road after exiting Camden High Street / Hawley Crescent / Jamestown Road signalised junction and collided with a pedestrian crossing the road. However, the location of the accidents to the west of the signalised junction means that the proposal site would be unlikely to be a contributory factor to these accidents.
- 20. Summaries and conclusions of the <u>related</u> accidents to the proposal site are provided below.
  - Accident 0115EK40424: This accident occurred on the corner of Camden High Street / Jamestown Road. This accident occurred as a pedestrian walked out on a red man into the path of a motorcycle and the motorcyclist lost control. A review of the accident location shows that the pedestrian could have had view of the proposal site.
  - Accident 1170048890: This accident occurred on Camden High Street (S) and involved a bus and cyclist. As the direction of travel is northbound only on this approach the proposal would be in view.
  - Accident 1180134695: This accident occurred on Camden High Street (S), upstream from the proposal site and where the display would be in view. This accident occurred as a motorcycle moved off from the side of the road to proceed along the carriageway, when he hit an elderly pedestrian crossing the road, not at a crossing point.
  - Accident 1160001420: this accident occurred as a motorcyclist approached the junction on Hawley Crescent and collided with a pedestrian crossing the road. It is unclear who was at fault and the pedestrian could have had view of the advertising display, therefore it has been regarded as relevant.
- 21. There has been a total of four accidents in the study area during the five-year period reviewed that are considered relevant to the proposal site. There has been a south facing digital advertising display in operation at the site during this time. Given this low frequency of accidents, it is considered that the study area relevant to the proposal site has a good safety record, including the Camden High Street (S) approach to the adjacent signalised junction.
- 22. A further review of the Crashmap Database has been undertaken to understand if the erection of the digital 48-sheet lightbox display in 2008 impacted highway safety on the adjoining network. Vectos has analysed the 5-year period prior and the 5-year period preceding the installation of the digital display, as well as all data available from 2008 2020 (the time when the digital advertisement was in situ) refer to **Table 1.**



Year	No. of Accidents in Study Area	Severity	No. of Accidents (Yearly Average)
	Prior to Installation	on of Digital Sheet Panel	
2003-2007	12	11 Slight, 1 Serious	2.4
	Post Installation	of Digital Sheet Panel	
2008-2012	9	8 Slight, 1 Serious	1.8
2008-June 2020	21	20 Slight, 1 Serious	1.7

#### Table 1 – Accident Rate Analysis between 2003 and June 2020

- 23. As is presented in **Table 1**, the accident analysis shows that average annual collision rates in the vicinity of the site appear to have decreased following the introduction of the digital 48-sheet lightbox display in 2008.
- 24. Considering all of the above accident data, it is concluded that the proposal site for the single-sided digital advertising display is in a good location in terms of the recent accident record in the vicinity and it is not likely to cause a road safety problem.

#### Conclusions

- 25. Vectos has been commissioned by London Lites Limited to support an advertisement application relating to a proposal for a digital advertising display at 226 Camden High Street in Camden Town, London. The proposal is to erect a 2m wide x 3m long static LED digital advertising display panel at the site.
- 26. The proposal site has been reviewed with due consideration given to the following factors, and the assessment has demonstrated that the proposed digital advertising display:
  - Is in a location where the principle of advertising has long been established.
  - Does not conflict with the safe operation of the adjacent Camden High Street / Jamestown Road / Hawley Crescent four-arm signalised junction.
  - Does not interact with the traffic signal heads at the adjacent signalised junction on the key approaches to the proposal site.
  - Benefits from a good sightline on the Camden High Street (S) approach.
  - Does not present a risk in terms of the pedestrian environment.
  - Will not create an unacceptable impact in terms of driver distraction and risk to road safety for traffic passing the proposal site.
  - Will be subject to appropriate controls to ensure the safe operation.



- Is in a good location in terms of the recent accident record in the vicinity and the digital advertising display is not likely to cause a road safety problem.
- 27. Taking into account the findings of this Highway Safety Note, the applicant considers that the proposed digital advertising display would not have an unacceptable or severe impact on highway safety at this location and is therefore not contrary to paragraph 111 of the National Planning Policy Framework (July 2021).
- 28. In conclusion, the proposed 2m wide x 3m long digital advertising display at 226 Camden High Street in Camden Town, London, will not adversely impact on driver or pedestrian distraction, and so does not present a risk to road safety or a danger to road users. It is therefore considered that there are no significant transport reasons why the development proposals should not be granted planning permission.



Appendix A


Vectos Oxford Place 61 Oxford Street Manchester M1 6EQ

# SITE PLAN




Proposed Digital DisplayMuralSite Boundary

Site:	Proposal:	Drawing:	Date:	Dwg. No.	Scale: 1:500@A3				
226 Camden High Street, Camden Town, London NW1 8QS	48 Sheet Backlight Panel	Site Plan	03/08/2021	PY3995/002 rev C	0m	10m	20m	30m	40m

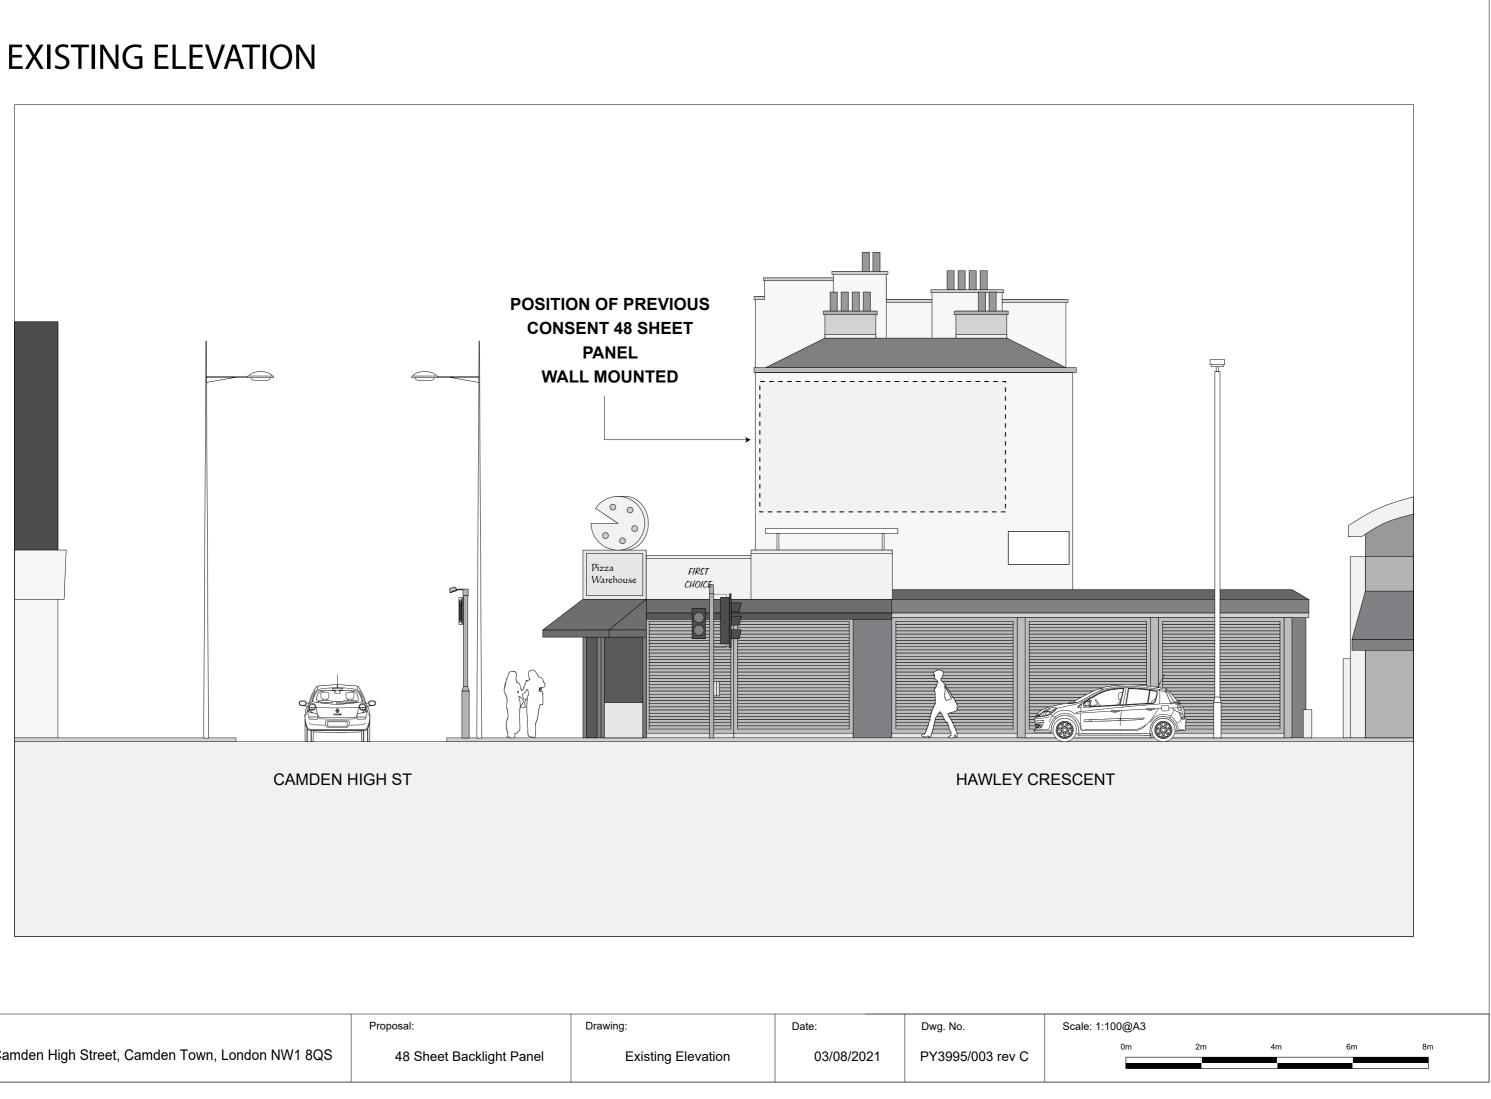


Site:	Proposal:	Drawing:	Date:	Dwg. No.	Scale: 1:100@A
226 Camden High Street, Camden Town, London NW1 8QS	48 Sheet Backlight Panel	Existing Elevation	03/08/2021	PY3995/003 rev C	0m

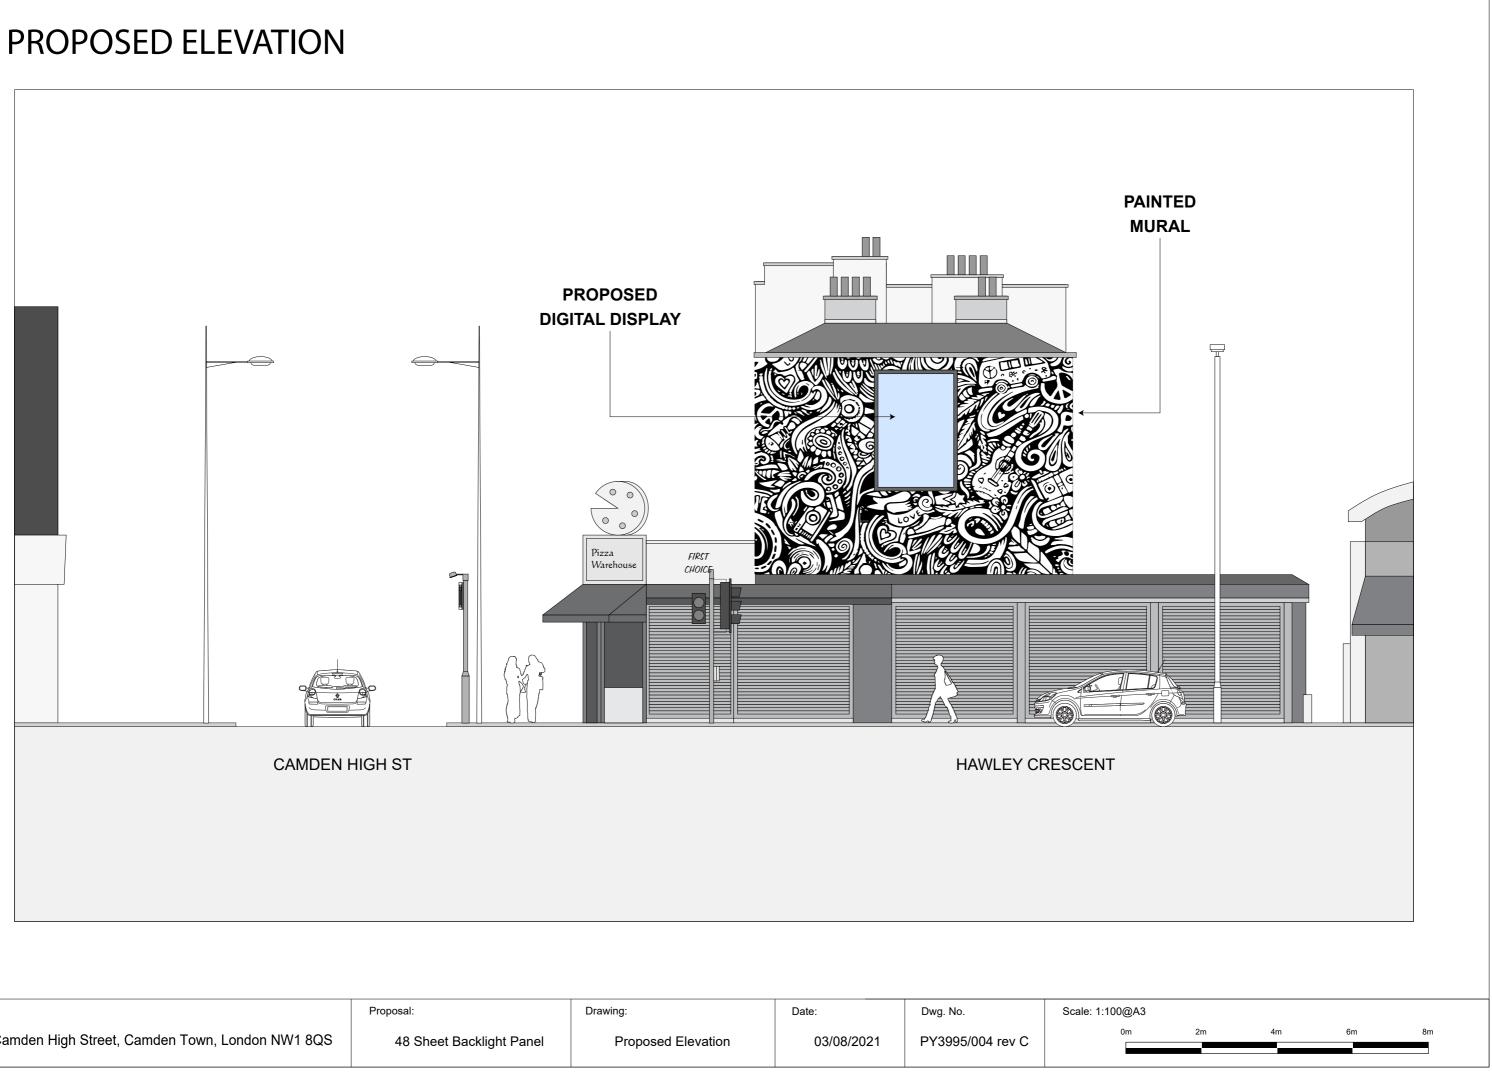


Site:	Proposal:	Drawing:	Date:	Dwg. No.	Scale: 1:100@/
226 Camden High Street, Camden Town, London NW1 8QS	48 Sheet Backlight Panel	Proposed Elevation	03/08/2021	PY3995/004 rev C	0m

# STANDARD SPECIFICATIONS

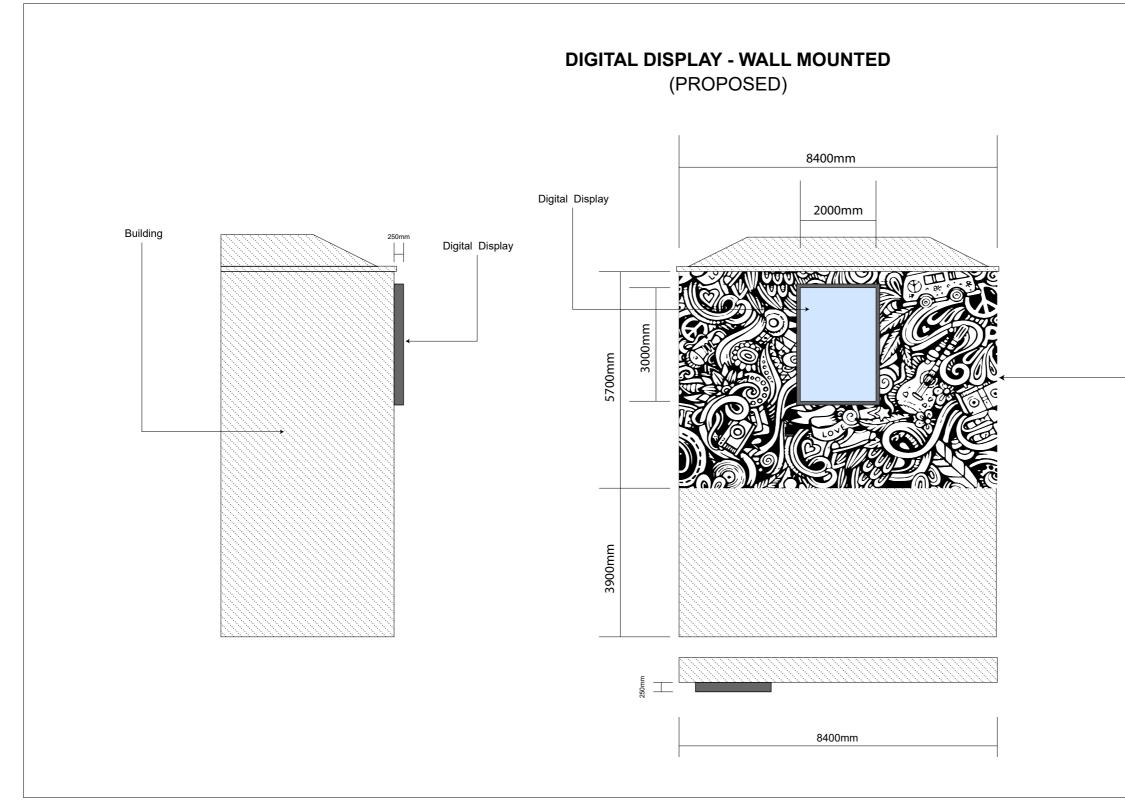

Site:	Proposal:	Drawing:	Date:	Dwg. No.	Scale: 1:100@A
226 Camden High Street, Camden Town, London NW1 8QS	48 Sheet Backlight Panel	Standard Specifications	03/08/2021	PY3995/005 rev C	0m

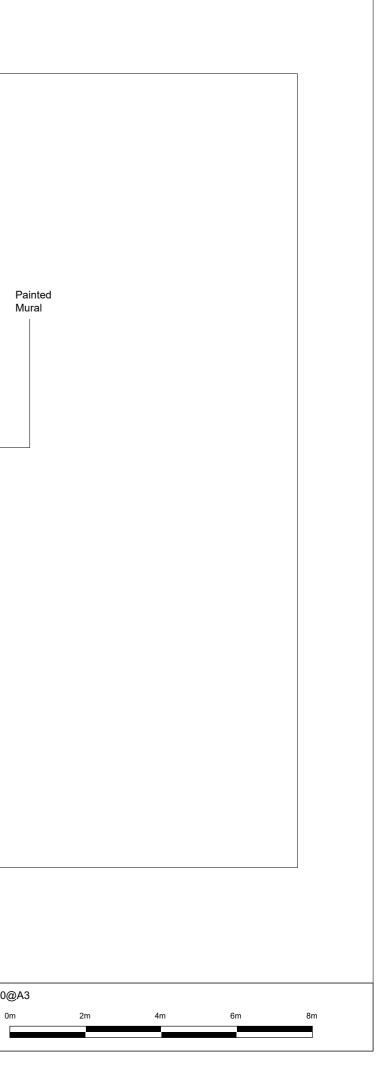



# Appendix B

Vectos Oxford Place 61 Oxford Street Manchester M1 6EQ

# Camden High Street Personal Injury Collisions 1st Mar2015-1st Mar 2020

Summary of Collisions Selected Site Reference and Description x GIS AREA Camden HS(P)

Date Period 60MTS TO Feb/2020 Collision Count 9

The description of how the collision occurred and the contributory factors are the reporting officer's opinion at the time of reporting and may not be the result of extensive investigation. Note that self-reported collisions (introduced in September 2016) may have limited information. Descriptions have been automatically redacted to remove all personally identifiable information, but should you receive any in error please inform the Collisions Data Team as soon as practical. Self-reported collisions introduced in September 2016 may have limited information and tend to be lower in quality than police reports. The introduction of online self-reporting has made it easier for members of the public to report collisions to the police. There have been year on year increases in self-reports since this was introduced. This has contributed to an overall increase in the number of casualties reported on London's roads.

Pedestrian		5	56%		Fatal		0	0%	%					
Wet		0	0%		Serious		0	0%	%					
Dark		3	33%		Slight		9	10	00%					
Please note that	at these figure	s repre	sent the numbe	r of e	collisions that re	esulted in each ty	уре о	of casualty.						
	1		2		3	4		5		6	7		8	9
Reference Day Date Time Light Conds Road Surface Severity Conflict	01180134695 MONDAY 24/09/2018 18:40 LIGHT DRY SLIGHT		01160001420 SUNDAY 13/11/2016 12:40 LIGHT DRY SLIGHT	F 0 2 C	116EK40197 RIDAY 1/04/2016 3:20 JARK SLIGHT	01170064811 MONDAY 16/10/2017 22:30 DARK DRY SLIGHT		0115EK4049/ SUNDAY 21/06/2015 16:00 LIGHT DRY SLIGHT	4	01170048890 TUESDAY 04/07/2017 22:45 DARK UNKNOWN (S/R) SLIGHT	01170043565 SUNDAY 18/06/2017 18:20 LIGHT DRY SLIGHT		0116EK40471 SUNDAY 03/07/2016 17:05 LIGHT DRY SLIGHT	0115EK40424 SUNDAY 31/05/2015 13:20 LIGHT DRY SLIGHT
Ped Location Contributory (* denotes pre- 2005)	0 808 C001 B		50M 802 C001 A 803 C001 A 808 C001 A 804 C001 B		05 V002 A 08 V002 A	405 V002 A		0 407 V001 602 V001 601 V001 803 C001	A A		X 802 C001 A		50M 405 V001 A 802 C001 A	410 V001 A 802 U000 A 808 U000 A 804 U000 A
Easting/Northing	528810 18401	0	528800 184060	5	28780 184060	528767 184043		528790 1840	060	528819 184019	528780 18405	0	528780 184050	528790 184050

SUMMARY OF COLLISIONS SELECTED SITE REFERENCE AND DESCRIPTION X GIS AREA CAMDEN HS(P)

DATE PERIOD 60MTS TO FEB/2020 COLLISION COUNT

THE DESCRIPTION OF HOW THE COLLISION OCCURRED AND THE CONTRIBUTORY FACTORS ARE THE REPORTING OFFICER'S OPINION AT THE TIME OF REPORTING AND MAY NOT BE THE RESULT OF EXTENSIVE INVESTIGATION. NOTE THAT SELF-REPORTED COLLISIONS (INTRODUCED IN SEPTEMBER 2016) MAY HAVE LIMITED INFORMATION. DESCRIPTIONS HAVE BEEN AUTOMATICALLY REDACTED TO REMOVE ALL PERSONALLY IDENTIFIABLE INFORMATION, BUT SHOULD YOU RECEIVE ANY IN ERROR PLEASE INFORM THE COLLISIONS DATA TEAM AS SOON AS PRACTICAL. SELF-REPORTED COLLISIONS INTRODUCED IN SEPTEMBER 2016 MAY HAVE LIMITED INFORMATION AND TEND TO BE LOWER IN QUALITY THAN POLICE REPORTS. THE INTRODUCTION OF ONLINE SELF-REPORTING HAS MADE IT EASIER FOR MEMBERS OF THE PUBLIC TO REPORT COLLISIONS TO THE POLICE. THERE HAVE BEEN YEAR ON YEAR INCREASES IN SELF-REPORTS SINCE THIS WAS INTRODUCED. THIS HAS CONTRIBUTED TO AN OVERALL INCREASE IN THE NUMBER OF CASUALTIES REPORTED ON LONDON'S ROADS.

X GIS AREA CAME	DEN HS(P)				60MT	S TO FEB/2020				
1 0115EK40424	SUN 31/05/2015	13.20	LIGHT		) J/W CAMDEN HIGH	ст		02 NODE 667		528790/184050
POLICE - AT SCE		ROAD-DRY	WEATHER- FINE	SINGLE CWY	CROSSROADS	AUTO SIG		PEDN PHASE AT	S	NONE IN 50M
PED WALKED OU	IT ON A RED MAN IN	ITO PATH OF V1, V	1 LOST CONTROL							
CASUALTY	001 (001)	(? YRS - M - RE	DA)	SLIGHT	DRIVER/RIDER					
VEHICLE	001 (000)	WC 51-125CC BT - NOT REQ		(? YRS - M - REDACT)		g/ahead - other	२	(NE TO SW) FRONT HIT FIRST	J/P - UNKN JCT MID	
V001	А	410 (LOSS OF 0	CONTROL)			U000	А	802 (FAILED TO	LOOK PROPERLY)	
U000	A	808 (CARELESS	S, RECKLESS OR IN	I A HURRY)		U000	А	804 (WRONG US	E OF PEDESTRIAN	CROSSING FACILITY)
2 0115EK40494	SUN 21/06/2015	16:00	LIGHT	CAMDEN HIGH S	ST J/W JAMESTOWN F	RD		02 NODE 667		528790/184060
POLICE - AT SCE	NE	ROAD-DRY	WEATHER- FINE	ONE-WAY ST	T/STAG JUN	AUTO SIG		PEDN PHASE AT	S	NONE IN 50M
PED STEPPED IN	ITO ROAD TO CONF	RONT V1 BEING A	BUSIVE, V1 TURNED	LEFT AND CLIPPED	PED					
CASUALTY	001 (001)	(21 YRS - M - RI	EDA)	SLIGHT	PEDESTRIAN		UNKNOWN	UNKNOWN/OTHI	ER	
VEHICLE	001 (000)	CAR BT - DRV NOT C	CONTACTED	(? YRS - UNKNOWN - REDACT)		TURNING - LEFT		(SW TO NW) N/S HIT FIRST	J/P - UNKN JCT CLEARED	
V001	А	407 (TOO CLOS	SE TO CYCLIST, HOP	RSE RIDER OR PEDE	STRIAN)	V001	А	602 (CARELESS	, RECKLESS OR IN A	A HURRY)
V001	А	601 (AGGRESSI				C001	А		JUDGE VEHICLE'S F	

<mark>3</mark> 01160001420	SUN 13/11/2016	12:40	LIGHT	HAWLEY CRESCI	ENT J/W CAMDEN H	IGH ST		02 NODE 667		528800/184060
POLICE - AT SCE	NE	ROAD-DRY	WEATHER- FINE	SINGLE CWY	OTHER JUN	GIVEWAY /UNCO	NT	PELICAN OR SIM	IL	NONE IN 50M
NOT KNOWN HO	W COLLISION OCCL	JRRED								
CASUALTY	001 (001)	(27 YRS - F - RE	DA)	SLIGHT	PEDESTRIAN		UNKNOWN	UNKNOWN/OTHE	ER	
VEHICLE	001 (000)	WC 126-500CC BT - DRV NOT C	ONTACTED	(27 YRS - M - REDACT)		G/AHEAD - OTHE	R	(E TO W) FRONT HIT FIRST	J/P - UNKN JCT APP	
C001	А	802 (FAILED TO	LOOK PROPERLY)			C001	А	803 (FAILED TO	JUDGE VEHICLE'S F	PATH OR SPEED)
C001	А	808 (CARELESS	, RECKLESS OR IN A	HURRY)		C001	В	804 (WRONG US	E OF PEDESTRIAN	CROSSING FACILITY)
<mark>4</mark> 0116EK40197	FRI 01/04/2016 2	23:20	DARK	CAMDEN HIGH S	T J/W JAMESTOWN I	۶D		02 NODE 667		528780/184060
POLICE - AT SCE	NE	ROAD-DRY	WEATHER- FINE	SINGLE CWY	CROSSROADS	AUTO SIG		PEDN PHASE AT	S	NONE IN 50M
V2 WENT INTO T	HE BACK OF V1									
CASUALTY	001 (001)	(30 YRS - F - RE	DA)	SLIGHT	VEH/PILLION PAX	FRONT SEAT PASSENGER				
CASUALTY	002 (001)	(10 YRS - M - RE	EDA)	SLIGHT	VEH/PILLION PAX	REAR SEAT PASSENGER				
CASUALTY	003 (001)	(6 YRS - F - RED	A)	SLIGHT	VEH/PILLION PAX	REAR SEAT PASSENGER				
VEHICLE	001 (000)	CAR BT - NOT REQ		(34 YRS - M - REDACT)		SLOWING/STOPP	PING	(SE TO NW) BACK HIT FIRST	J/P - UNKN JCT CLEARED	
VEHICLE	002 (000)	CAR BT - DRV NOT C	ONTACTED	(23 YRS - F - REDACT)		G/AHEAD - OTHE	R	(SE TO NW) FRONT HIT FIRST	J/P - UNKN JCT CLEARED	
V002	A	405 (FAILED TO	LOOK PROPERLY)			V002	А	308 (FOLLOWING	G TOO CLOSE)	

5 0116EK40471	SUN 03/07/2016	17:05	LIGHT	CAMDEN HIGH S	T J/W JAMESTOWN F	RD		02 NODE 667		528780/184050
POLICE - AT SCE	ENE	ROAD-DRY	WEATHER- UNKNOWN	SINGLE CWY	CROSSROADS	AUTO SIG		PEDN PHASE ATS	3	NONE IN 50M
V1 TURNED LEF	T AND COLLIDED W	ITH PED CROSSING	ROAD							
CASUALTY	001 (001)	(54 YRS - F - RE	DA)	SLIGHT	PEDESTRIAN		NW BOUND	FROM DRIVERS I	N/SIDE	
VEHICLE	001 (000)	CAR BT - DRV NOT C	ONTACTED	(? YRS - UNKNOWN - REDACT)		TURNING - LEFT		(SE TO SW) FRONT HIT FIRST	J/P - UNKN JCT CLEARED	
V001	А	405 (FAILED TO	LOOK PROPERLY)			C001	А	802 (FAILED TO I	_OOK PROPERLY)	
6 01170043565	SUN 18/06/2017	18:20	LIGHT	JAMESTOWN RD	J/W CAMDEN HIGH	ST		02 NODE 667		528780/184050
POLICE - AT SCE	ENE	ROAD-DRY	WEATHER- FINE	SINGLE CWY	CROSSROADS	AUTO SIG		PEDN PHASE ATS	6	NONE IN 50M
			1.114							
CASUALTY	001 (001)	(29 YRS - F - RE		SLIGHT	PEDESTRIAN		N BOUND	UNKNOWN/OTHE	R	
CASUALTY VEHICLE	001 (001) 001 (000)	(29 YRS - F - RE WC 51-125CC BT - NOT REQ		SLIGHT (29 YRS - M - REDACT)	PEDESTRIAN	G/AHEAD - OTHEF		UNKNOWN/OTHE (E TO W) FRONT HIT FIRST	R JOURNEY P/O WO JCT MID	DRK

7 01170048890	TUE 04/07/2017	22.45	DARK		ST 21M S OF J/W JAM		02 LINK 129-667		528819/184019
SELF-REPORTED		UNKNOWN S/R	WEATHER- UNKNOWN	ONE-WAY ST	NO JUN IN 20M	N/A	NO XING FACIL II	N 50M	NONE IN 50M
CASUALTY	001 (001)	(30 YRS - M - RE	EDA)	SLIGHT	DRIVER/RIDER				
VEHICLE	001 (000)	PED CYCLE BT - DRV NOT C	ONTACTED	(30 YRS - M - REDACT)		UNKNOWN S/R	(MOVE UNKN) UNKNOWN S/R	JOURNEY P/O WO	DRK
VEHICLE	002 (000)	LONDON BUS BT - DRV NOT C	ONTACTED	(? YRS - M - REDACT)	UNKNOWN S/R	UNKNOWN S/R	(MOVE UNKN) UNKNOWN S/R	J/P - UNKN	
8 01170064811	MON 16/10/2017	22:30	DARK	JAMESTOWN RE	25M W OF J/W CAM	DEN HIGH ST	02 LINK 610-667		528767/184043
POLICE - AT SCE	NE	ROAD-DRY	WEATHER- FINE	SINGLE CWY	NO JUN IN 20M	N/A	PEDN PHASE ATS	3	CTRL - AUTH PERSON
CASUALTY	001 (002)	(27 YRS - M - RE	EDA)	SLIGHT	DRIVER/RIDER				
VEHICLE	001 (000)	CAR BT - NOT REQ		(32 YRS - M - REDACT)		SLOWING/STOPPING	(P TO P) N/S HIT FIRST	J/P - UNKN	
VEHICLE	002 (000)	PED CYCLE BT - N/A		(27 YRS - M - REDACT)		G/AHEAD - OTHER	(E TO W) FRONT HIT FIRST	J/P - UNKN	
V002	А	405 (FAILED TO	LOOK PROPERLY)						

9 01180134695	MON 24/09/2018	18:40	LIGHT	NFL CAMDEN HI	GH ST 30M N OF J/\	W BUCK ST		02 LINK 129-667	7	528810/184010
POLICE - AT SCE	NE	ROAD-DRY	WEATHER- FINE	ONE-WAY ST	NO JUN IN 20M	N/A		PEDN PHASE AT	S	NONE IN 50M
NOT KNOWN HOV	V COLLISION OCCU	JRRED								
CASUALTY	001 (001)	(87 YRS - M - RE	DA)	SLIGHT	PEDESTRIAN		N BOUND	FROM DRIVERS	N/SIDE	
VEHICLE	001 (000)	WC 126-500CC BT - NOT REQ		(32 YRS - M - REDACT)		MOVING OFF		(SE TO N) FRONT HIT FIRST	JOURNEY P/O WC	RK
C001	В	808 (CARELESS	RECKLESS OR IN	A HURRY)						