

	Notes
nning ck grout underpinning to be to the following ation:	1. This drawing is to be read in conjunction with all relevant Architects & Engineers drawings and specifications
be 3:1 of sharp sand o.p.c. to be sharpest that can be handled content to be just enough to allow balling when sed by hand	 Do not scale from this drawing General Propping Notes The contractor will be responsible for all temporary works and will be responsible for the stability of
ation for new foundations to be carried out in n 1.0m lengths with a minimum clear space of tween open excavations at any one time dig" for access purpose is only permitted in the away from the existing building. additional on of any kind which may undermine the foundations is strictly forbidden during uning operations side of existing foundations to be underpinned thoroughly cleaned to expose sound /brickwork oundations to be concreted/bricked up to within 'underside of the existing foundation (50mm minimum clear) a minimum curing period of 24 hours, the 75mm be pinned by hand or machine rammed of dry ut quent excavations cannot commence for a n of 48 hours after pinning actors method statement and programme is to d and approved prior to works commencing on pins to be connected with 4No. H16 bars	 works and win be responsible for the stability of entire structure during the works Our plans and section show a possible solution for the temporary works All party wall notices are to be agreed Install needles and props above the locations of the proposed beams Ensure all props are laterally restrained and install all necessary bracing Install any channel required across the head of the needles If required ensure all temporary works are dry packed into place Ensure no heavy materials are stored on the floors that are being propped Break out the load bearing walls in question Install new substructures Install new steel frames and ensure that the are fully dry-packed into place in order to take the permanent loads Once dry pack is set and approved by the building control officer strike the temporary props Make good all areas of brickwork where needles where inserted
New 250mm Reinforced Concrete wall New 250mm reinforced concrete wall	P2 14.01.22 JNS SB Preliminary Issue
Image: New 250mm reinforced concrete wall T.O.C. +12.2m Image: New 330mm reinforced concrete wall	P1 31.08.21 JNS SB Preliminary Issue Rev Date Drwn Chkd Amendments Drawing Status PRELIMINARY Image: Status PRELIMINARY Image: Status SSMMEETRYS STRUCTURAL / CIVIL ENGINEERS STRUCTURAL / CIVIL ENGINEERS Image: Status Status Image: Status <td< td=""></td<>
	21141 - SYM - XX - XX - DR - S - 0080 Scale: 1:50 AT A1 Drawn By: JNS Date: AUG 2021 Checked By: SB Company No. 5872122 VAT Pagistration No. 80

Company No. 5873122 VAT Registration No. 894 2993 61 Registered In England And Wales Refer to Architects drawings for all setting out details

The contractor shall be responsible for the design, installation and sequencing of all temporary works and must ensure that stability of the structure is not compromised during the works

Legend

	Denotes existing masonry or timber structure
	Denotes new masonry walls built in 15N/mm² compressive strength brickwork and grade iii mortar
	Denotes new masonry walls built in 7.3N/mm² compressive strength blockwork and grade iii mortar
	Denotes new non load bearing stud wall by Architect, unless noted otherwise
<i></i>	Denotes new floor joists 200x50mm C24 timber at 300mm centres
	Denotes 660 long x 330 wide x 215mm high mass concrete C30 padstone unless noted otherwise
2 and a contraction of the contr	Denotes 330 long x 215 wide x 215mm high mass concrete C30 padstone unless noted otherwise
:	Denotes joists doubled up and bolted together using M12 bolts at 400mm

Contractor/Specialist design element

1. All temporary works

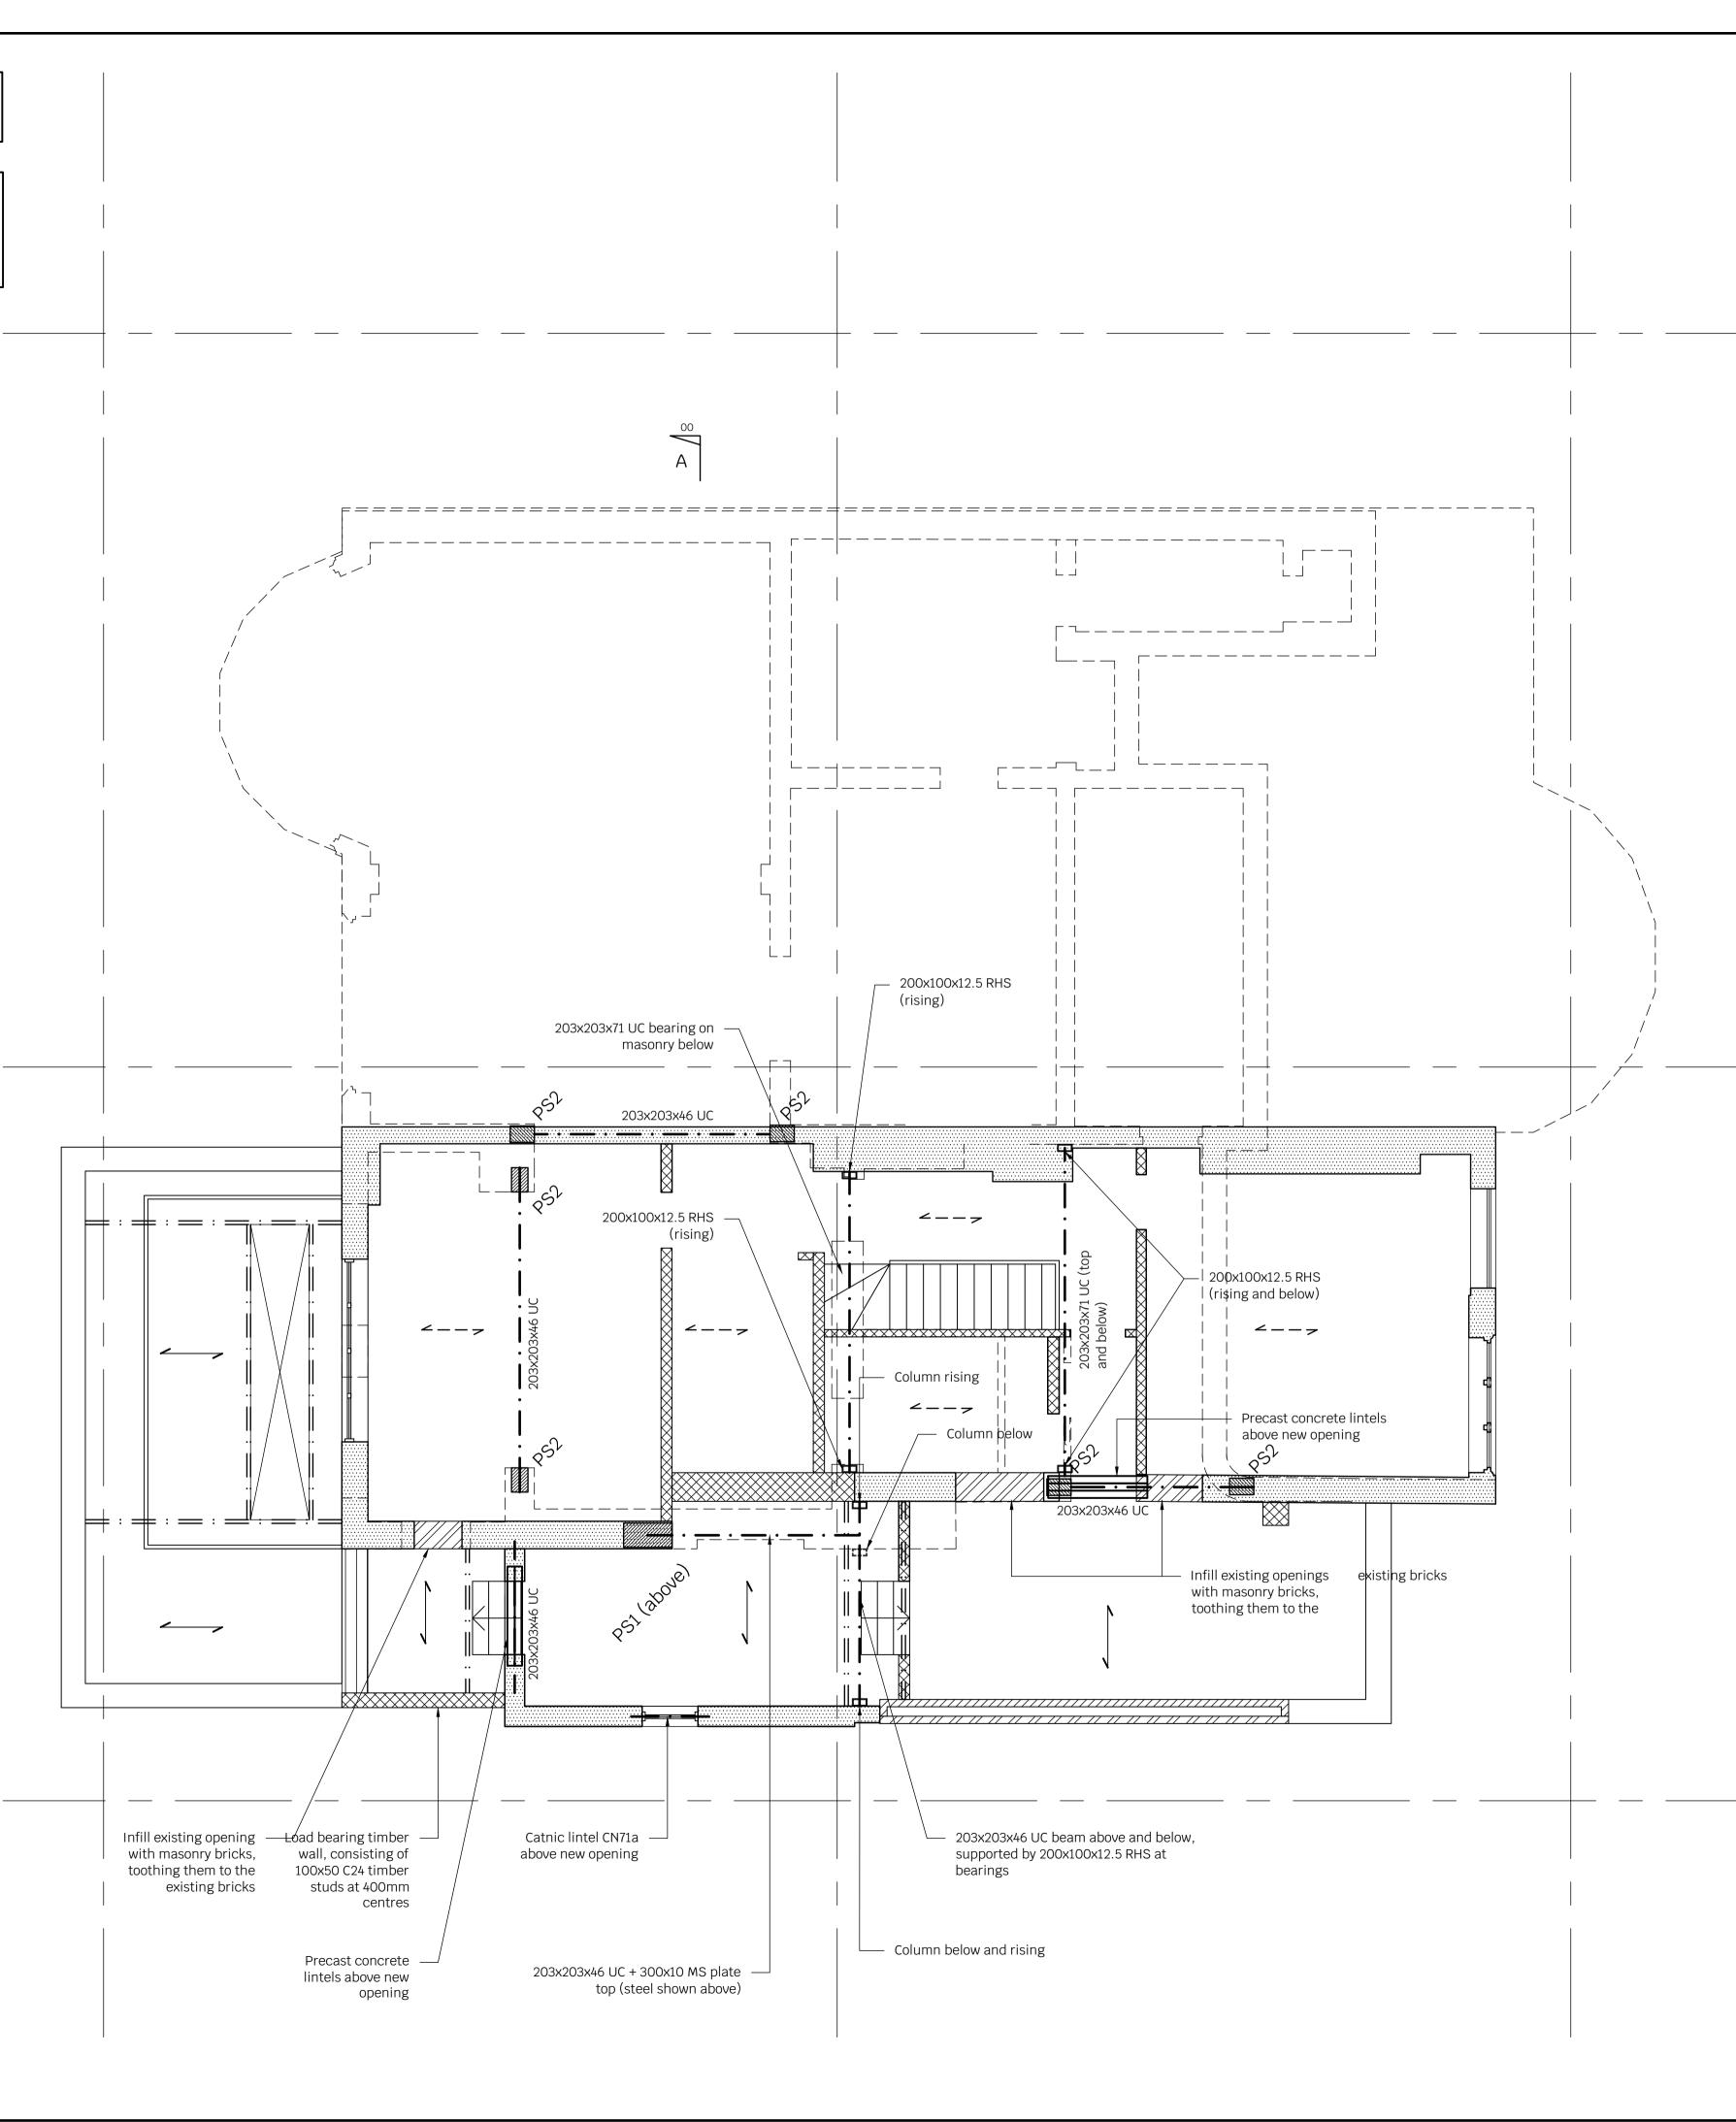
centres

∠ — — → Denotes existing timber floor joists

- 2. All tanking details
- 3. All reinforcement drawings and bar bending schedules
- 4. Design of all steelwork connections. The fabricator will have to submit their calculations to building control for approval
- 5. Steel fabrication drawings
- 6. Design of all staircases, balustrades, glazing and secondary steel

Notes

- All steelwork in the external walls is to be galvanised (125 microns)
- All steelwork to be encased in concrete is to be un-painted
- Location of existing and proposed drain runs are to be confirmed by the Service Engineer
- Please refer to Architects drawings for all setting out details, insulation and ventilation details, damp proof courses and all tanking details
- For all fire work protection to steelwork refer to the Architects drawings
- Contractor should also review Architect's drawings for exact location of service penetration and confirm these with the Structural Engineer prior to cutting



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Rev Date Drwn Chkd Amendments Drawing Status PRELIMINARY
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STRUCTURAL / CIVIL ENGINEERS
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T 020 8340 4041 / E INFD@SYMMETRYS.COM / SYMMETRYS.COM / LONDON N8 85L Job Title 43A REDINGTON ROAD
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T 020 8340 4041 / E INFO@SYMMETRYS.COM / SYMMETRYS.COM / LONDON N8 8SL Job Title 43A REDINGTON ROAD LONDON, NW3 Drawing Title GROUND FLOOR PLAN
T020 8340 4041 / E INFO@SYMMETRYS.COM / SYMMETRYS.COM / LONDON N8 8SL Job Title 43A REDINGTON ROAD LONDON, NW3 Drawing Title GROUND FLOOR PLAN Project Company Zones Level Type Role Numbe

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Legend

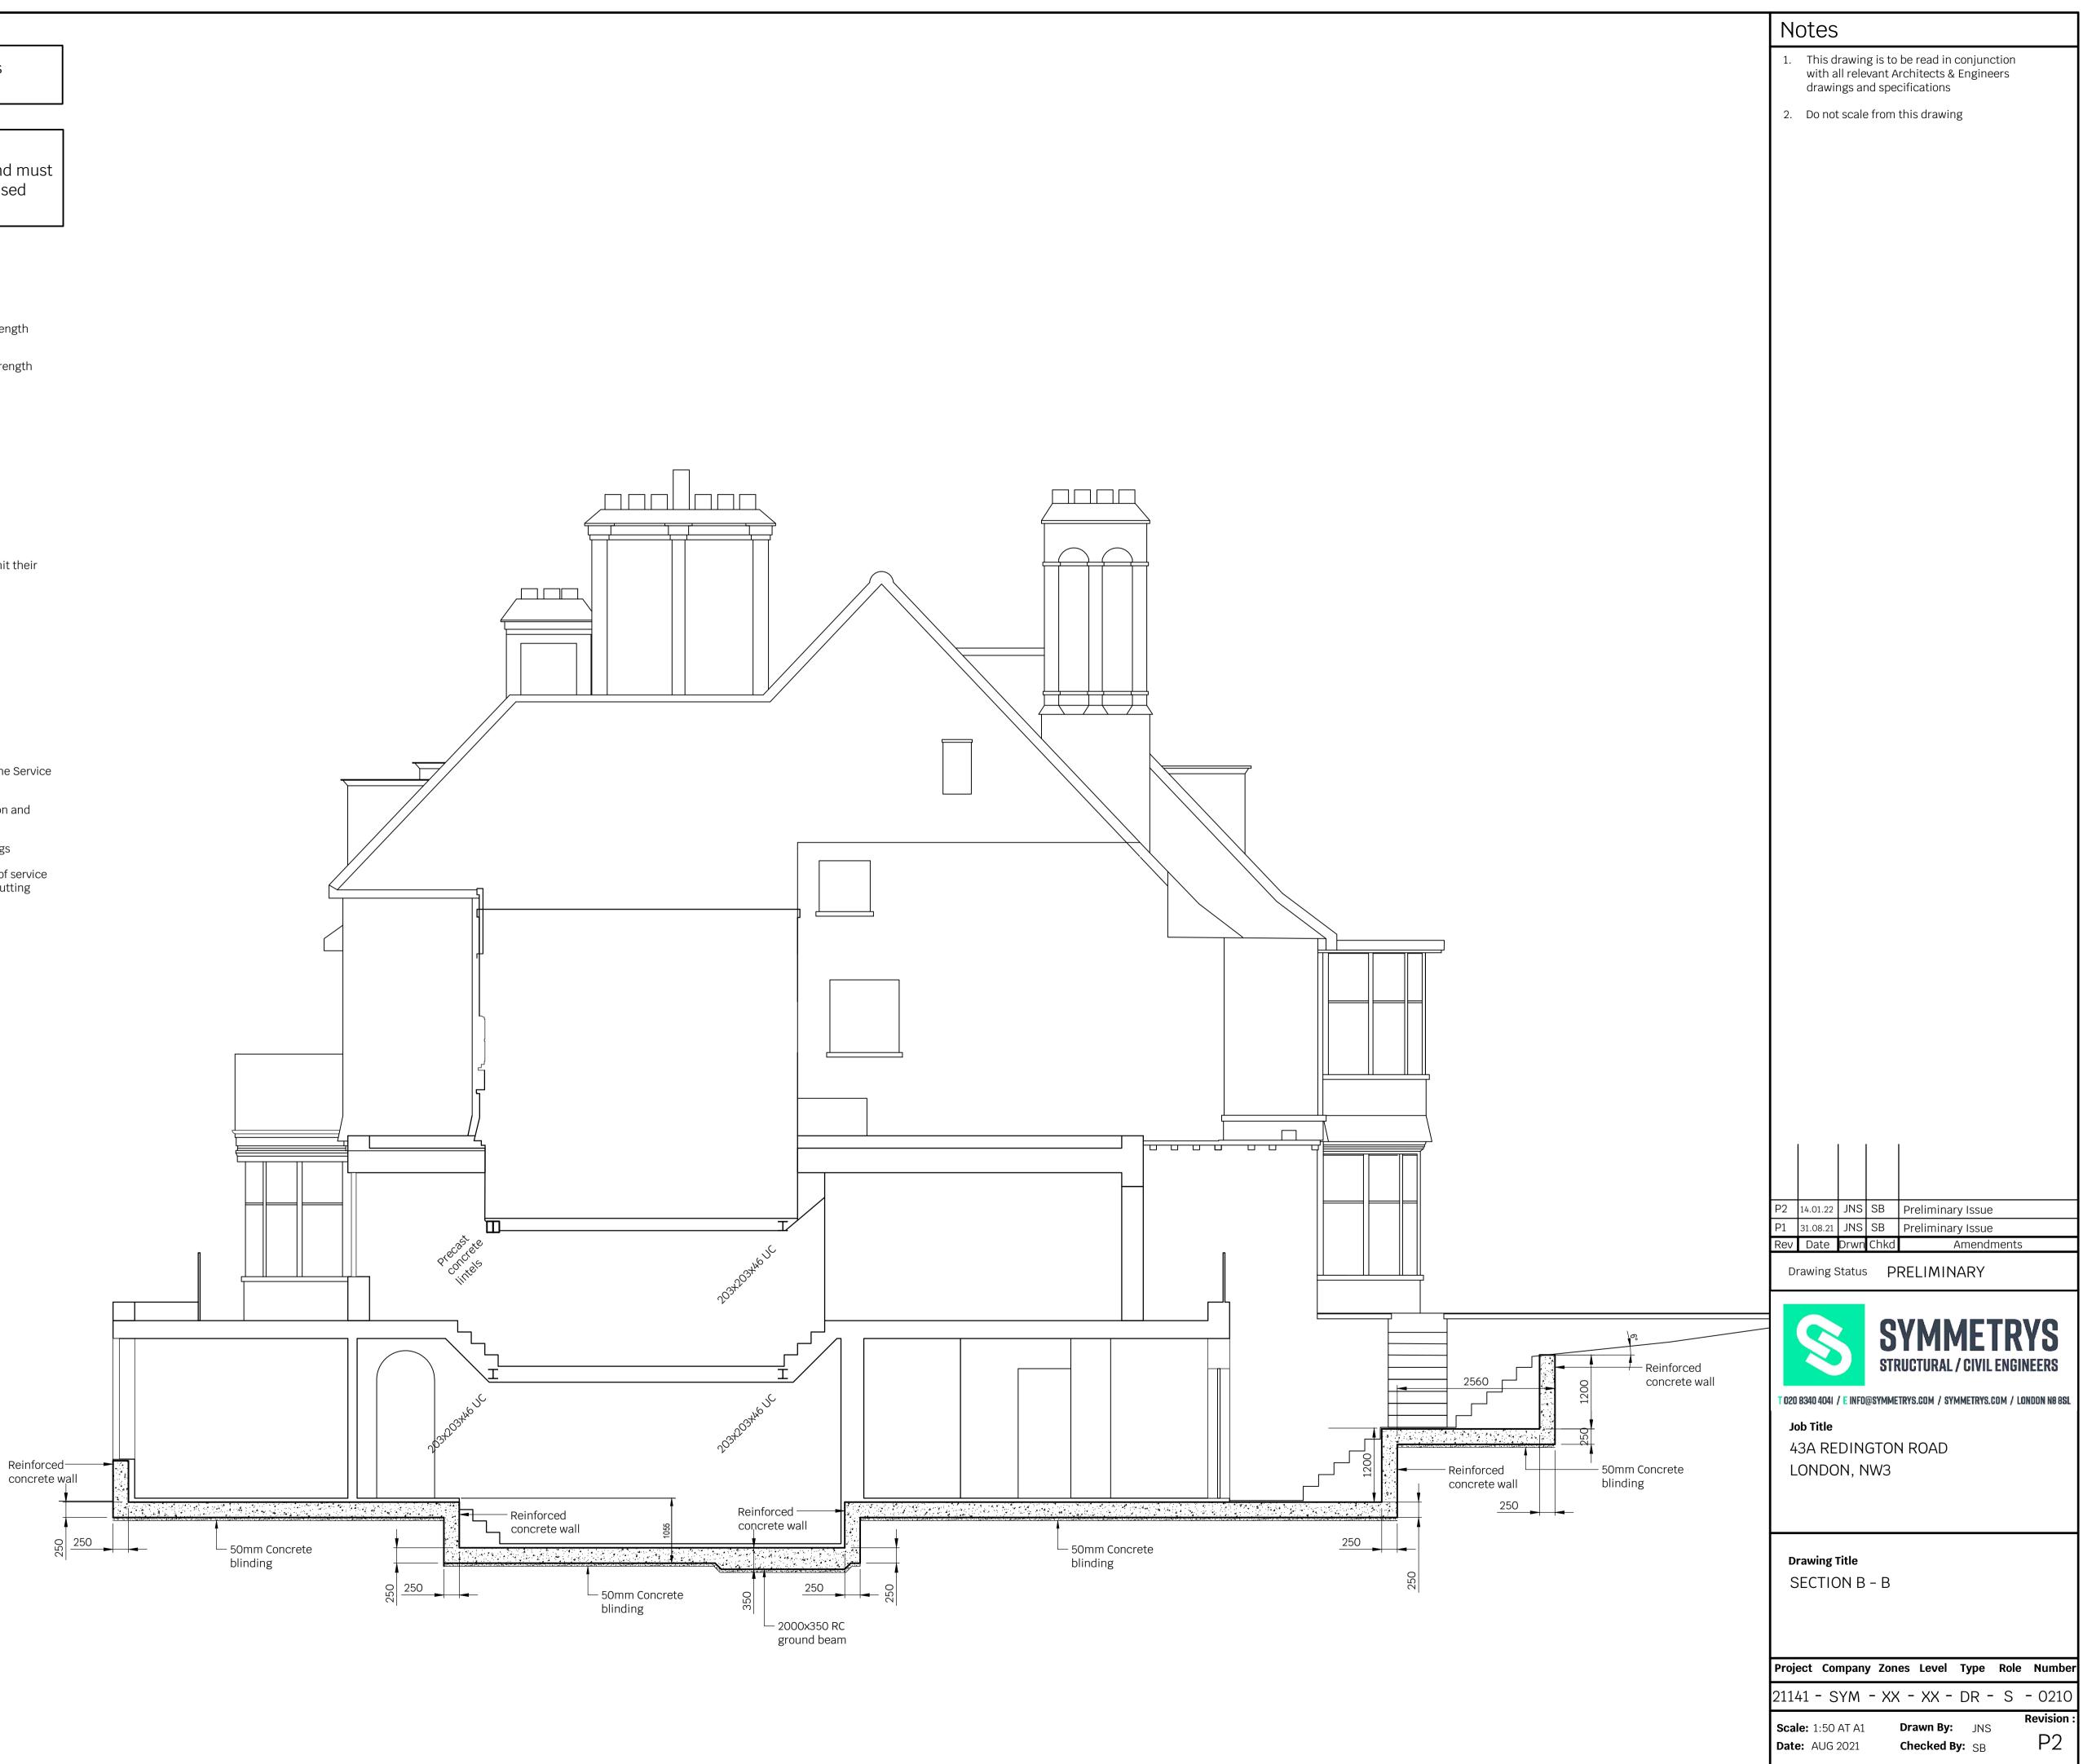
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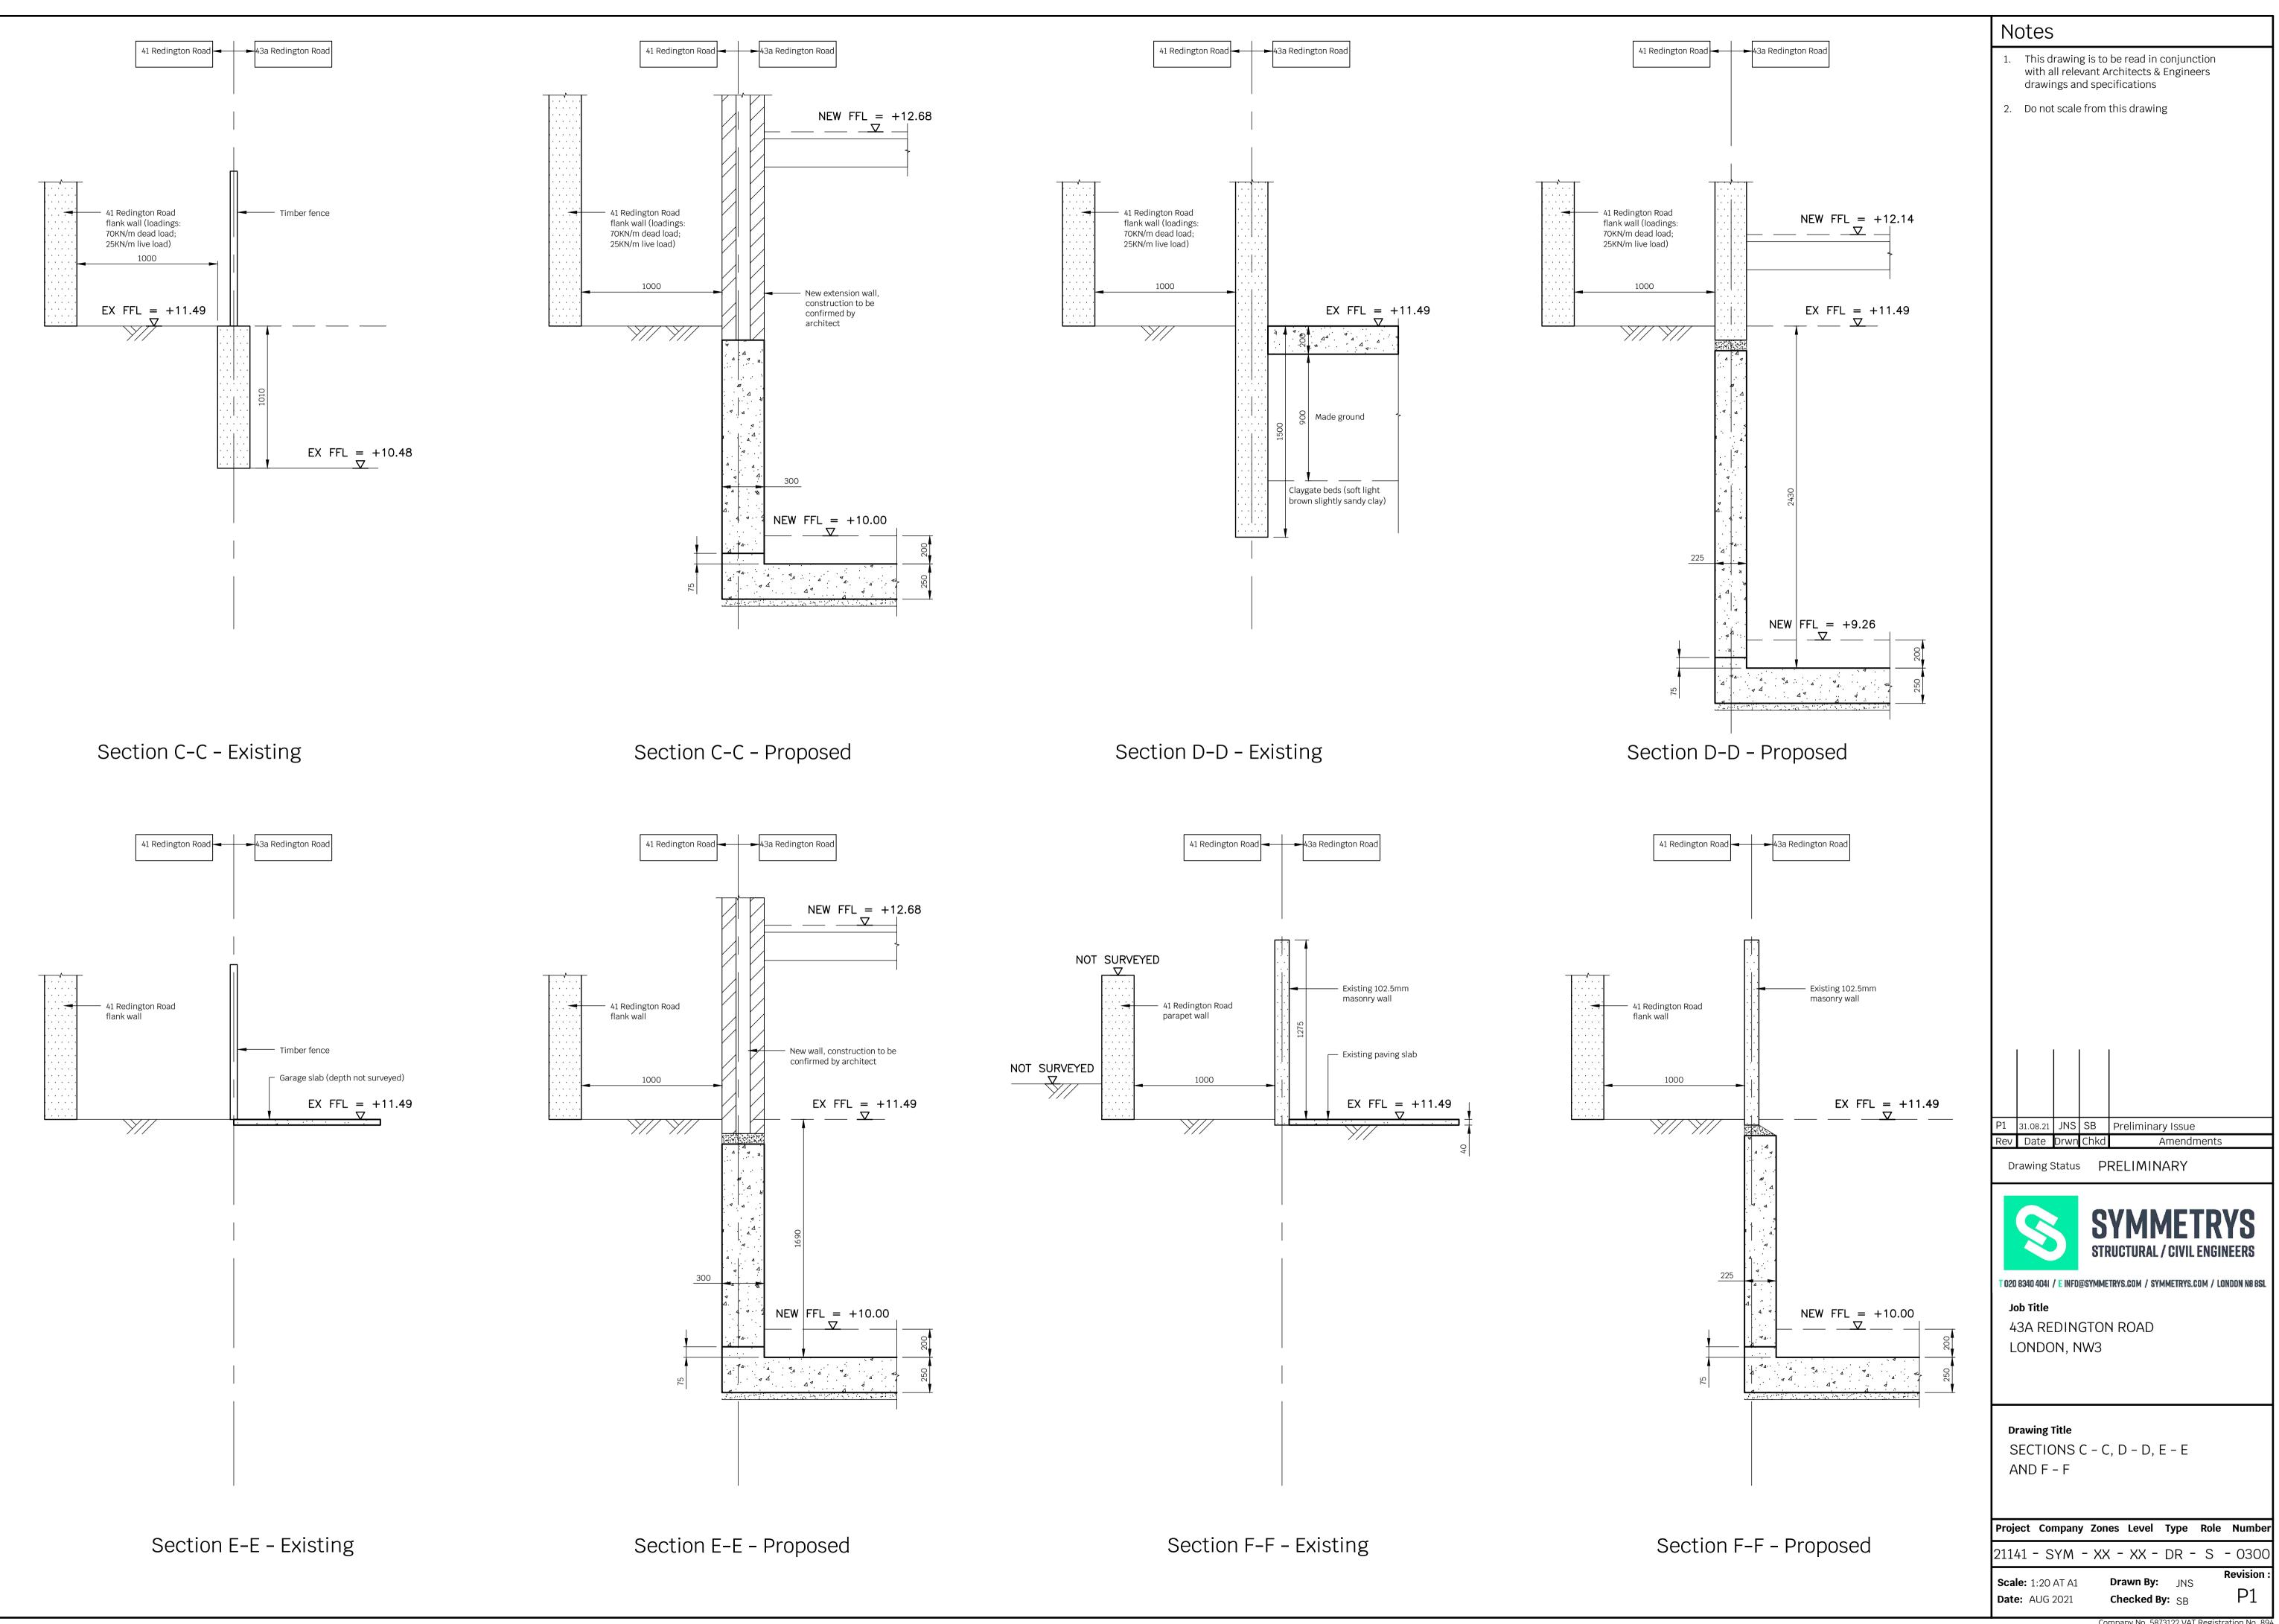
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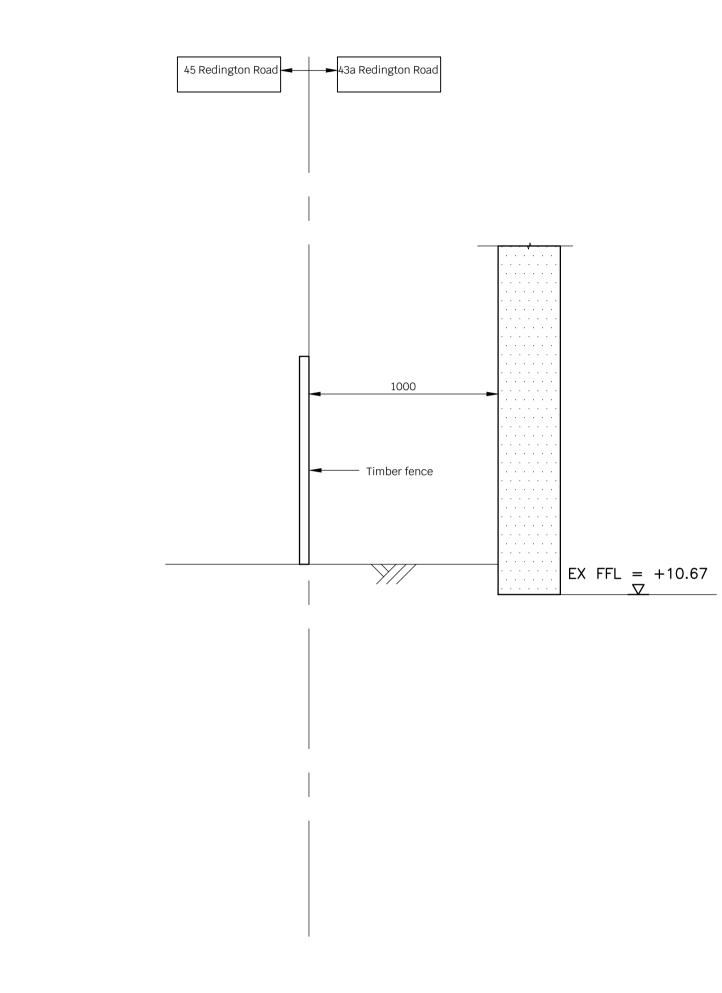
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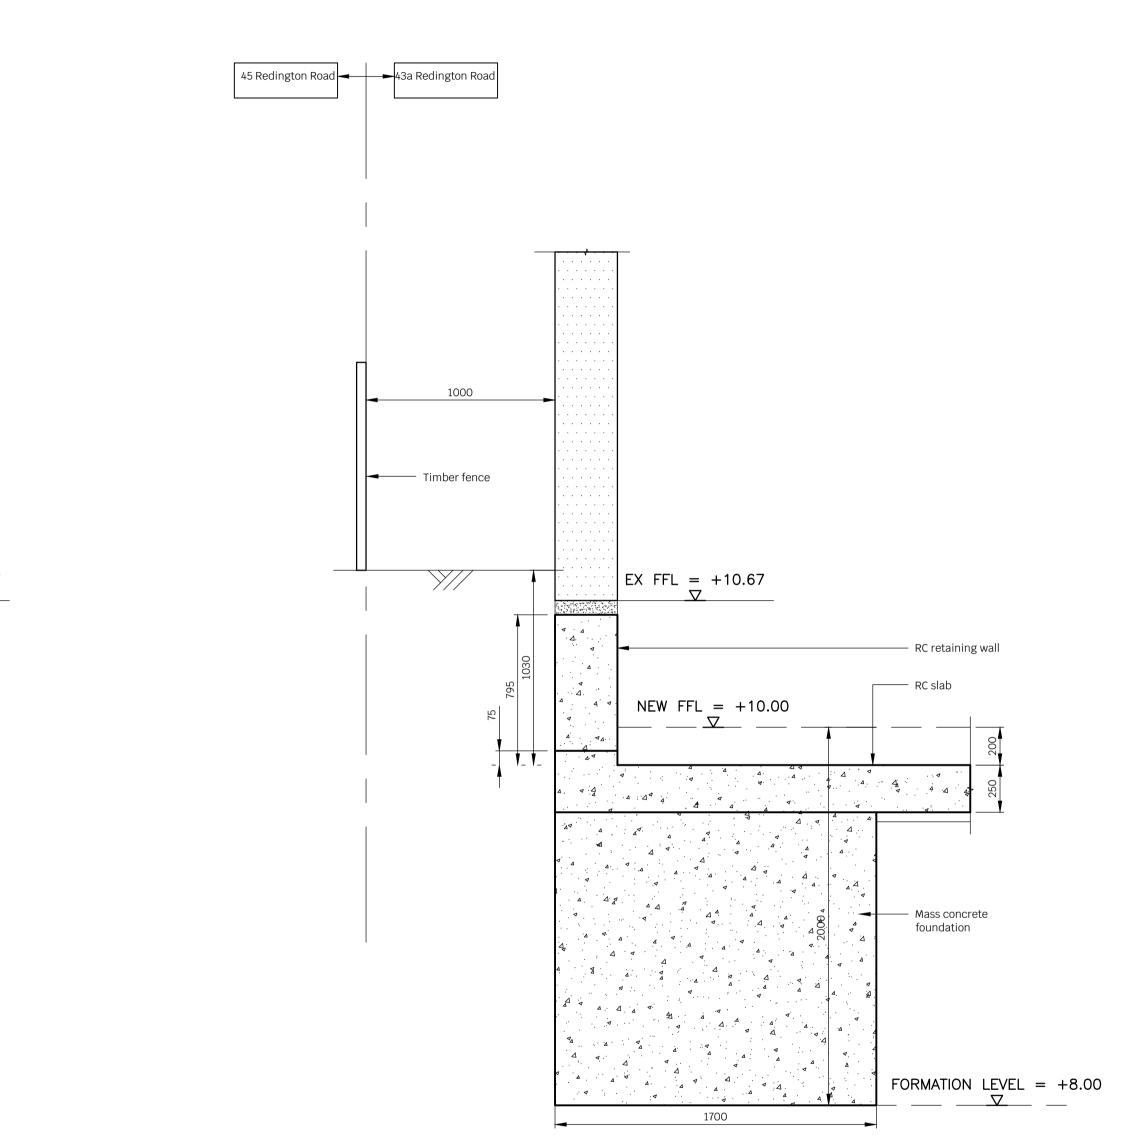
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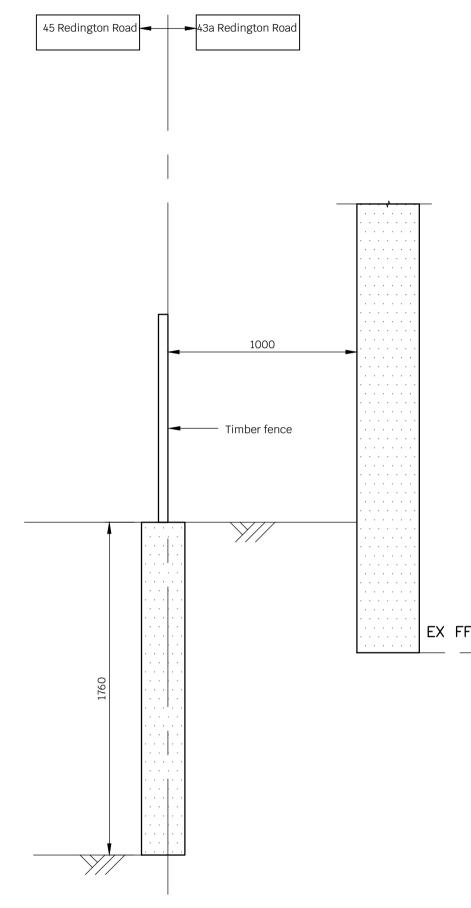
Section G-G - Existing



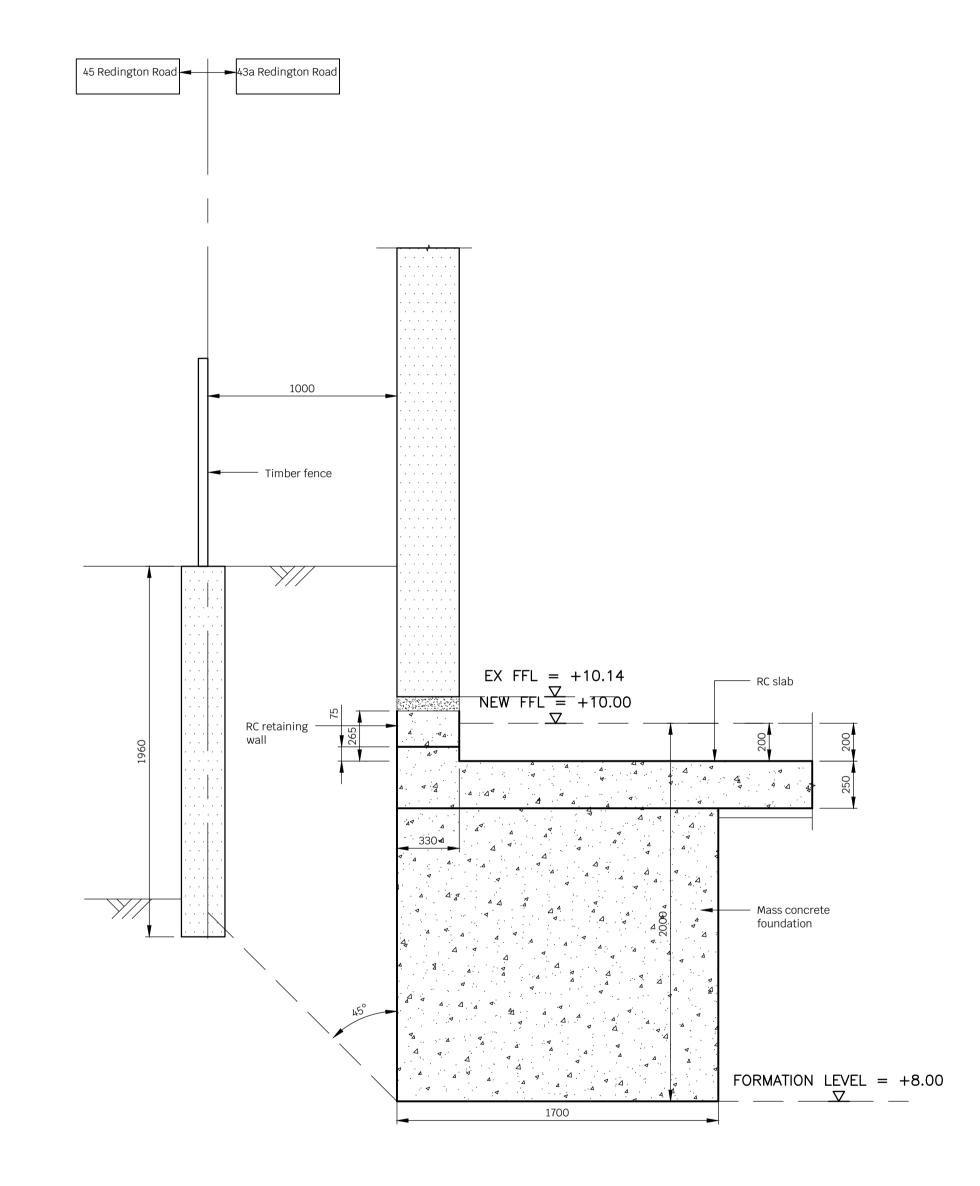
Section G-G - Proposed

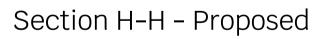
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Job Title
43A REDINGTON ROAD LONDON, NW3
Drawing Title
SECTION G - G
Project Company Zones Level Type Role Number
21141 - SYM - XX - XX - DR - S - 0310 Revision :
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Section H-H - Existing

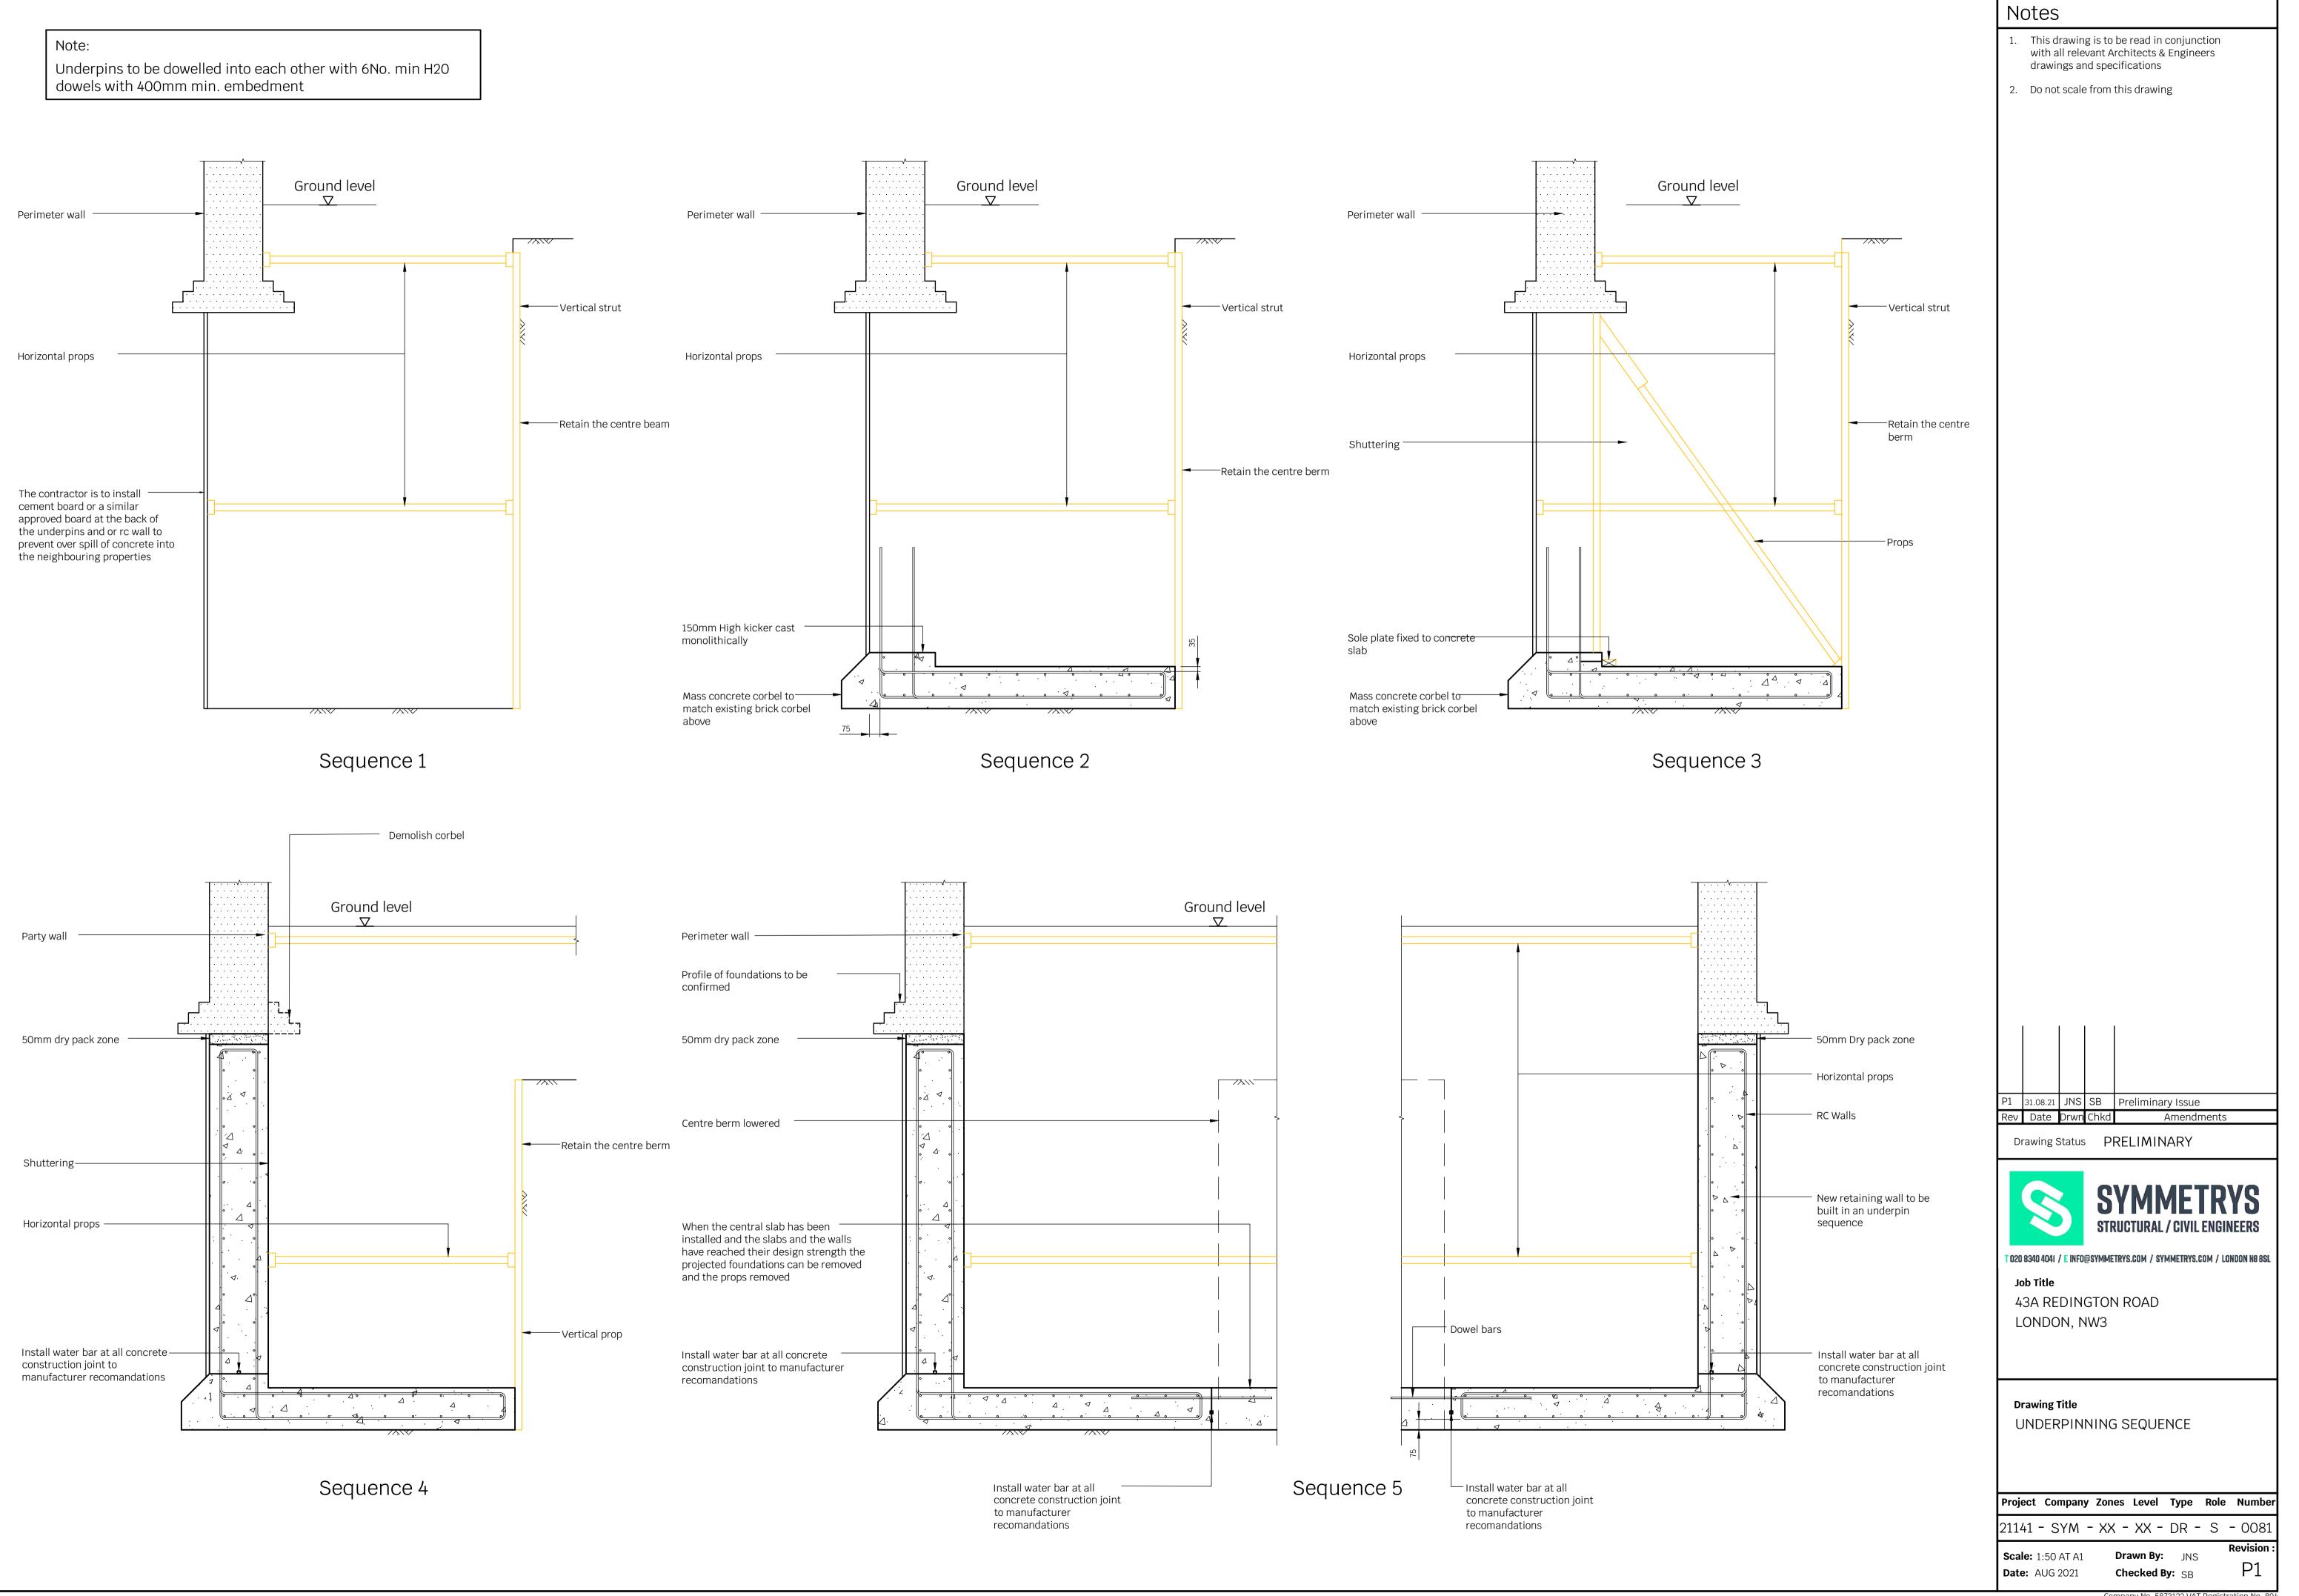




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