

The purpose of this arboricultural method statement plan is to detail The purpose of this arboricultural method statement plan is to detail what actions need to be taken to prevent the proposed construction of a rear extension at 26 Brookfield Park, causing any unacceptable damage to the trees to be retained within this site and in the adjacent properties.

This method statement has been drawn up to comply with the recommendations of British Standard BS 5837: 2012, Trees in relation to design, demolition and construction - Recommendations.

Planning & communication

Jnless otherwise agreed with the Local Planning Authority (LPA),

Unless otherwise agreed with the Local Planning Authority (LPA), the following actions are to be taken, in the order specified in the sequence of Works Table (see below).

The developer will appoint an arboricultural consultant to oversee all aspects of tree care and protection for the duration of demolition and construction works.

Prior to the commencement of works, the project manager will seed points of any demolition as the project manager will

send copies of any demolition or construction method statement that might have implications for existing trees to the arboricultura nsultant for his comments. The arboricultural consultant will consularity in softments. The about controlled with the project manager to ensure that there are no conflict between the demolition or construction method statements and this arboricultural method statement.


Prior to the start of any site clearance, demolition or construction works the developer will convene a pre-commencement site meeting. This shall be attended by the project manager, the building contractor and the arboricultural consultant. The LPA tree building contractor and the arboricultural consultant. The LPA tree officer will be invited to attend. At that meeting contact numbers will be exchanged, and the methods of tree protection outlined in this statement shall be fully discussed, so that all aspects of their implementation and sequencing are made clear to all parties. Any clarifications or modifications to this statement arising from the neeting shall be circulated to all parties in writing.

Sequence of works

Order	Works	Arb. supervisio required:		
1	Pre-commencement site meeting.	Yes		
2	Removal of tree no. 1	No		
3	Pruning of tree no. 5	No		
4	Erection of protective fencing.			
7	Clearance of machinery/materials from site.	No		
	Removal of protective fencing and ground			

Arboricultural Supervision and Monitoring

Once the protective fencing measures have been installed, the arboricultural consultant will visit site and inspect them. In the event that the specification or location does not comply with this method statement, the arboricultural consultant will inform the project manager and adjustments will be made. Once compliance is achieved, the arboricultural consultant will sign off the tree protection measures to the contractor, and copy this (in writing) to the client and to the LPA. Throughout the construction process the arboricultural consultant will imposite the condition of the trees, and the integrity and effectiveness of onitor the condition of the trees, and the integrity and effectiveness the protective fencing. He will visit the site at appropriate intervals, as agreed with the LPA Tree Officer at the pre-commencement meeting, to ensure that the protection measures outlined in this document are adhered to. Records of all monitoring and supervisory visits will be nade, and will be forwarded to the client and copied to the LPA. All drawings or revised drawings issued to the site agent or to sub-contractors, that show details of any works within or immediately abutting RPAs or beneath the crowns of trees are to be referred in advance to the arboricultural consultant to enable him to advise on an changes to the impact on the trees that these drawings may cause, a to be able to provide solutions to avoid or mitigate any further tree amage. All such drawings will be approved and signed off by the boricultural consultant before being proceeded with.

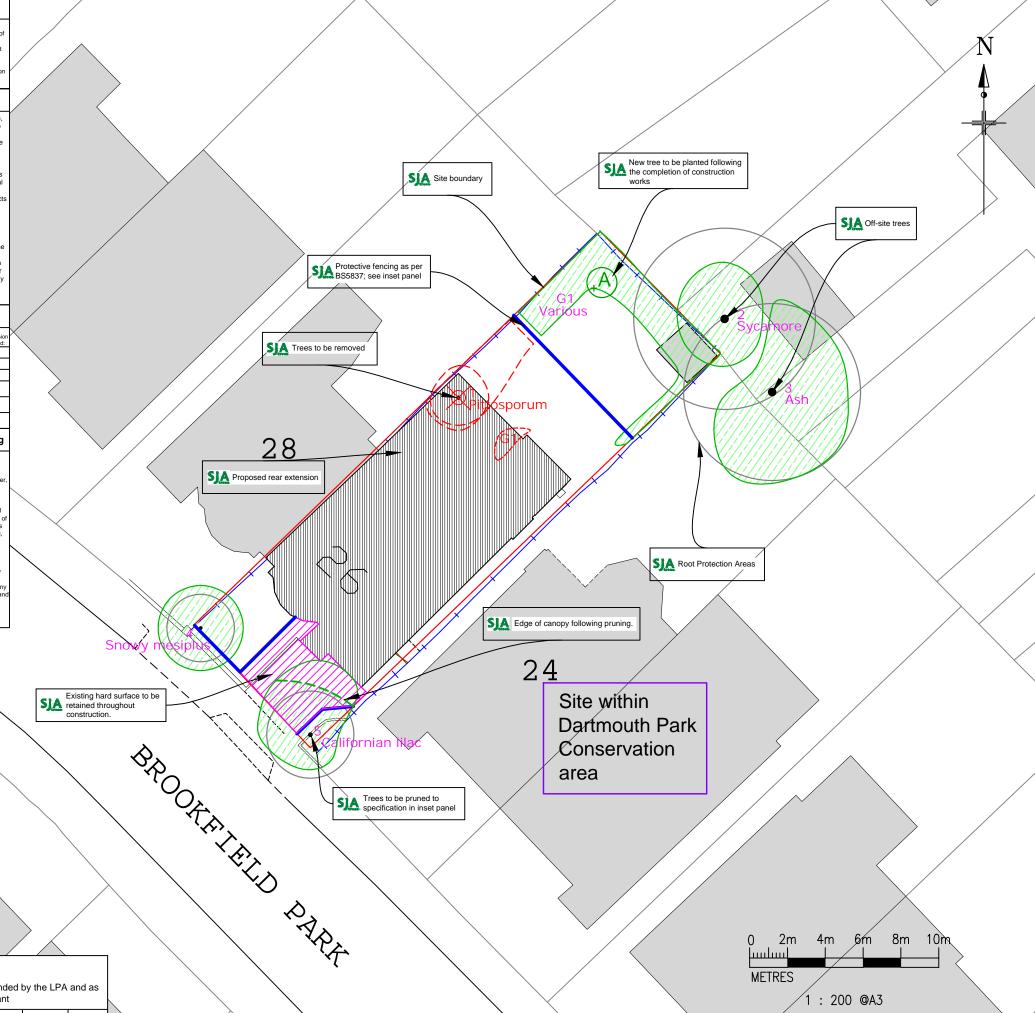


Arboricultural Impacts: Summary Trees to be removed Groups to be removed Groups to be partially removed Trees where manual excavation needed within RPAs Trees where above soil surfacing needed within RPAs (\mathbf{x}) Trees to be Removed

Trees that will require pruning

5 Californian lilac Remove cracked north-eastern lim	
to main stem	

Protective Fencing

To be erected prior to the commencement of all works on site, and retained in place throughout construction. To comprise 2m tall 'Heras welded mesh panels on rubber or concrete feet. The panels shall be welded mesh panels on rubber or concrete feet. The panels shall be joined together with two anti-tamper couplers, installed so that they ca only be removed from inside the fence. Distance between the couplers should be at least 1m and should be uniform throughout the fence. Panels should be supported (where possible) on the inner side by stabilizer struts, which should normally be attached to a base plate secured with ground prins (Figure 3a). Where the fencing is to be rected on retained hard surfacing or it is otherwise unfeasible to use ground pins, e.g. due to the presence of underground services, the stabilizer struts shall be mounted on a block tray (Figure 3b). "TREE PROTECTION ZONE - KEEP OUT" or similar notices to be attached to every lifth panel.

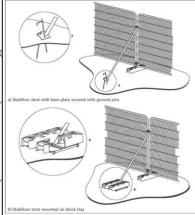

TREE PROTECTIVE FENCING as shown in BS 5837: 2012, Section

Retention of existing hard surfacing

Within root protection area ('RPA') of tree no. 5, the surface of the existing driveway will be retained undisturbed during the construction period to act as temporary ground protection. Where necessary, ply boards or other suitable material should be used to limit any damage

Rev. a 31/01/2022 Addition of replacement tree specification

Project:

Client:	Mr and Mrs Aldridge
Drawing:	METHOD STATEMENT PLAN
Drawing no:	SJA MSP 21498-012a
Based on:	Proposed Site Plan 090

26 Brookfield Park

Drawn by: WFH		Date of Issue: Feb 2022		Scale: 1: 200 @ A3	
Checked by: FPS		Tel:(01737) 813058		sja@sjatrees.co.uk	
Tree nos.:	• 5	Canopies of trees to be retained:		Indicative pruning line:	(_)
Trees to be removed:	(E)	Protective fencing:		Category 'C' RPA:	\bigcirc

Planting schedule

Tree location and specification as recommended by the LPA and as $% \left(1\right) =\left(1\right) \left(1\right)$ agreed with the applicant

Name	Designation	Girth / Height	Root system	Planting location	Quantity
Apple Malus domestica	Selected standard	8 - 10 cm / 250cm - 300cm	Container-grown	А	1

flant material shall comply with British Standard BS3936: Part 1: 1992, "Nursery Stock, Part 1. Specification for trees and shrubs' flanting shall be undertaken in accordance with British Standard BS4043: 1989, "Transplanting root-balled trees".