


Please refer to RICS Code of Measuring for the precise definitions that permit the accurate measurement of buildings / land.

https://www.rics.org/uk/upholdingprofessional-standards/sector-standards/ real-estate/code-of-measuring-practice/

GENERAL NOTES

Accuracy Of Information

If any discrepancies exist between this drawing and site conditions or information provided by other consultants, contractors, sub-contractors, or if otherwise unclear, notify the architect immediately.

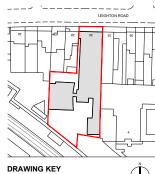

SITE: 1197 m² GIA: 699 m² GARDEN: 348 m²

NEW PARTITION OR INFILL

EXISTING WALL CEILING LEVEL

N/A FLOOR LEVEL

1:200 SCALE BAR

Metres 2

ISSUE

PLANNING

DATE 05.08.2021

REVISION

DRAWING TITLE

EXISTING GA GROUND FLOOR


SCALE

2109_KW_P1_DR_11-01

30 Leighton Road Kentish Town, London, NW5 2QE



professional-standards/sector-standards/ real-estate/code-of-measuring-practice/ GENERAL NOTES **Accuracy Of Information** If any discrepancies exist between this drawing and site conditions or information provided by other consultants, contractors, sub-contractors, or if otherwise unclear, notify the architect immediately.

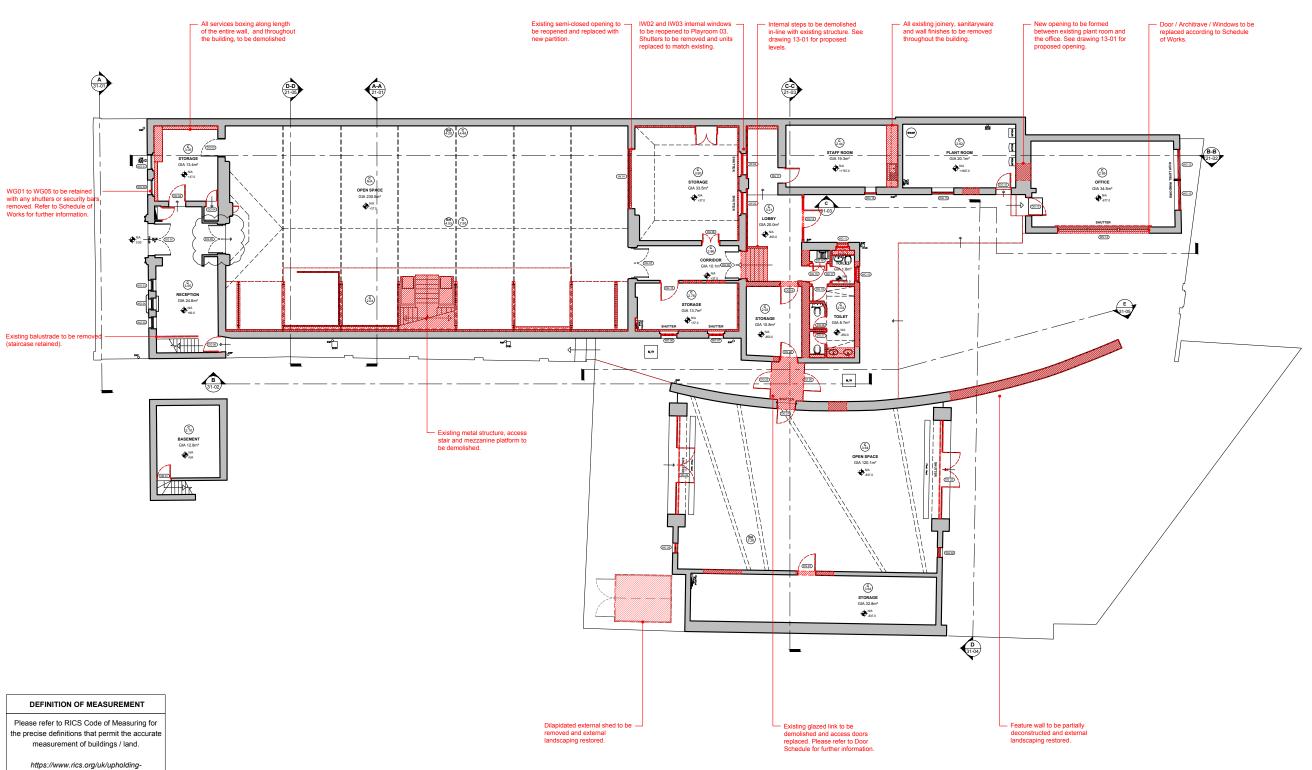



DRAWING KEY

Removal of Existing

Removal of Wall Finishes Removal of Floor / Ceiling

DATE: REV. DESCRIPTION:

21.12.21 01 Note to WG01-05 updated 07.02.22 02 DG05 retained, note updated

General Demolition Notes:

Structure

Take extreme care when removing existing structural elements. Refer to engineer's drawings for extent of demolition. The Contractor is responsible for the design of all temporary works / supports.

Health & Safety

The Contractor is responsible for ensuring adequate measures are taken to provide a safe working site at all times. Should harmful or toxic materials (eg. Asbestos) be discovered on site in areas not noted in the health & safety plan, Contractor to stop works in this area and immediately contact the project manager / architect to assess the proper and safe removal of the material.

Accuracy of Information

If any discrepancies exist between this drawing and site conditions or information provided by other consultants, contractors, sub-contractors, or if otherwise unclear, notify the architect immediately.

1:200 SCALE BAR

Metres 2

ISSUE

PLANNING

DATE 07.02.2022 REVISION 02

DRAWING TITLE

DEMOLITION GROUND FLOOR

2109_KW_P1_DR_12-01 SCALE 1:200 (A3)

30 Leighton Road

Kentish Town, London, NW5 2QE



BUILDING ENVELOPE

External Walls

Building considered a material change of


use under the current building regulations, thus will require existing elements to be

0.30/0.55*

upgraded to the minimum standards. Existing elements are required to achieve the following minimum U-Values (W/M².K):

Pitched Roof - Ceiling Level 0.16
Pitched Roof - Rafter Level 0.18 Pitched Roof - Rafter Level

*A U-Value of 0.55 W/M².K is used for cavity wall insulation and 0.30 W/M².K for internal or external wall insulation.

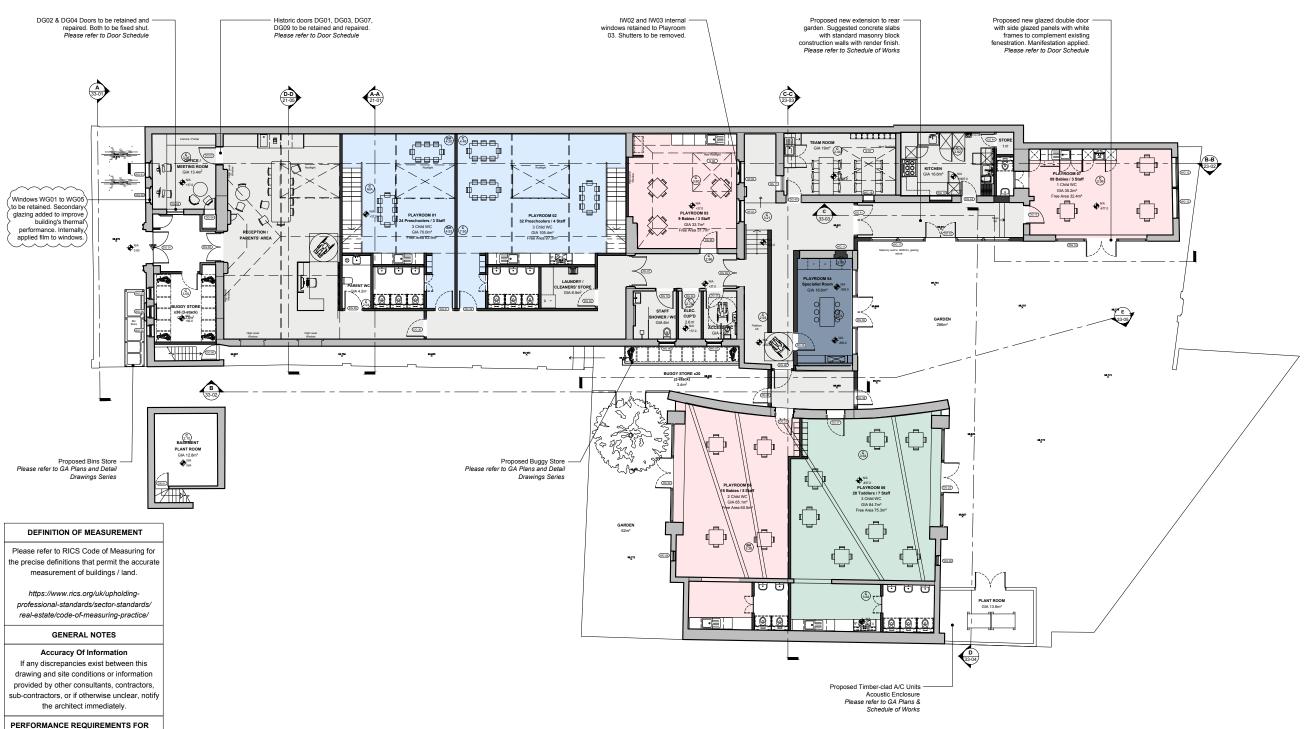



SITE:

1197 m² GIA: 743 m² GARDEN: 348 m²

> NEW PARTITION OR INFILL EXISTING WALL

(c 4.15)

FLOOR LEVEL N/A CEILING LEVEL

JG 01 JOINERY CODE

CUBBY HOLE JOINERY FULL HEIGHT STORAGE NAPPY CHANGE UNIT ws CHILD'S WATER STATION KITCHENETTE WW WASHING MACHINE TUMBLE DRYER

TD AIR CONDITIONING UNIT AC AIR PURIFICATION UNIT HEATER

RADIATOR CHILD HEIGHT HANDRAIL

BLIND

OCCUPANCY: 33 BABIES

28 TODDLERS 56 PRESCHOOLERS -- SPECIALIST

117 CHILDREN TOTAL: 30 STAFF

1:200 SCALE BAR Metres 2

ISSUE

PLANNING

DATE 21.12.2021 REVISION 01

DRAWING TITLE


PROPOSED GA **GROUND FLOOR**

2109_KW_P1_DR_13-01 SCALE 1:200 (A3)

PROJECT 30 Leighton Road

London, NW5 2QE



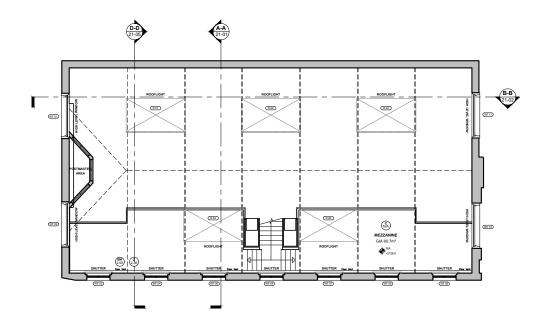


Please refer to RICS Code of Measuring for the precise definitions that permit the accurate measurement of buildings / land.

https://www.rics.org/uk/upholdingprofessional-standards/sector-standards/ real-estate/code-of-measuring-practice/

GENERAL NOTES

Accuracy Of Information

If any discrepancies exist between this drawing and site conditions or information provided by other consultants, contractors, sub-contractors, or if otherwise unclear, notify the architect immediately.

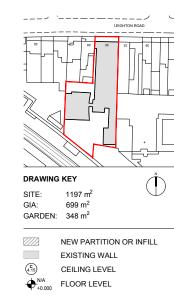

1:200 SCALE BAR

Metres 2 4 6

ISSUE

PLANNING

DATE REVISION

DRAWING TITLE

EXISTING GA MEZZANINE LEVEL

DWG REF SCALE 2109_KW_P1_DR_11-02 1:200 (A3)

05.08.2021

PROJECT 30 Leighton Road


Kentish Town, London, NW5 2QE

Kennedy Woods

Unit B3.2 Bussey Building 133 Copeland Road,SE15 3SI hello@kennedywoods.co.uk

This drawing is the copyright of Kennedy Woods Architecture Ltd an nay not be copied, altered or reproduced in any way or passed to it first party without written authority. Kennedy Woods assumes no first party without written authority. Kennedy Woods sessumes not not or contrador. The drawing is provided for information purpose not just contrador. The drawing is provided for information purpose information by contradors to be confirmed prior to fasticiation. If an siscrepancies exist between this drawing and site conditions or information by other consultants, contradors, sub-contradors, or otherwise unclear, notify the architect immediately. Drawing to be reated to the confirmation of the property of the confirmation of the confirmation.



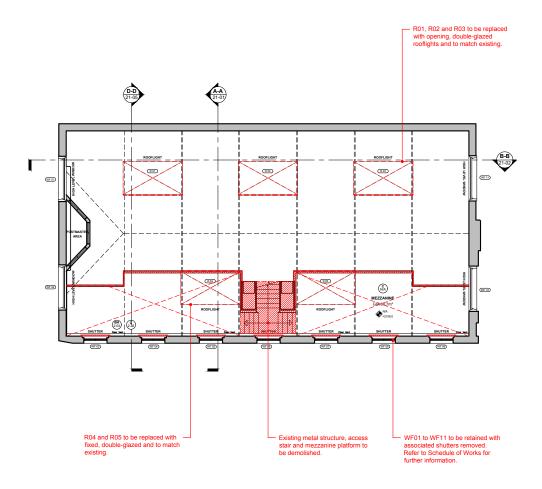

Please refer to RICS Code of Measuring for the precise definitions that permit the accurate measurement of buildings / land.

https://www.rics.org/uk/upholdingprofessional-standards/sector-standards/ real-estate/code-of-measuring-practice/

GENERAL NOTES

Accuracy Of Information

If any discrepancies exist between this drawing and site conditions or information provided by other consultants, contractors, sub-contractors, or if otherwise unclear, notify the architect immediately.



Removal of Wall Finishes

Removal of Floor / Ceiling

General Demolition Notes:

Structure

Take extreme care when removing existing structural elements. Refer to engineer's drawings for extent of demolition. The Contractor is responsible for the design of all temporary works / supports.

Health & Safety

The Contractor is responsible for ensuring adequate measures are taken to provide a safe working site at all times. Should harmful or toxic materials (eg. Asbestos) be discovered on site in areas not noted in the health & safety plan, Contractor to stop works in this area and immediately contact the project manager / architect to assess the proper and safe removal of the material.

Accuracy of Information

If any discrepancies exist between this drawing and site conditions or information provided by other consultants, contractors, sub-contractors, or if otherwise unclear, notify the architect immediately.

1:200 SCALE BAR

Metres 2

ISSUE

PLANNING

DATE

REVISION

DRAWING TITLE

DEMOLITION MEZZANINE LEVEL

SCALE

2109_KW_P1_DR_12-02


PROJECT

30 Leighton Road

05.08.2021

Kentish Town, London, NW5 2QE



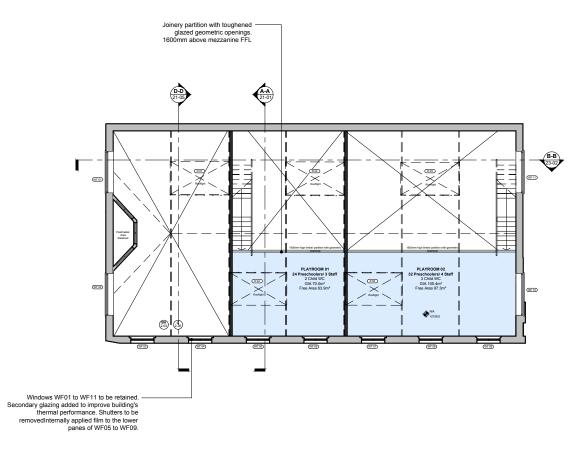

Please refer to RICS Code of Measuring for the precise definitions that permit the accurate measurement of buildings / land.

https://www.rics.org/uk/upholdingprofessional-standards/sector-standards/ real-estate/code-of-measuring-practice/

GENERAL NOTES

Accuracy Of Information

If any discrepancies exist between this drawing and site conditions or information provided by other consultants, contractors, sub-contractors, or if otherwise unclear, notify the architect immediately.


PERFORMANCE REQUIREMENTS FOR **BUILDING ENVELOPE**

Building considered a material change of use under the current building regulations, thus will require existing elements to be upgraded to the minimum standards.

Existing elements are required to achieve the following minimum U-Values (W/M².K):

External Walls 0.30/0.
Pitched Roof - Ceiling Level 0.16
Pitched Roof - Rafter Level 0.18 0.30/0.55*

*A U-Value of 0.55 W/M².K is used for cavity wall insulation and 0.30 W/M².K for internal or external wall insulation.

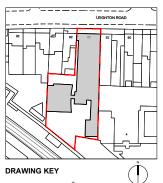

SITE: 1197 m² GIA: 743 m² GARDEN: 348 m²

NEW PARTITION OR INFILL

EXISTING WALL (c 4.15) FLOOR LEVEL

N/A CEILING LEVEL JG 01

JOINERY CODE

С CUBBY HOLE JOINERY FULL HEIGHT STORAGE NAPPY CHANGE UNIT CHILD'S WATER STATION KITCHENETTE

WM WASHING MACHINE TD TUMBLE DRYER AC AIR CONDITIONING UNIT AIR PURIFICATION UNIT

HEATER RADIATOR

CHILD HEIGHT HANDRAIL

BLIND

OCCUPANCY: 33 BABIES

28 TODDLERS 56 PRESCHOOLERS -- SPECIALIST

TOTAL: 117 CHILDREN

30 STAFF

1:200 SCALE BAR

Metres 2

ISSUE

PLANNING

DATE REVISION

DRAWING TITLE

PROPOSED GA **MEZZANINE FLOOR**

2109_KW_P1_DR_13-02


SCALE PROJECT 30 Leighton Road

London, NW5 2QE

Kennedy Woods

05.08.2021



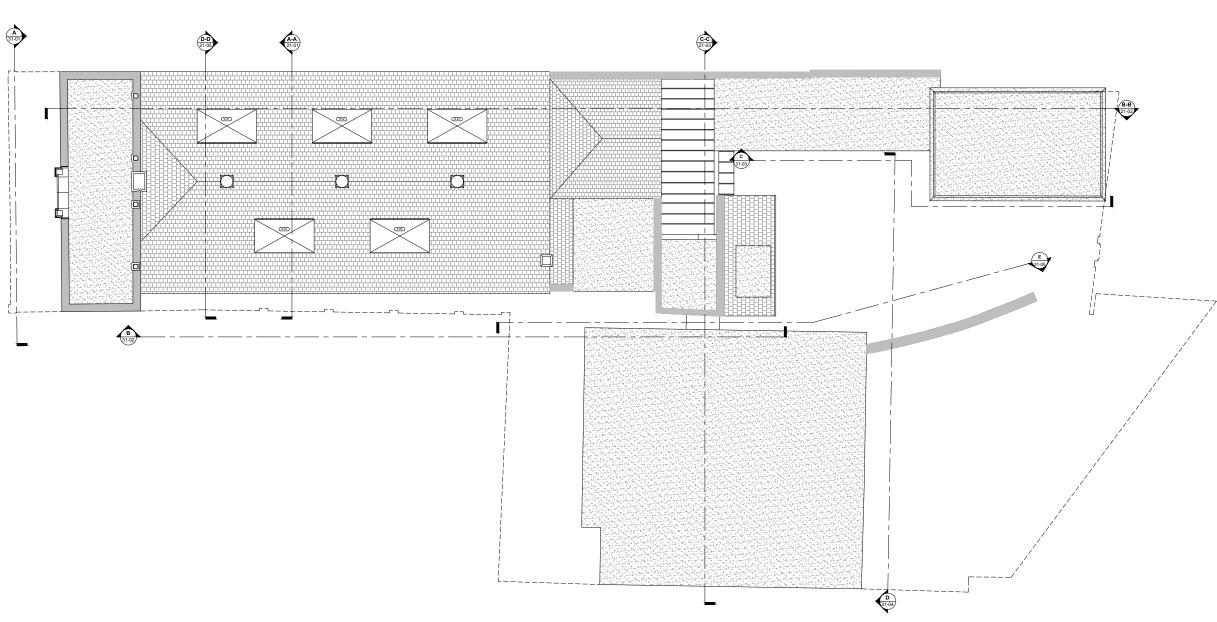

Please refer to RICS Code of Measuring for the precise definitions that permit the accurate measurement of buildings / land.

https://www.rics.org/uk/upholdingprofessional-standards/sector-standards/ real-estate/code-of-measuring-practice/

GENERAL NOTES

Accuracy Of Information

If any discrepancies exist between this drawing and site conditions or information provided by other consultants, contractors, sub-contractors, or if otherwise unclear, notify the architect immediately.



DRAWING KEY

SITE: 1197 m² GIA: 699 m² GARDEN: 348 m²

NEW PARTITION OR INFILL

EXISTING WALL

CEILING LEVEL

N/A FLOOR LEVEL

1:200 SCALE BAR

Metres 2

ISSUE

PLANNING

DATE

REVISION

DRAWING TITLE

EXISTING GA ROOF PLAN

SCALE

2109_KW_P1_DR_11-03

05.08.2021

30 Leighton Road Kentish Town, London, NW5 2QE




measurement of buildings / land.


https://www.rics.org/uk/upholding-

professional-standards/sector-standards/
real-estate/code-of-measuring-practice/

GENERAL NOTES

Accuracy Of Information
If any discrepancies exist between this drawing and site conditions or information provided by other consultants, contractors, sub-contractors, or if otherwise unclear, notify the architect immediately.

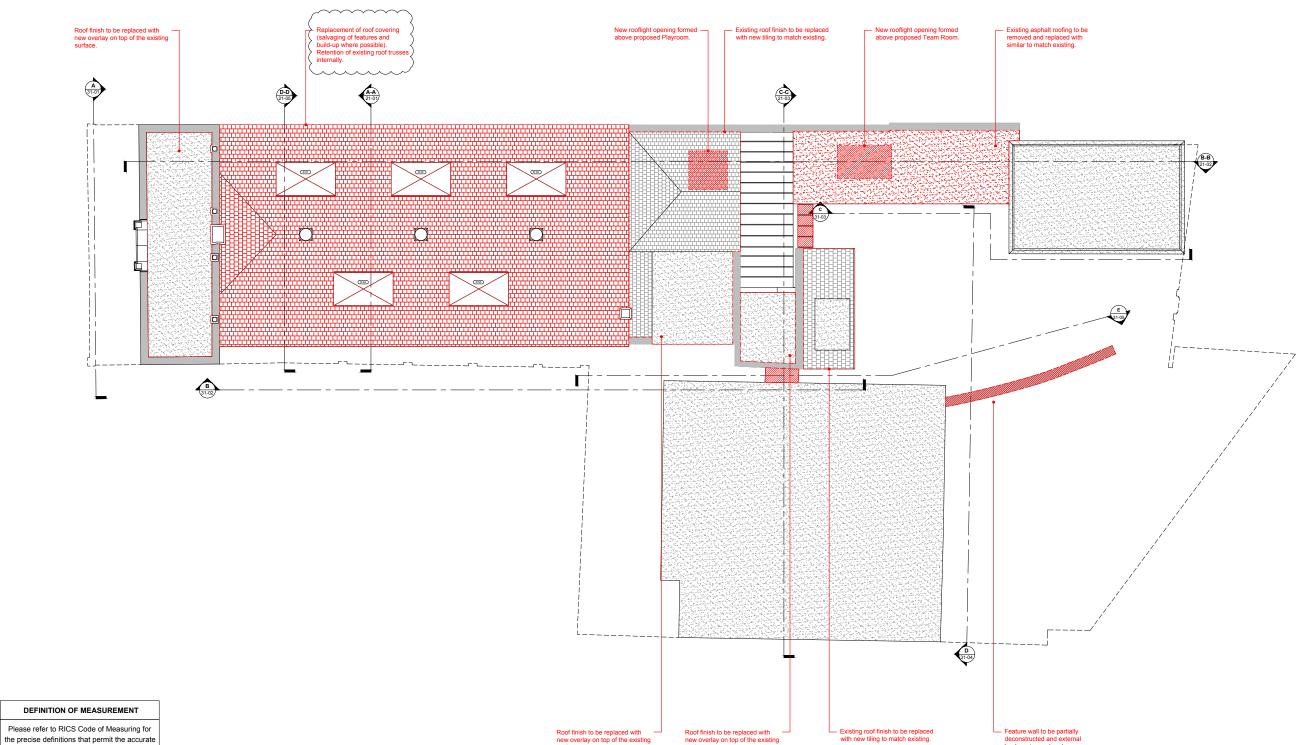

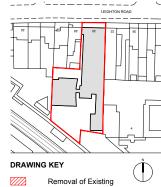

Removal of Wall Finishes
Removal of Floor / Ceiling

General Demolition Notes:

Structure

Take extreme care when removing existing structural elements. Refer to engineer's drawings for extent of demolition. The Contractor is responsible for the design of all temporary works / supports.

Health & Safety

The Contractor is responsible for ensuring adequate measures are taken to provide a safe working site at all times. Should harmful or toxic materials (eg. Asbestos) be discovered on site in areas not noted in the health & safety plan, Contractor to stop works in this area and immediately contact the project manager / architect to assess the proper and safe removal of the material.

Accuracy of Information

If any discrepancies exist between this drawing and site conditions or information provided by other consultants, contractors, sub-contractors, or if otherwise unclear, notify the architect immediately.

1:200 SCALE BAR

Metres 2 4 6

ISSUE

PLANNING

DATE **21.12.2021**REVISION 01

DRAWING TITLE

DEMOLITION ROOF PLAN

WG REF 2109_KW_P1_DR_12-03
CALE 1:200 (A3)

OJECT 30 Leighton Road

Kentish Town, London, NW5 2QE

Kennedy Woods

Unit B3.2 Bussey Building 133 Copeland Road,SE15 3S hello@kennedywoods.co.uk

is deaving in the copyright of Kennedy Woods Architecture Ltd and not be copied, altered or reproduced in any way or passed to a only life of the copied of



drawing and site conditions or information provided by other consultants, contractors,

sub-contractors, or if otherwise unclear, notify the architect immediately.

PERFORMANCE REQUIREMENTS FOR

Building considered a material change of use under the current building regulations, thus will require existing elements to be


upgraded to the minimum standards. Existing elements are required to achieve the following minimum U-Values (W/M².K):


External Walls 0.30/0.
Pitched Roof - Ceiling Level 0.16
Pitched Roof - Rafter Level 0.18

*A U-Value of 0.55 W/M².K is used for cavity wall insulation and 0.30 W/M².K for internal or external wall insulation.

0.30/0.55*

BUILDING ENVELOPE

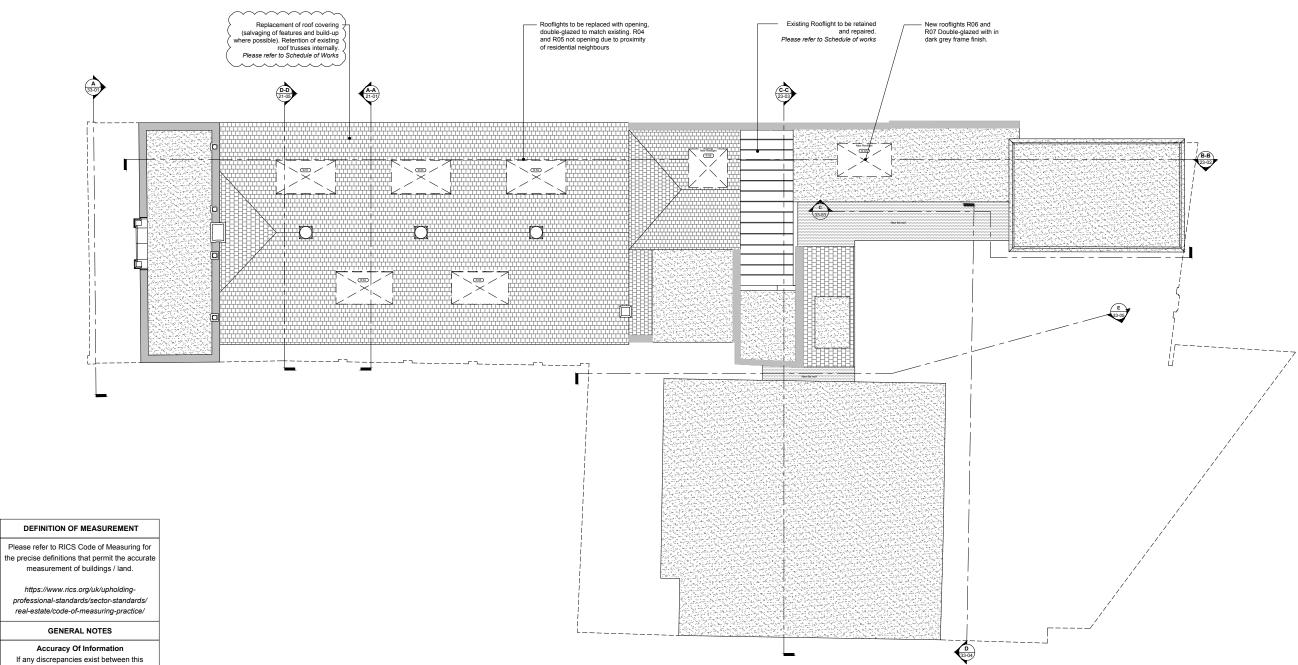

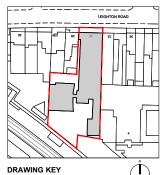

SITE: 1197 m² GIA: 743 m² GARDEN: 348 m²

NEW PARTITION OR INFILL EXISTING WALL FLOOR LEVEL

(c 4.15) N/A CEILING LEVEL

JG 01 JOINERY CODE

CUBBY HOLE JOINERY FULL HEIGHT STORAGE NAPPY CHANGE UNIT WS CHILD'S WATER STATION KITCHENETTE WM WASHING MACHINE TD TUMBLE DRYER AC AIR CONDITIONING UNIT AIR PURIFICATION UNIT HEATER RADIATOR CHILD HEIGHT HANDRAIL BLIND

OCCUPANCY: 33 BABIES 28 TODDLERS 56 PRESCHOOLERS -- SPECIALIST

TOTAL: 117 CHILDREN 30 STAFF

1:200 SCALE BAR

Metres 2

ISSUE

PLANNING

DATE 21.12.2021 REVISION 01

DRAWING TITLE

PROPOSED ROOF PLAN

DWG REF 2109_KW_P1_DR_13-03 SCALE 1:200 (A3)

PROJECT 30 Leighton Road London, NW5 2QE