




ELEVATION - A

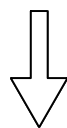


EXISTING DISTRIBUTION BOARD FIXED TO WALL

PROPOSED 2No. 0.6m DISH D3 & D4, HEIGHT 67.6m, BEARING 264°. MOUNTED ON NEW WALL MOUNTED CRANKED SUPPORT POLE VIA DISH BRACKETS.

PROPOSED GREENWOODS CABINET ON A NEW CANTILEVER BRACKET. FIXED TO WALL

PROPOSED 150mm WIDE WALL MOUNTED CABLE TRAY

ELEVATION - B

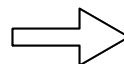

EXISTING HOOPED ACCESS LADDER

PROPOSED SUBMAIN ROUTE TO LANDLORDS DISTRIBUTION BOARD

EXISTING PLANT

EXISTING ROOF ACCESS DOOR

EXISTING DISTRIBUTION BOARD FIXED TO WALL

ROOF LEVEL  
+61.9m AGL

ROOF LEVEL  
+65.7m AGL

ROOF LEVEL  
+61.9m AGL

EXISTING DISTRIBUTION BOARD FIXED TO WALL

PROPOSED 2No. 0.9m DISHES D1 & D2, HEIGHT 66.4m, BEARING 85° MOUNTED ON NEW WALL MOUNTED CRANKED SUPPORT POLE VIA DISH BRACKETS. EXISTING HAND RAIL TO BE MODIFIED TO ACCOMMODATE PROPOSED UPGRADE

PROPOSED 150mm WIDE CABLE TRAY BRIDGED OVER EXISTING CTIL CABLE TRAY

EXISTING TEF STUB TOWER

EXISTING FREESTANDING HANDRAIL

EXISTING PLANT

EXISTING ROOF ACCESS DOOR

EXISTING DISTRIBUTION BOARD FIXED TO WALL

PROPOSED SITE PLAN  
SCALE: 1:125

GENERAL NOTES

- 1) ALL DIMENSIONS IN MILLIMETRES UNLESS STATED OTHERWISE
- 2) DRAWING IN ACCORDANCE WITH THE STANDARDS REFERENCED IN BS8888: 2000
- 3) THIS DRAWING TO BE READ IN CONJUNCTION WITH Drg. No's 100, 300, 400, 500, 501, 900, 901 & 902

**NLN**  
NEWLINE  
NETWORKS

Project No.	BCT	Comments	Date	Drn	App
B	COMMENTS	ACTIONED	18.11.21	SG	CT
A	FIRST ISSUE		04.08.21	SH	CT

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Site Name: BACTON TOWER

Site Ref: BCT

Scale: AS SHOWN


Date: 04.08.21 Drn: SH

Site Address:  
BACTON TOWER  
HAVERSTOCK ROAD  
LISMORE CIRCUS  
LONDON, NW5 4PX

Drawing Title:  
PROPOSED SITE PLAN

Drawing No.  
A3\_BCT\_200

App.  
CT

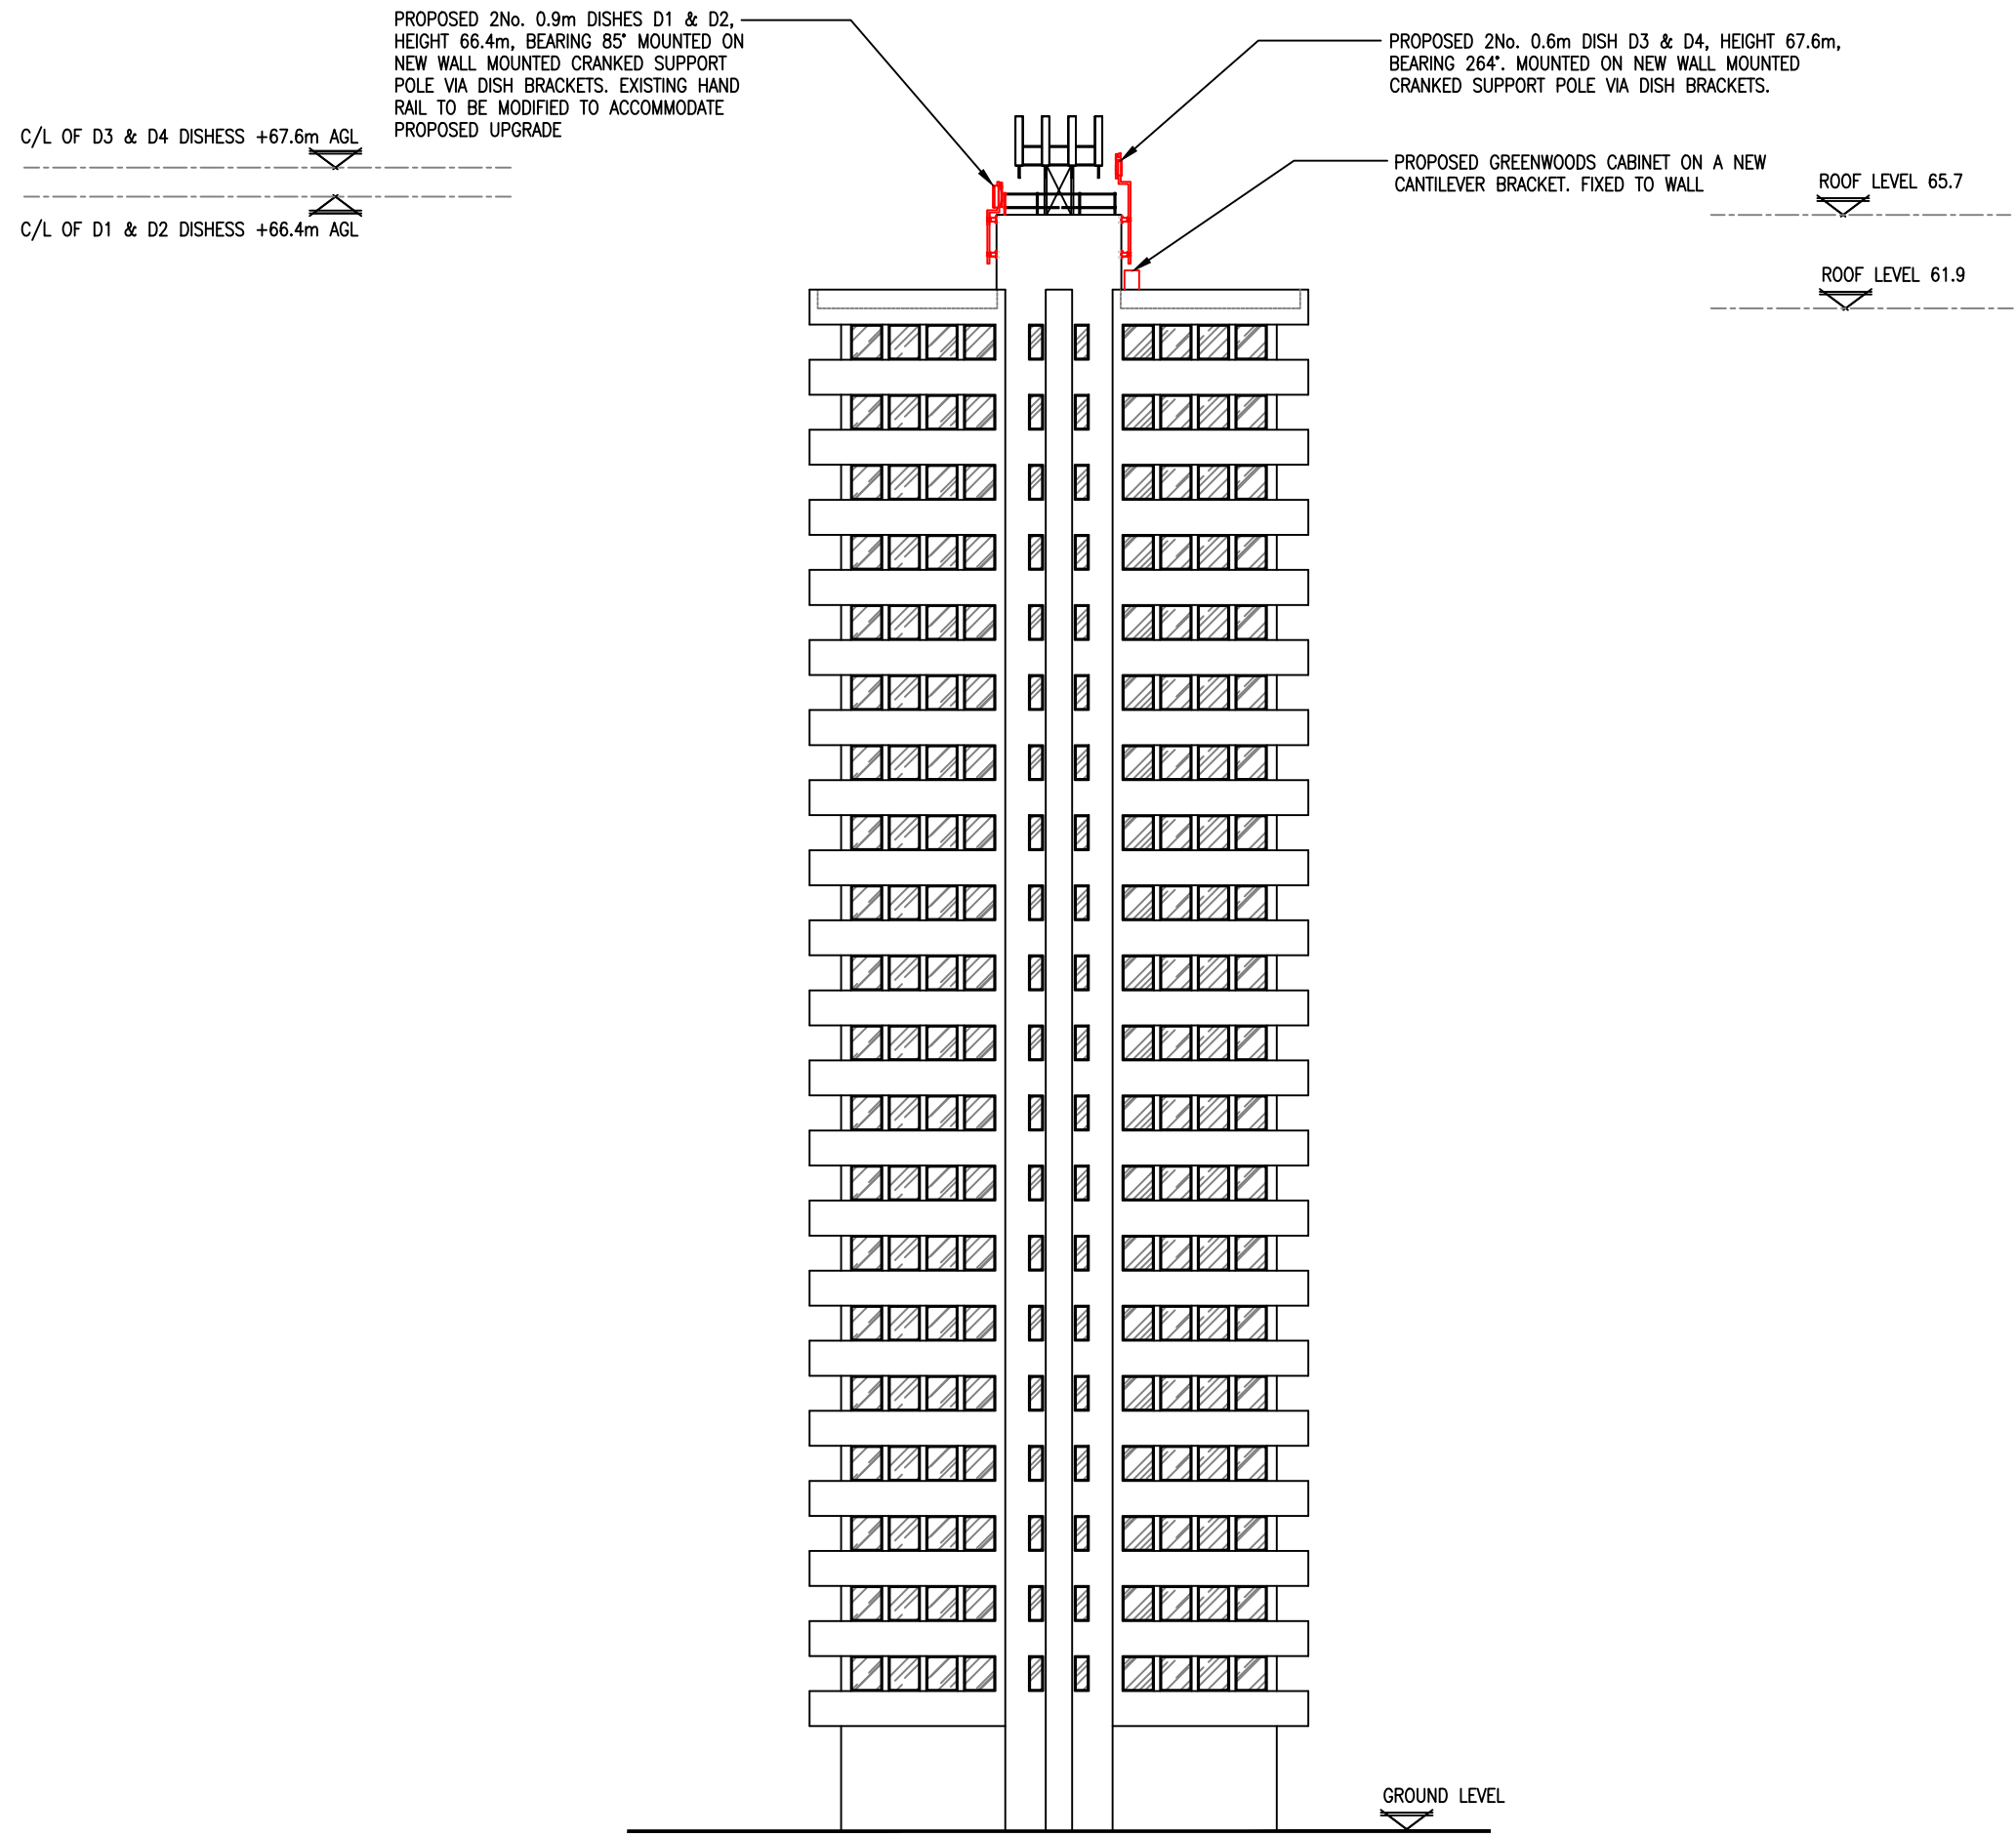

PROPOSED NORTH ELEVATION - A  
SCALE: 1:300

- GENERAL NOTES**
- 1) ALL DIMENSIONS IN MILLIMETRES UNLESS STATED OTHERWISE
  - 2) DRAWING IN ACCORDANCE WITH THE STANDARDS REFERENCED IN BS8888: 2000
  - 3) THIS DRAWING TO BE READ IN CONJUNCTION WITH Drg. No's 200, 400, 500, 600 & 700.



Project No.			
Project No.			
B	Project No. BCT COMMENTS ACTIONED	18.11.21	SG CT
A	Project No. BCT FIRST ISSUE	04.08.21	SH CT
Iss	Revision	Date	Drn App

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Site Name: BACTON TOWER

Site Ref: BCT

Scale: AS SHOWN

Date: 04.08.21 Drn: SH

Site Address:  
BACTON TOWER  
HAVERSTOCK ROAD  
LISMORE CIRCUS  
LONDON, NW5 4PX


Drawing Title:

PROPOSED ELEVATION - A

Drawing No. A3_BCT_300	App. CT
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PROPOSED 2No. 0.6m DISH D3 & D4, HEIGHT 67.6m,  
BEARING 264°. MOUNTED ON NEW WALL MOUNTED  
CRANKED SUPPORT POLE VIA DISH BRACKETS.

PROPOSED GREENWOODS CABINET ON A NEW  
CANTILEVER BRACKET. FIXED TO WALL

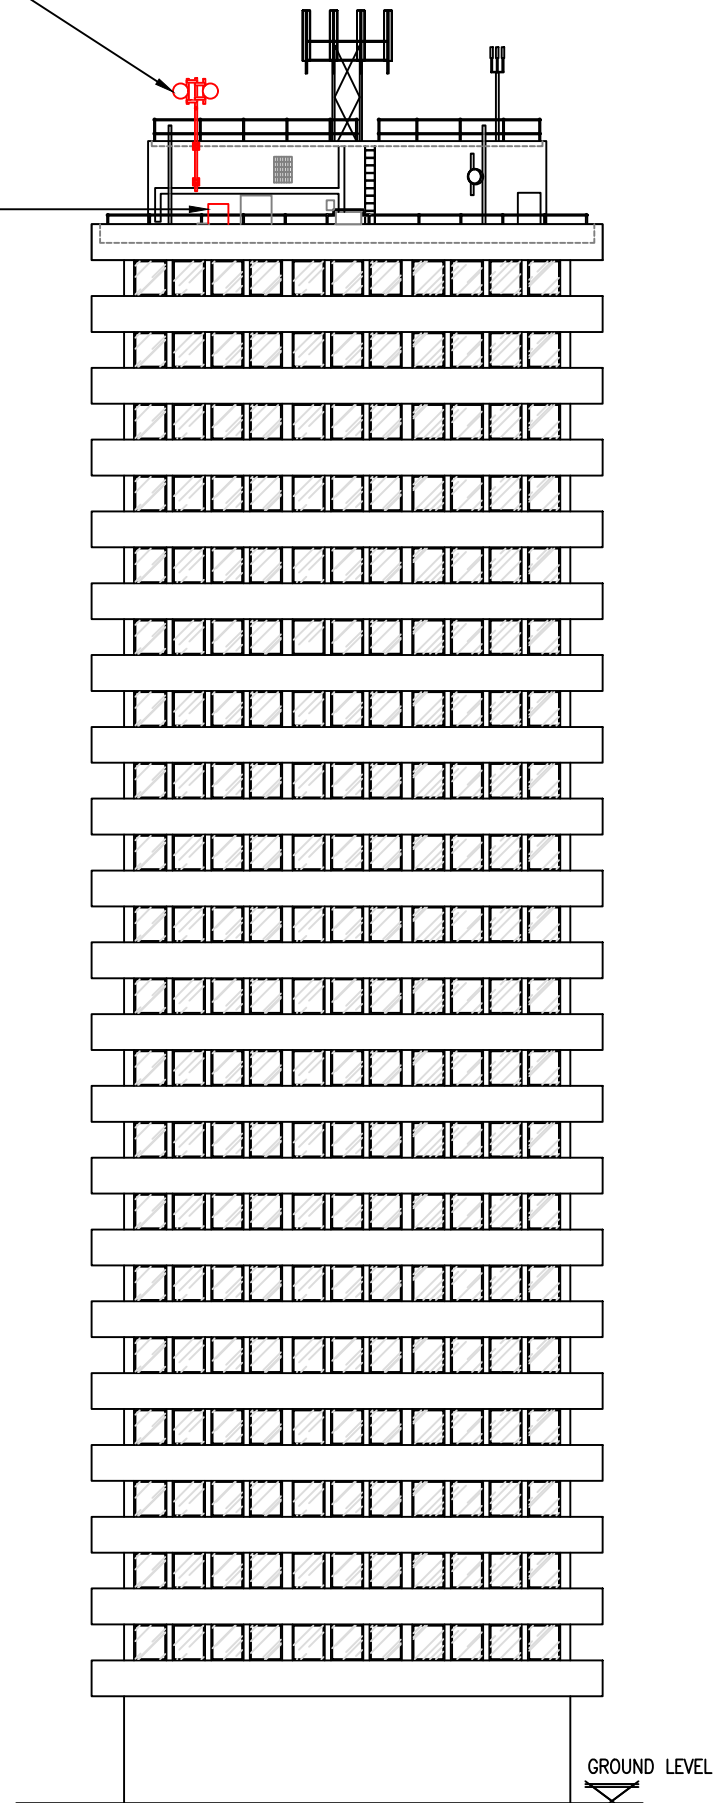

PROPOSED WEST ELEVATION -B  
SCALE: 1:300

GENERAL NOTES

- 1) ALL DIMENSIONS IN MILLIMETRES UNLESS STATED OTHERWISE
- 2) DRAWING IN ACCORDANCE WITH THE STANDARDS REFERENCED IN BS8888: 2000
- 3) THIS DRAWING TO BE READ IN CONJUNCTION WITH Drg. No's 200, 400, 500, 600 & 700.

**NLN**  
NEWLINE  
NETWORKS

Project No.				
Project No.				
B	Project No. BCT COMMENTS ACTIONED	18.11.21	SG	CT
A	Project No. BCT FIRST ISSUE	04.08.21	SH	CT
Iss	Revision	Date	Drn	App

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Site Name: BACTON TOWER

Site Ref: BCT

Scale: AS SHOWN

Date: 04.08.21 Drn: SH

Site Address:  
BACTON TOWER  
HAVERSTOCK ROAD  
LISMORE CIRCUS  
LONDON, NW5 4PX

Drawing Title:  
PROPOSED ELEVATION - B

Drawing No. A3\_BCT\_301 App. CT

PROPOSED SUPPORT STRUCTURE SCHEDULE

EXISTING/ PROPOSED	MANUFACTURER	TYPE	SIZE	COLOUR	STATUS	COMMENTS
PROPOSED	BESPOKE	WALL MOUNTED CRANKED POLE	Ø88.9	GALVANISED	NEW	2No. CRANKED POLE REQUIRED
PROPOSED	BESPOKE	DISH BRACKETS	-	GALVANISED	NEW	4No. REQUIRED

PROPOSED DISH SCHEDULE

DISH REF	DISH PART No.	BEARING	DISH SIZE	HEIGHT TO $\zeta$	FEEDER TYPE	LENGTH
D1	T.B.C.	85°	Ø0.9m	66.4m	COAX	11.0m
D2	T.B.C.	85°	Ø0.9m	66.4m	COAX	11.0m
D3	T.B.C.	264°	Ø0.6m	67.6m	COAX	10.0m
D4	T.B.C.	264°	Ø0.6m	67.6m	COAX	10.0m

- GENERAL NOTES
- 1) ALL DIMENSIONS IN MILLIMETRES UNLESS STATED OTHERWISE
  - 2) DRAWING IN ACCORDANCE WITH THE STANDARDS REFERENCED IN BS8888: 2000
  - 3) THIS DRAWING TO BE READ IN CONJUNCTION WITH Drg. No's 200, 300, 600 & 700.

**NLN**  
NEWLINE  
NETWORKS

Project No.			
Project No.			
Project No.			
B	Project No.   BCT COMMENTS ACTIONED	18.11.21	SG CT
A	Project No.   BCT FIRST ISSUE	04.08.21	SH CT
Iss	Revision	Date	Drn App

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Site Name: BACTON TOWER

Site Ref: BCT

Scale: AS SHOWN


Date: 04.08.21 Drn: BB

Site Address:  
BACTON TOWER  
HAVERSTOCK ROAD  
LISMORE CIRCUS  
LONDON, NW5 4PX


Drawing Title:  
DISHES & EQUIPMENT  
SCHEDULES

Drawing No.  
A3\_BCT\_400

App.  
CT

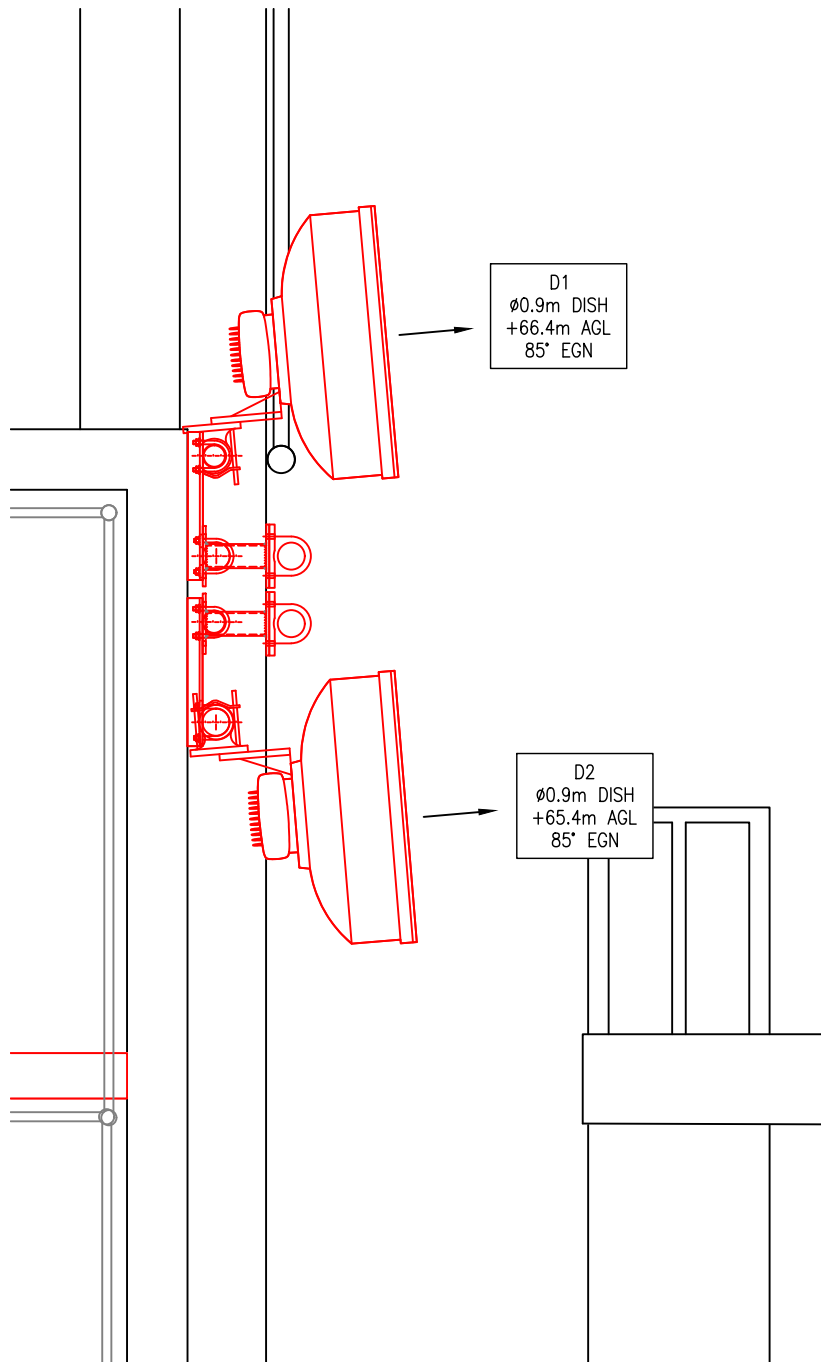

PROPOSED D1 & D2 DISH PLAN @ 65.4m A.G.L.  
SCALE: 1:25

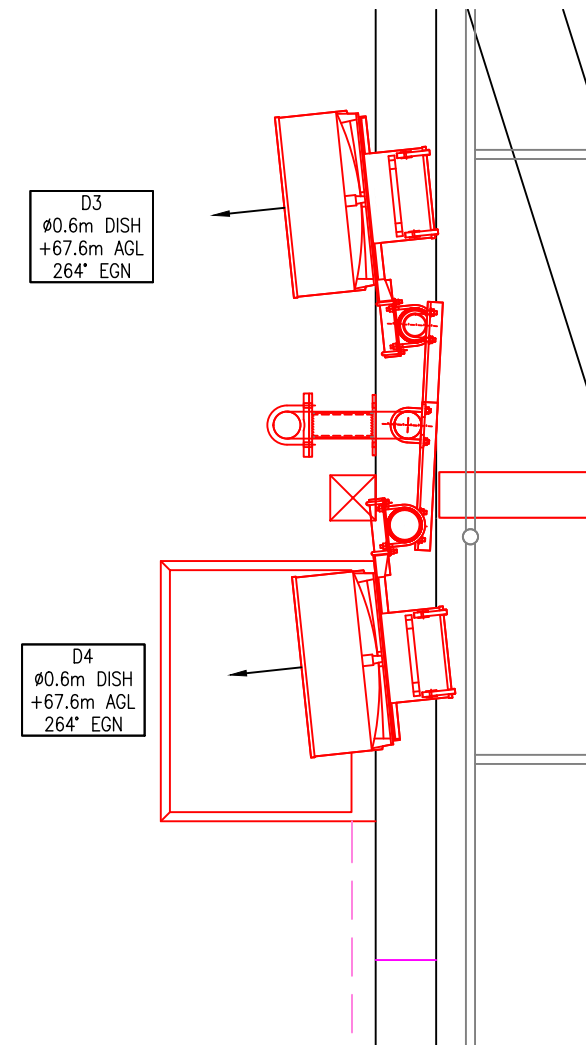

PROPOSED D3 & D4 DISH PLAN @ 65.3/66.1m A.G.L.  
SCALE: 1:25