

Materials Key

Fibre Cement Cladding routered panel in 3 x orientations to create patterned facade.

Valcan, Ceramapanel Natual + Range

New AHU to sit on existing link bridge - alterations to level access and widening of rails - please refer to Structural and M&E Engineers information for further details.

Existing window frame to be retained and existing glazing panel removed and infilled with spandrel panel - colour to match existing

Indicative ventilation intake and extract locations shown based on Stage 3 high level co-ordination with M&E Engineers. These locations and dimensions require further review and co-ordination

Indicative ventilation ducting locations shown based on Stage 3 high level co-ordination with M&E Engineers. These locations and dimensions require further review and co-ordination so are subject

Proposed door Aluminium framed double / single doorset with glazed infil panels.
Frame Colour: Grey (RAL to be confirmed)

New mesh fence with door gate for plant room access. Ducts penetrations to be set up prior to order. RAL Colour TBC. Door

New Proposed Door Aluminium framed double / single doorset with glazed infil panels
Frame Colour: Grey (RAL to be confirmed)

g Dichroic film application and manifestation to internal link bridge glazing , design TBC.

New louvred screen supported by steel frame as per SE design information. Colour Light Grey RAL TBC

Existing balustrade and associated infill mesh /pigeon mesh to remain as existing facade.

Relocation of external door, existing door to be infilled with matching brick.

Colours:
 Ripe Mango (Natural +2051)
 Limestone (Natural +2001)
 Chalk Board (Natural +2031)

2 Aluminium framed clear glazed window Frame Colour: Grey (RAL to be confirmed)


so are subject to amendments.

Gap: Dark grey RAL TBC

window frames.


to amendments.

ironmongery tbc

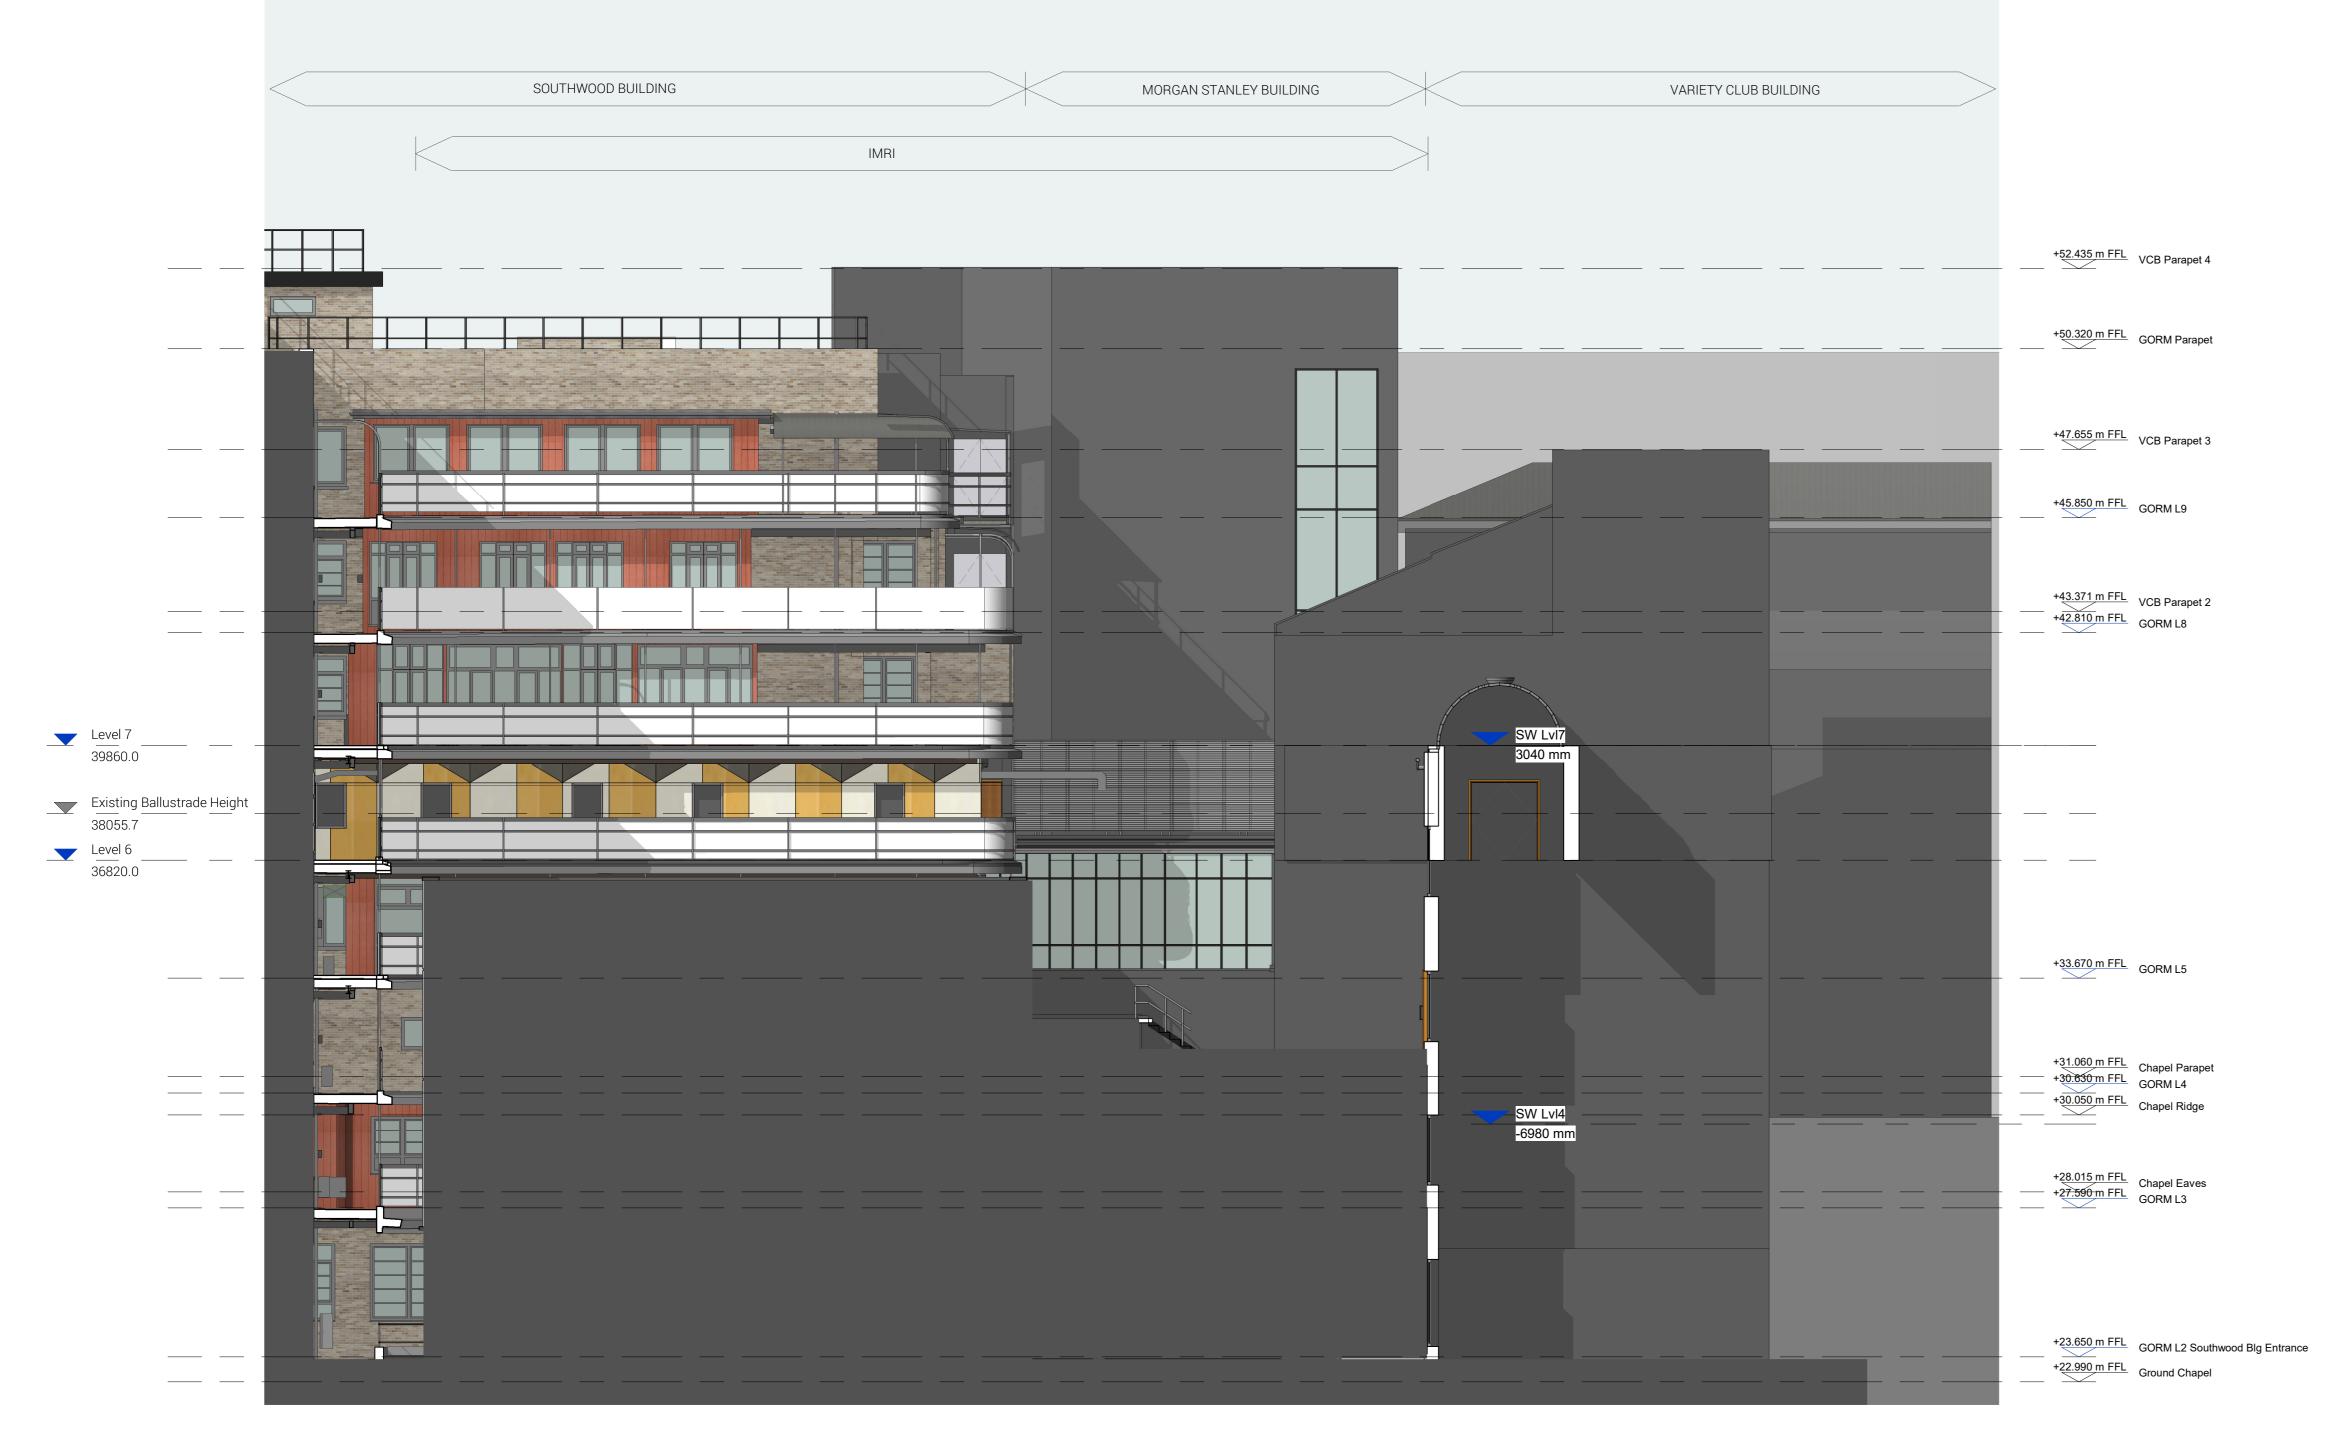

Proposed Elevation 4a

1 0 1 2 3 4 5 SCALE 1:100 m

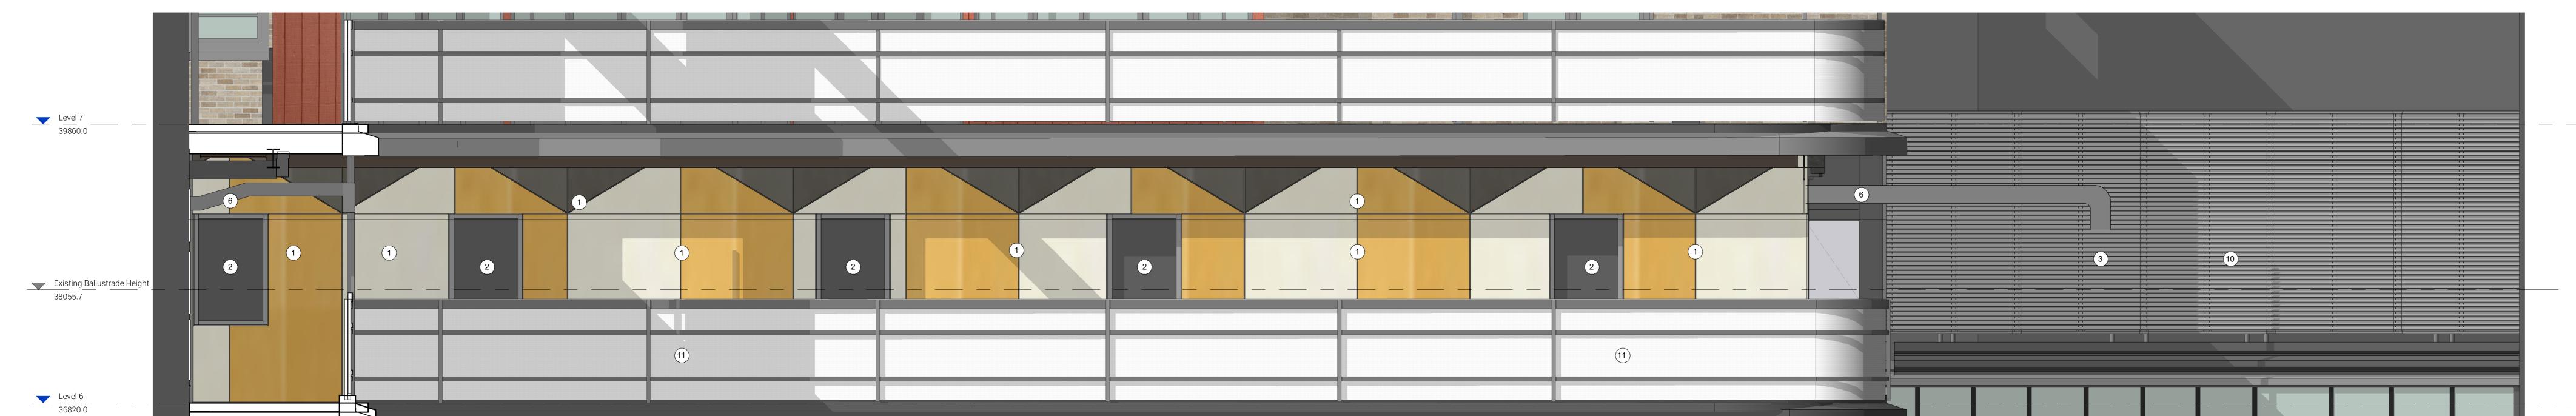

Proposed Elevation 4a Zoom in

200 0 200 400 600 800 1000 SCALE 1:25 mm

| SENERAL NOTES: | |
|----------------|--|

discrepancies to the Architect / Designer.

DAY Architectural Ltd accepts no responsibility for any costs, losses or claims whatsoever arising from these drawings, specifications and related documents unless there is full compliance with the Client or any unauthorised user of the following:

1 All boundaries, dimensions and levels are to be checked on site before construction and any discrepancies reported to the Architect / Designer.

2 Partial Service: Any discrepancies with site or other information is to be advised to the Architect / Designer and direction and / or approval is to be sought before the implementation of the detail.

3 Block and site plans are reproduced under license from the Ordnance Survey.

4 Do not scale this drawing.

5 For the purpose of coordination, all relevant parties must check this information prior to implementation and report any

PROJECT
Psychological and I

 14.12.21
 SM

 DATE
 REV BY

P1 Issued for Planning
REV DESCRIPTION

Great Ormond Street Hospital for Childrens NHS
Foundation Trust

DRAWING
Proposed Elevation 4 _Courtyard Elevation 1

SUITABILITY

PLANNING

PROJECT
Psychological and Mental Health Services (PAMHS)

Project | Client ref | Drawn BY | CHECKED BY |
BE2001 | GOSH | SM | LI |

ORIGIN | VOLUME | LEVEL | TYPE | ROLE | NUMBER | REVISION |
DAY | 00 | XX | DR | A | 07-1104 | P1 |

Studio 1, Lancaster Buildir

Information contained on this drawing is the sole copyright of DAY Architectural Ltd. and is not to be reproduced without their permission.

FIRST ISSUED

13.12.21

CHECKED BY

LI

UMBER REVISION
7-1104 P1

DAY Architectural Ltd.
Studio 1, Lancaster Buildings
77 Deansgate, Manchester, M3
2BW

T: 0161 834 9703
W: www.day-architectural.com