



Swiss Cottage Library Decarbonisation Works

Window Schedule

Camden Council

24 November 2021



Notice

This document and its contents have been prepared and are intended solely as information for Camden Council and use in relation to the replacement window works which are being undertaken as part of the wider decarbonisation project works.

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This document has 12 pages including the cover.

Document history

Document title: Window Schedule

Revision	Purpose description	Originated	Checked	Reviewed	Authorised	Date
1.0	For Planning	JH	RJ	RJ	JMcS	24.11.21
2.0	For Planning	JH	RJ	RJ	JMcS	01.12.21

Client signoff

Client	Camden Council
Project	Swiss Cottage Library Decarbonisation Works
Job number	5206133
Client signature/date	



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Introduction

The information contained within this report is to supplement the current planning application no. 21/2/07865 for the decarbonisation works at Swiss Cottage Library, 88 Avenue Road, London, NW3 3HA.

Appendices

Contains sensitive information 1.0 | 24 November 2021 Atkins



Appendix A. Images of Building Elevations


















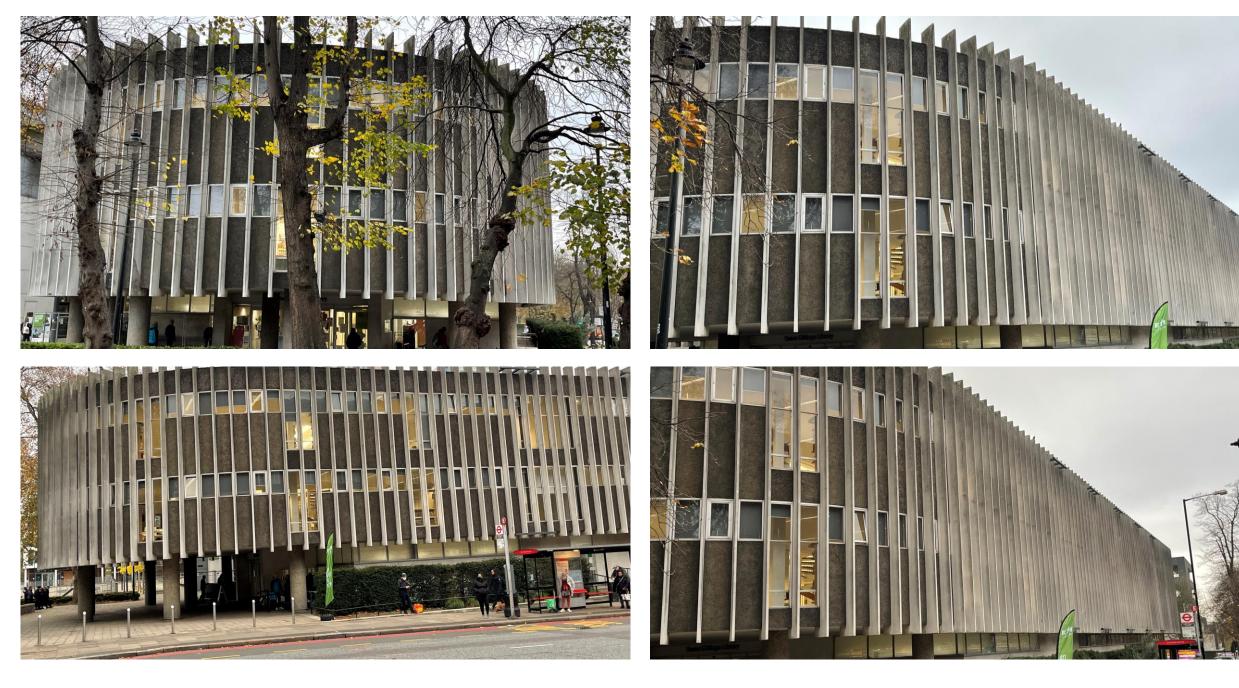














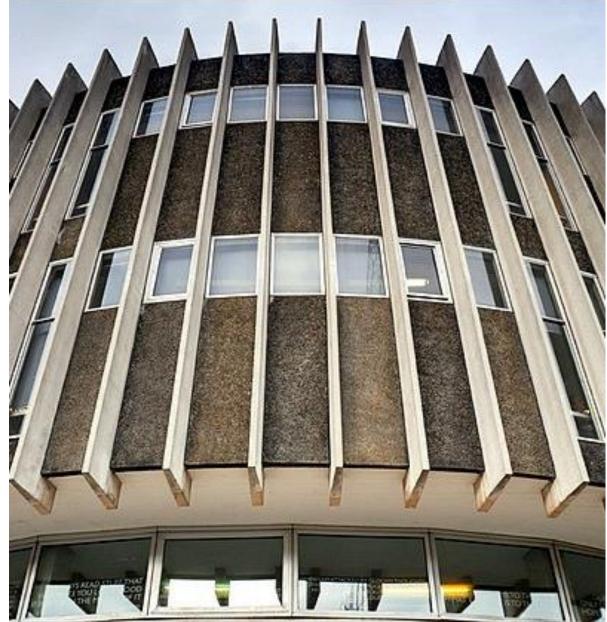



Appendix B. Photo Schedule Showing Existing Window Types



A1 - Fixed (1)



A2 - Centre Pivot (1)



A1 - Fixed (2)



A2 - Centre Pivot (2)



A3 - Slides (1)



A3 - Slides (3)



A3 - Slides (2)



B2 - Fixed (1)



B2 - Fixed (2)



B2 - Slides (1)



B2 - Fixed (3)



B2 - Slides (2)



B2 - Slides (3)



B2 - Slides (4)



E1 - Fixed (1)







E2 - Centre Pivot (1)



E2 - Centre Pivot (2)



E3.5 – Fixed / Openable (1)



E4 - Openable (1)



E4 - Openable (2)



E4 - Openable (3)



E4 - Openable (4)



F1 - Fixed (1)



F1 - Fixed (2)



F1 - Fixed (4)



F1 - Fixed (3)



F2 - Top Part Centre Pivot (1)



F2 - Top Part Centre Pivot (2)



F2 - Top Part Centre Pivot (4)



F2 - Top Part Centre Pivot (3)







G1 - Fixed (2)



G1 - Fixed (3)



G1 - Fixed (4)



H1 - Fixed (1)



H1 - Fixed (2)



H1 - Fixed (3)



H1 - Fixed (4)



Type A - Door (1)



Type A - Door (2)



Type A - Door (3)



Type A - Door (4)





Appendix C. Window Schedule

		Exist	ting		Proposed					
Window	Туре	Location	Number	Status	Window	Туре	Location	Number		
A1	Fixed	FF/SF	236	Considered original	A1	Fixed	FF/SF	329		
A2	Centre Pivot	FF/SF	94	Considered original	A2	Openable / Top Hung	FF/SF	1		
A3	Slides	FF/SF	2	Considered original	A3	Openable / Top Hung	FF/SF	2		
B2	Slides	FF/SF	104	Considered original	B1	Openable / Top Hung	FF	1		
B2	Fixed	FF/SF	12	Considered original	B2	Fixed	FF/SF	115		
E1	Fixed	GF	58	Considered original	E1	Fixed	GF	77		
E2	Openable	GF	12	Considered original	E2	Openable / Top Hung	GF	4		
E3.5	Fixed/Openable	GF	4	Considered original	E3.5	Fixed/Openable	GF	4		
E4	Openable	GF	12	Replacement	E4	Openable / Top Hung	GF	1		
F1	Fixed	FF	15	Considered original	F1	Fixed	FF	19		
F2	Top part centre pivot	FF	5	Considered original	F2	Openable / Top Hung	FF	1		
G1	Fixed	GF	2	Considered original	G1	Fixed	GF	2		
H1	Fixed	GF	2	Considered original	H1	Fixed	GF	2		
Door A	Openable	GF	1	Considered original	Door A	Openable	GF	1		
			Total: 559					Total: 559		






Appendix D. Existing and Proposed Elevations (Colour)

Existing and proposed window types have been shown in different colours.




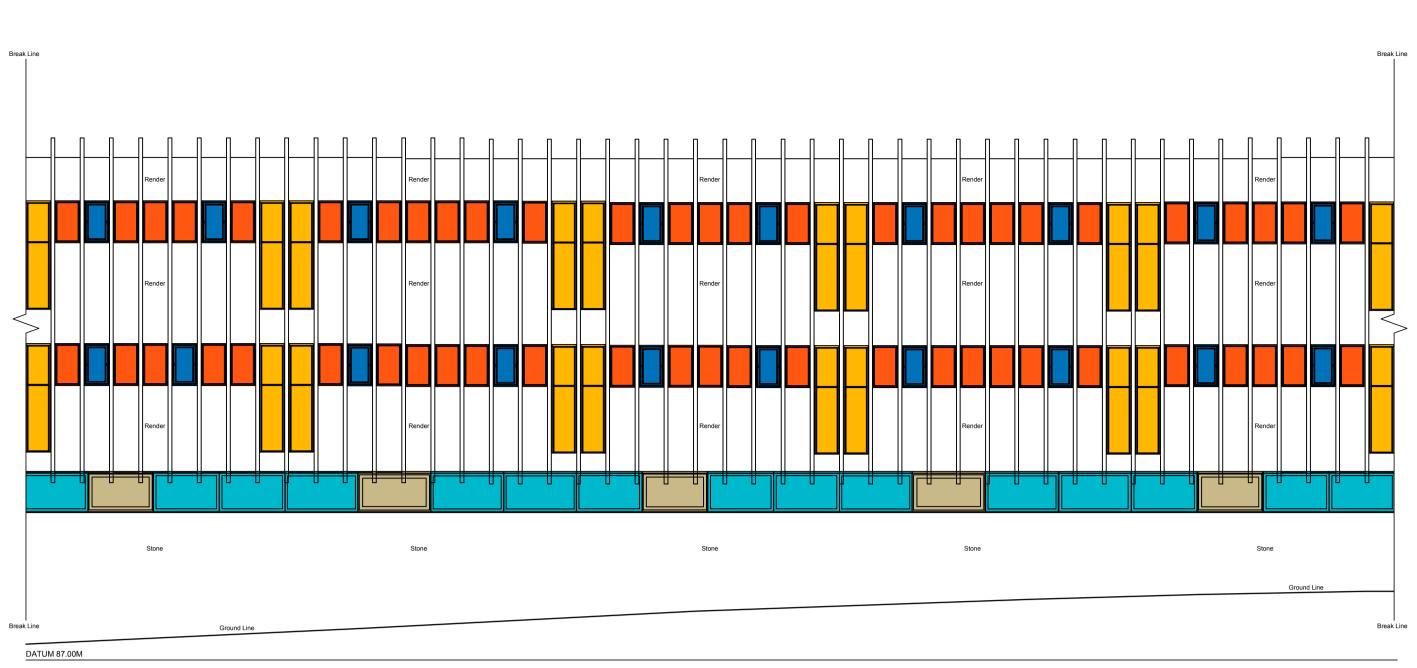


EXISTING SOUTH ELEVATION



SCHEDULE OF PROPOSED WINDOWS

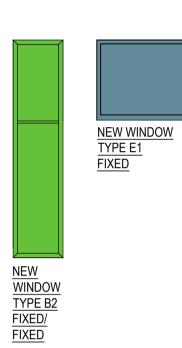

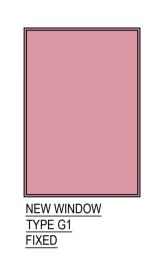



пп n n n JU Stone Stone Stone Break Line DATUM 87.00M

PROPOSED SOUTH ELEVATION

SAFETY, HEALTH AND ENVIRONMENTAL INFORMATION							Drawing Status PLANNIN
In addition to the hazards/risks normally associated with the types of work detailed on this drawing, note the following:							ATIZINIC
CONSTRUCTION							
MAINTENANCE/CLEANING							Copyright © Atkins Limited (20
							Client
DECOMMISSIONING/DEMOLITION							
							LONDON BOR
It is assumed that all works will be carried out by a competent contractor	P2	29.11.2021	Revisions to Proposed Window types and Styles	JEL	JH	JH	
working, where appropriate, to an approved method statement	Rev.	Date	Description	Ву	Chk'd	App'd	



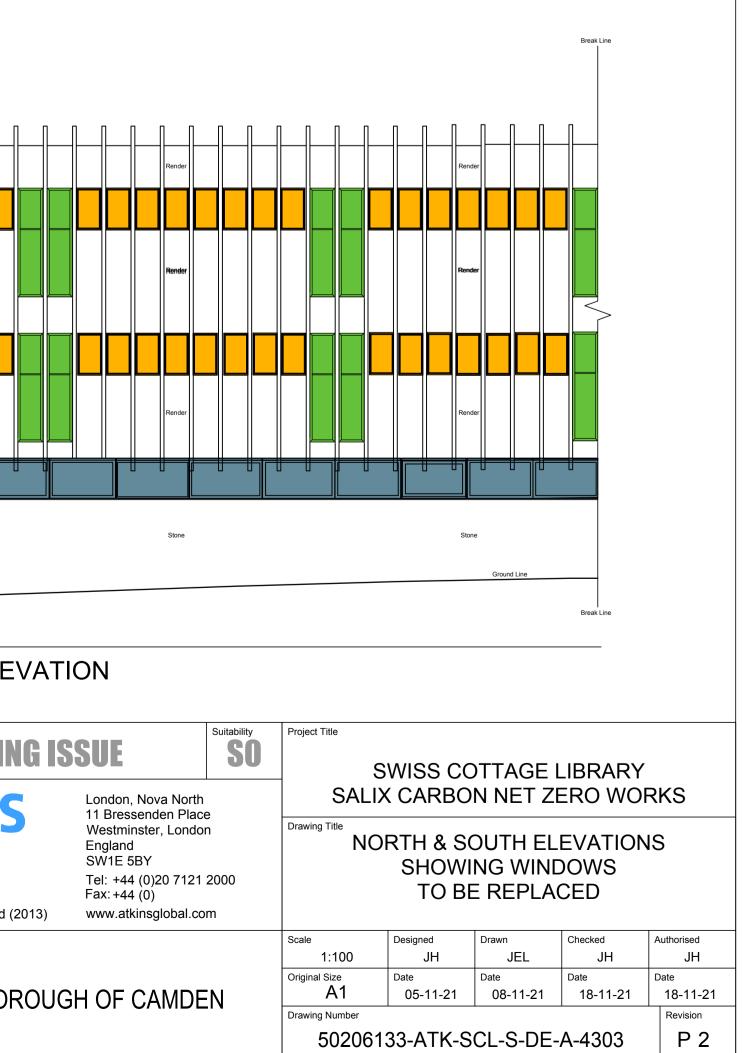


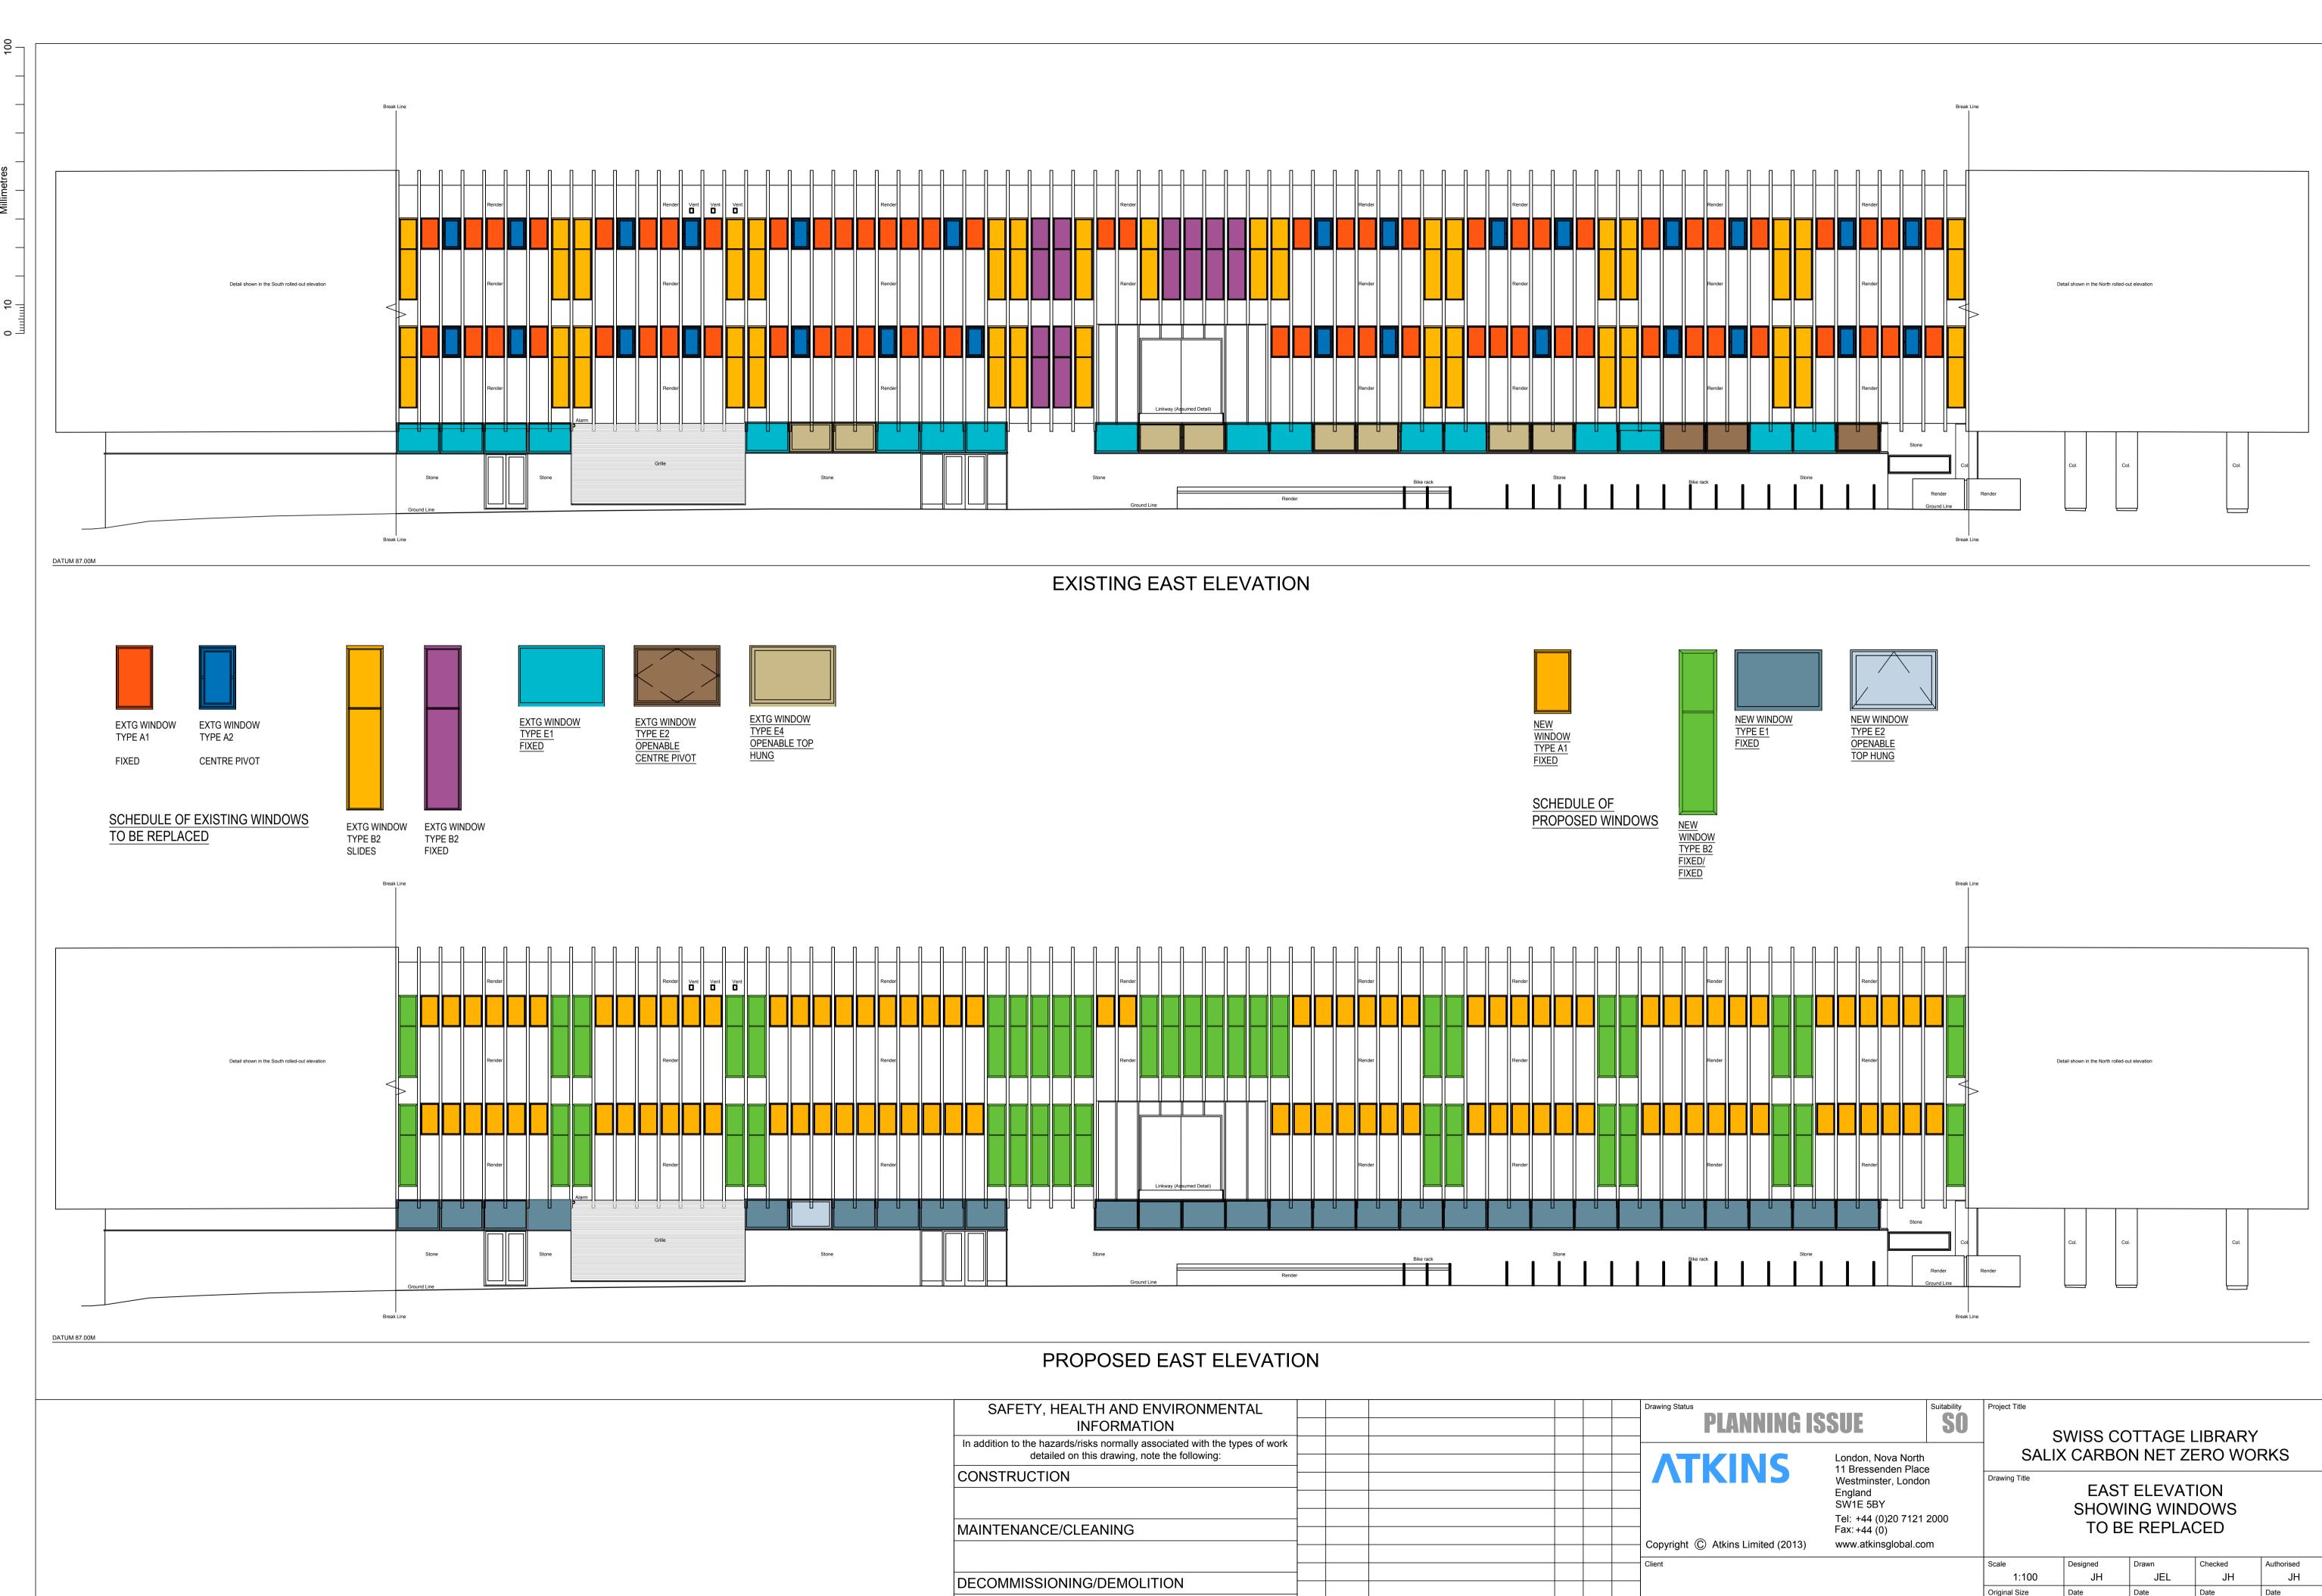

SAFETY, HEALTH AND ENVIRONMENTAL INFORMATION							Drawing Status PLANNIR
In addition to the hazards/risks normally associated with the types of work detailed on this drawing, note the following:							
CONSTRUCTION							ATKINS
							-
MAINTENANCE/CLEANING							Copyright © Atkins Limited (
							Client
DECOMMISSIONING/DEMOLITION							
							LONDON BOF
It is assumed that all works will be carried out by a competent contractor working, where appropriate, to an approved method statement	P2 Rev.	29.11.2021 Date	Revisions to Proposed Window Types and Styles Description	JEL By	JH Chk'd	JH App'd	

Original Size Date Date Date Date A1 05-11-21 08-11-21 18-11-21 18-11-21 Drawing Number Revision 50206133-ATK-SCL-S-DE-A-4302 P 2

DROUGH OF CAMDEN

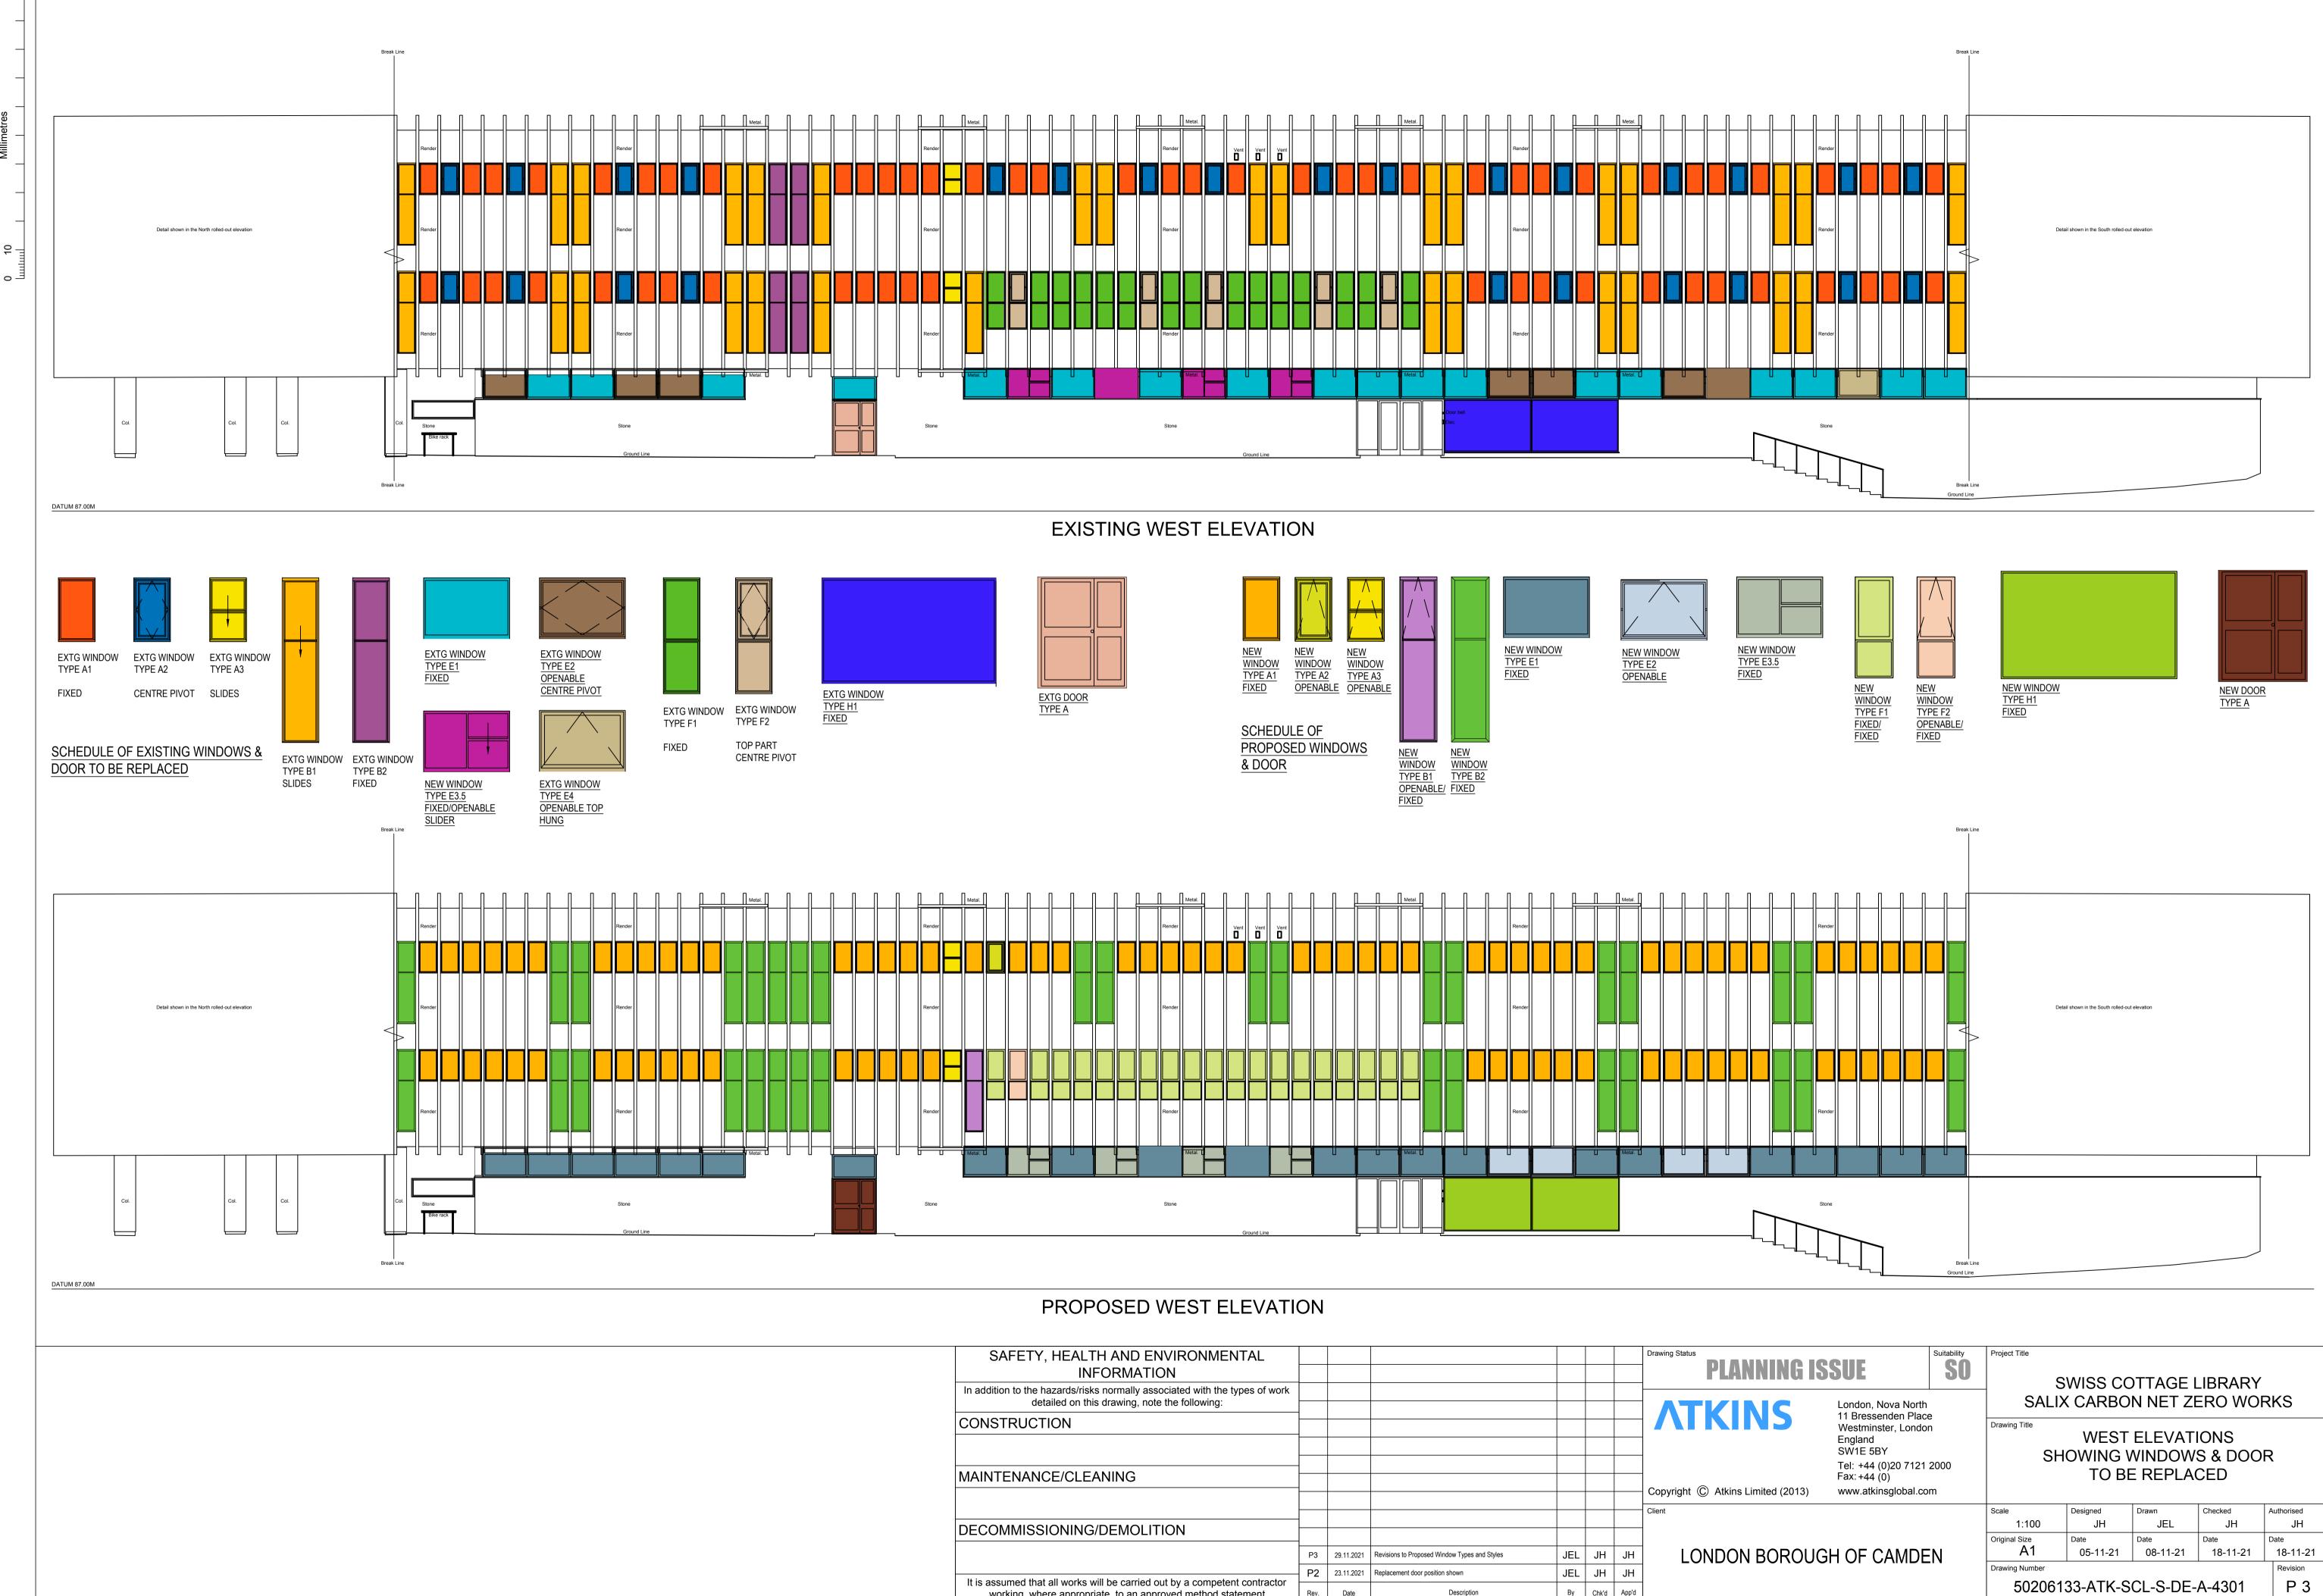

	1	1		1	1		
SAFETY, HEALTH AND ENVIRONMENTAL							Drawing Status
INFORMATION							PLANNI
In addition to the hazards/risks normally associated with the types of work detailed on this drawing, note the following:							
CONSTRUCTION							ATKINS
							-
MAINTENANCE/CLEANING							-
	-						Copyright (C) Atkins Limited
							Client
DECOMMISSIONING/DEMOLITION							-
	P3	29.11.2021	Revisions to Proposed Window Types and Styles	JEL	JH	JH	LONDON BOI
	P2	23.11.2021	Replacement door position shown	JEL	JH	JH	
It is assumed that all works will be carried out by a competent contractor working, where appropriate, to an approved method statement	Rev.	Date	Description	Ву	Chk'd	App'd	1

NG ISSUE Suitability		Project Title SWISS COTTAGE LIBRARY						
S	London, Nova North 11 Bressenden Plac Westminster, Londo England SW1E 5BY Tel: +44 (0)20 7121	e n	Drawing Title WEST ELEVATIONS SHOWING WINDOWS & DOOR TO BE REPLACED					
(2013)	Fax: +44 (0) www.atkinsglobal.co	m		IOB	E REPLA	CED		
			Scale 1:100	Designed JH	Drawn JEL	Checked JH	Authorised JH	
ROUGH OF CAMDEN			Original Size	Date 05-11-21	Date 08-11-21	Date 18-11-21	Date 18-11-21	
		-1 7	Drawing Number			•	Revision	
			50206 [,]	122 ATV C		A 1201	D 2	



Appendix E. Manufacturer's Information (Proposed Windows and Door)

Casement Product Selector

AA®720 Standard Casement Window

Introduction

The AA®720 Casement Window is part of the AA®720 range of The AA®720 Casement Window has been independently tested Windows and Doors. In line with the existing range, the AA®720 Casement is available in a range of increasing levels of thermal performance – incorporating Kawneer's latest Reflex unique thermal break technology.

The AA®720 Casement Windows are available as top hung or side hung windows and can be either internally or externally glazed. Additional advantages of the advanced thermal break technology include the options of dual colour finishes, to provide design flexibility in various applications.

Product Features and Benefits

- BRE Green Guide 'A' Rated Frame* for projects that require sustainable and environmental advantages
- Range of locking options available for flexibility. Choose from standard Espagnolette locking to enhanced security in line with PAS 24:2016
- Option of Trickle Ventilation can help meet the requirements of Document F
- Projected top hung or side hung or butt hinge options total flexibility, suits most casement project applications
- Suites with the AA®720 series, AA®100/AA®110 Curtain Walling, 451PT Framing and Door Systems
- Offset handle position for side hung windows. Safety in use - suitable for 'Lifetime Homes' Specification
- Choice of restrictors available to 100mm. Design flexibility. Compliant with the HTM 55 regulations and BS 8213 of 100mm initial opening
- Folding Openers with Link Bars offer safety in use
- Maximum size 2300mm(W) x 2500mm(H) suitable in even the most demanding of applications
- Suited hardware compatible hardware to compliment the AA®720, AA®540 and AA®3720 ranges
- Outside glaze option (not PAS 24 compliant)

Security**


to PAS 24:2016.

** Does not refer to standard hardware, security hardware required.

Secured by Design

Official Police Security Initiativ

* Corresponds to the BRE Global Green Guide online generic specification for windows and achieves a summary rating of A for non-domestic schemes. www.thegreenguide.org.uk Element Number 1231500007

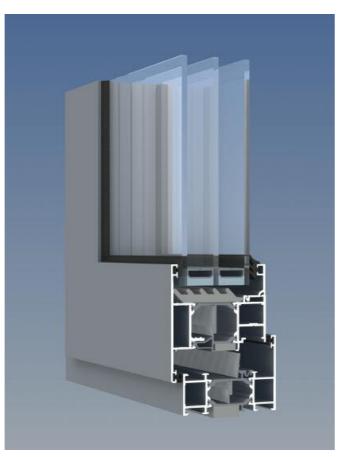

AA®720 HI Reflex^{Plus} Casement Window

Performance	AA®720 Casement*	AA®720 SL Casement	AA [®] 541 Casement
Weather Performance (BS 6375)			
Security to PAS 24:2016			
Uw (Double Glazing)	1.5 W/m²K	1.6 W/m²K	1.8 W/m ² K
Uw (Double Glazing with warm edge spacer)'	** 1.3 W/m²K	1.4 W/m²K	1.6 W/m ² K
Uw (Triple Glazing)	1.2 W/m ² K	1.2 W/m ² K	1.5 W/m²K
Uw (Triple Glazing with warm edge spacer)***	* 1.0 W/m²K	1.1 W/m²K	1.3 W/m²K
Special Features			
BRE Green Guide Rating ^o	А	А	A+
Design Features			
Dual Colour Option	•		
Composite Windows			
Ribbon Windows			
Punched Out Openings	•	•	
Triple Glazing			■+
Infills:	upto 56mm	upto 42mm	upto 39mm
Standard Hardware Groove			
Multi-Point / Single Sided Locking Options			
100mm Restriction			
Trickle Ventilation	•		
Locking Handles			
Folding Openers			
Cockspur Handle			
Espagnolette Handle			
Friction Hinges			
Butt Hinges			
Variable Angle Corner Post			
System Depth			
54mm			
72mm			
Maximum Window Sizes•	upto	upto	upto
Projected Top Hung●	2300mm(W) x 2500mm(H)	1500mm(W) x 1500mm(H)	1800mm(W) x 1800mm(H
Projected Side Hung•	845mm(W) x 1900mm(H)	900mm(W) x 1500mm(H)	845mm(W) x 1800mm(H
Top Hung with Butt Hinges•	1800mm(W) x 1600mm(H)		1800mm(W) x 1600mm(H
Side Hung with Butt Hinges•	900mm(W) x 1900mm(H)		900mm(W) x 1800mm(H
Applications			
New Build	•		
Refurbishment			

** Window Energy Ratings and U-values based on CEN size windows (1230mm x 1480mm) using 1.0 W/m²K double glazing with warm edge (0.048 W/m²K) spacer

*** U-values based on CEN size windows (1230mm x 1480mm) using 0.6 W/m²K triple glazing with warm edge (0.043 W/m²K) spacer. + Optional/Limited

• Height and Width Limitations vary dependant on glass weights and hardware requirements – please check with the Technical Services Department ^o Corresponds to the BRE Global Green Guide online generic specification for windows and achieves a summary rating of A and A+ for nondomestic schemes. www.thegreenquide.org.uk Element Number 1231500011 (A+) Element Number 1231500007 (A)




www.kawneer.co.uk

AA®720 Standard Casement Window Applications

Typical Elevations

Full details can be downloaded from our website www.kawneer.co.uk

Elevation		Title		Website	CAD ref. no.	
			AA®720 HI Reflex ^{Plus}	AA®720 HI Reflex	AA®720 HI	AA®720 HW
·	1, 2 3, 4	Fixed Light Head and Cill (inside glazed) Fixed Light Jamb (inside glazed)	H24-3 H24-4	H4-3 H4-4	H4-3 H4-4	H4-53 H4-54
7-Ext. Glass	5, 6 7, 8	Fixed Light Head and Cill (outside glazed) Fixed Light Jamb (outside glazed)	H24-5 H24-6	H4-5 H4-6	H4-5 H4-6	H4-55 H4-56
EX. Gased	9	Casement/Fixed Light Muntin	H24-9	H4-9	H4-9	H4-59
	10	Casement Curtain Wall Insert - Head	H24-7 & H24-8	H4-7 & H4-8	H4-7 & H4-8	H4-57 & H4-58
	11	90° Corner (Casement/Fixed Light)	H24-10	H4-10	H4-10	H4-60
	12	135° Corner (Casement/Fixed Light)	H24-11	H4-11	H4-11	H4-61
9	13	Coupling Mullion	H24-12	H4-12	H4-12	H4-62
	14, 15	Casement Jamb Detail (inside glazed vent)	H24-13	H4-13	H4-13	H4-63
Ř	16, 17	Casement Head and Cill Detail (inside glazed vent)	H24-13	H4-13	H4-13	H4-63
a for the second	18, 19	Casement Jamb Detail (outside glazed vent)	H24-14	H4-14	H4-14	H4-64
20 Centre Jan	20, 21	Casement Head and Cill Detail (outside glazed vent)	H24-14	H4-14	H4-14	H4-64

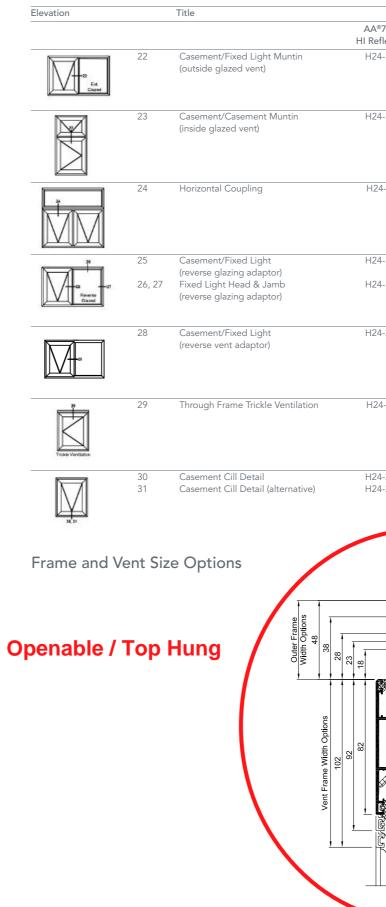




		e CAD ref. no.	
20 Plus	AA®720 HL Rofley	AA®720 HI	AA®720 HW
ex ^{Plus}	HI Reflex H4-15	H4-15	H4-65
	U - F I J	01-11	00-411
16	H4-16	H4-16	H4-66
17	H4-17	H4-17	H4-67
18	H4-18	H4-18	H4-68
19	H4-19	H4-19	H4-69
20	H4-20	H4-20	H4-70
21	H4-21	H4-21	H4-71
23 24	H4-23 H4-24	H4-23 H4-24	H4-73 H4-74


AA®720 Standard Casement Window

Full details can be downloaded from our website $\ensuremath{\mathsf{www.kawneer.co.uk}}$

AA®720 HI Reflex^{Plus}

Head & Cill Detail

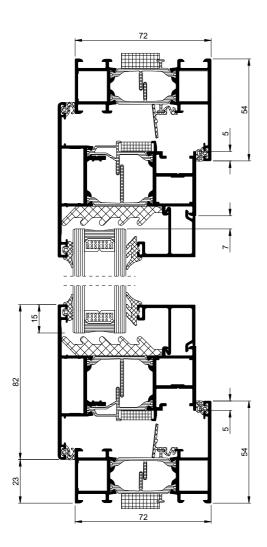

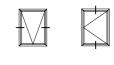


H24-13

AA®720 Standard Casement Window


Full details can be downloaded from our website www.kawneer.co.uk

AA®720 HI Reflex^{Plus}

Vent/Fixed Light Muntin Detail

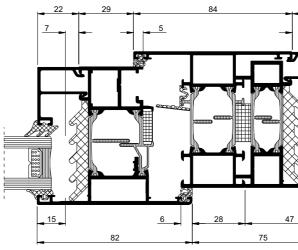


Vent/Fixed Light Z-Muntin Detail

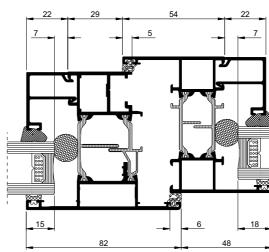





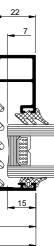



H24-18





H18-01

AA®190 TB Door

Introduction

Kawneer design, engineer and manufacture complete door systems for most applications. Kawneer's bespoke facility using state of the art manufacturing technology maintains high standards of processing ensuring equally high standards of performance throughout the lifetime of Kawneer products.

The AA®190 TB is an all-purpose door for use in high traffic areas and automatic entrances. Its robust construction means that it is suitable for use in heavy/severe applications. It can be installed with a finger guard pivot stile, which safeguards against injury to fingers accidentally caught between the hinge stile and frame.

Product Features and Benefits

- The AA®190 TB is the only door with welded construction, supported by a Kawneer Lifetime Guarantee offering peace of mind
- AA®190 TB Door independently tested to PAS 24 Standard -Enhanced security performance of single and double leaf external doors
- Finger Guard Pivot Stile, as standard, protects against trapped fingers when opening and closing, a child-friendly feature
- Butt hinge solution available
- An extremely robust door suitable for medium, heavy and severe duty applications
- External and internal applications offering flexibility of design
- Single, double action, auto swing and bi-parting doors, offering flexibility for a wide range of solutions
- A range of thresholds including low thresholds -Document M compliant
- Single or dual colour options

Construction

Kawneer door systems have been proved by stringent laboratory testing. Strong construction, quality materials, precision engineering, proven hardware and attention to detail are the dependable performance features found in all Kawneer door systems.

Welded Corner Construction

The welded corner joint is the strongest aluminium door construction available, each corner having four separate weld points. Rigorous testing has verified its durability and exceptional strength, making it suitable for use in severe duty applications as defined in BS 6375-2: 2009.

Security*

The AA®190 TB Door has been independently tested to PAS 24 for the enhanced security performance of single and double leaf external doors. The AA®190 TB Door meets light, medium, heavy and severe use specifications and is suitable for external and internal doors in all types of buildings from offices and schools to public use doors such as in shops and hospitals.

* Does not refer to standard hardware, security hardware required.

Secured by Design

Official Police Security Initiative

Independently Weather Performance Tested to BS 6375-1: 2015

	Air Infiltration	Watertightness	Wind Resistance
	BS EN 12207: 2000	BS EN 12208: 2000	BS EN 12210: 2000
AA®190 TB Door*	Class 2 (300 Pa)	Class 3A (100 Pa)	Class C2 (800 Pa)

* Open-In Double Door with Butt Hinges and Rebated Threshold

Data and Reports for other door configurations are available from the Technical Services Department at Runcorn.

AA®190 TB Commercial Entrance Door Product Details

Product Sizes and Options

Feature	Finger Guard Pivot	Butt Hinge	Auto Slide
Max Leaf Height	3000mm	3000mm	3000mm
Max Leaf Width	1320mm	1200mm	1500mm
Max Leaf Area	3.3m ²	3.0m ²	4.5m ²
Double Glazing	V	V	V
Triple Glazing	V	V	V
Single Action	V	V	
Dual Action	V		
Max Leaf Weight with Concealed Closer	120kg		
Max Leaf Weight with Floor Spring	200kg		
Max Leaf Weight with Surface Mounted Closer	120kg	120kg	
Concealed Panic	V	V	
Surface Mounted Panic	V	V	
BS 8300-2: 2018 Compliant Threshold	V	V	
Rebated Threshold		V	





The Royal Mint, Llantrisant Architect: Rio Architects Image © The Royal Mint





AA®190 TB Round Finger Guard with Threshold (internal view)


All options are available in the 'H' Section of the AA®190 TB Product Manual

U-values


U-values are based on a standard single door, open out on a CEN sized door

Single - Open Out - Low Threshold				
Centre Pane Ug	1.0 W/m²K	0.7 W/m²K		
Whole Door Uw	1.73 W/m²K	1.52 W/m²K		

(external view)

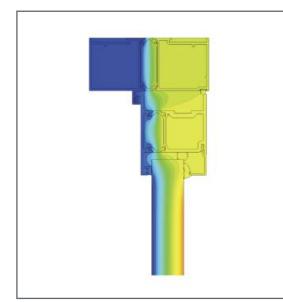

Butt Hung Open In Head Detail

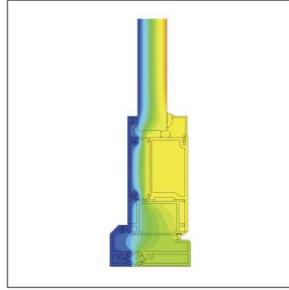


Butt Hung Open In Threshold

AA®190 TB Door

Typical Elevations

Full details can be downloaded from our website www.kawneer.co.uk

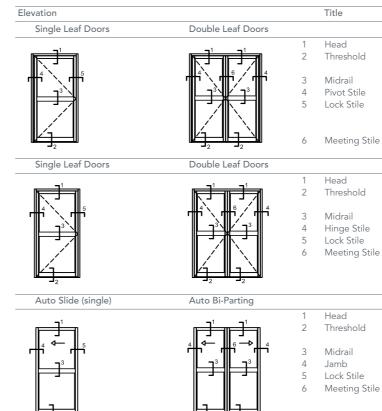


	Website CAD re	Website CAD ref. no.		
	Round Finger Guard	Flat Finger Guard		
	H1 02.01	H2 02.01		
ld	H1 03.01, H1 04.01	H2 03.01, H2 04.01		
	H1 05.01	H2 05.01		
	H1 07.01	H2 07.01		
e	H1 08.01, H1 13.01	H2 08.01, H2 11.01		
e	H1 09.01, H1 11.01	H2 09.01, H2 12.01		
	H1 12.01, H1 14.01			
	H1 15.01, H1 16.01			
Stile	H1 10.01	H2 10.01		
	Butt Hinge Open-in	Butt Hinge Open-out		
	H3 02.01, H3 11.01	H4 02.01, H4 11.01		
d	H3 03.01, H3 04.01	H4 03.01, H4 04.01		
	H3 05.01, H3 06.01	H4 05.01, H4.06.01		
	H3 07.01	H4 07.01		
ile	H3 08.01, H3 12.01	H4 08.01, H4 12.01		
e	H3 09.01, H3 13.01	H4 09.01, H4 13.01		
Stile	H3 10.01	H4 10.01		
	Auto Slide			
	H5 02.01			
d	H5 03.01, H5 04.01			
u	H5 05.01			
	H5 07.01			
	H5 08.01			
e	H5 09.01			
C				


H5 10.01


AA®190 TB Door Full details can be downloaded from our website www.kawneer.co.uk

Finger Guard Pivot Door

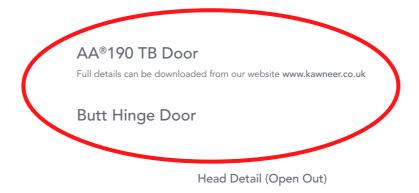




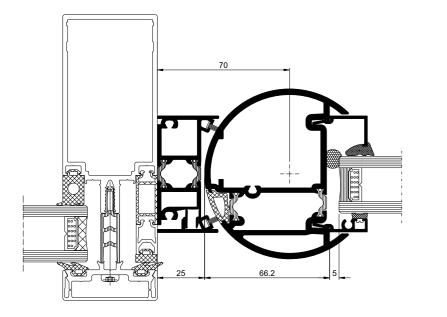


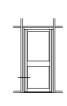

H1 13.01 Viewed Externally

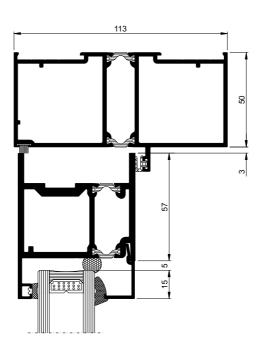



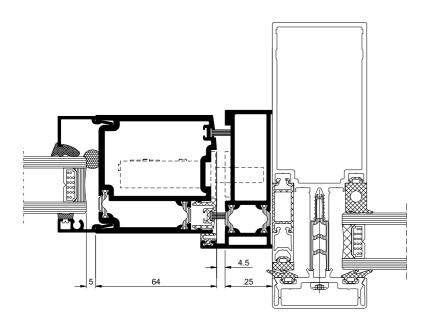




Viewed Externally



H4 02.01 Viewed Externally



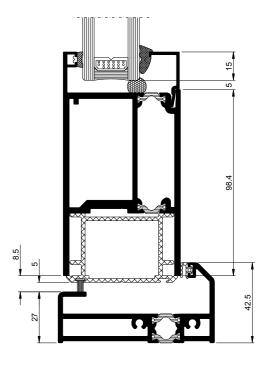

Rebated Threshold Detail (Open Out)




H4 05.01 Viewed Externally



Butt Hinge Door

Jamb Detail - Hinge Stile (Open Out)

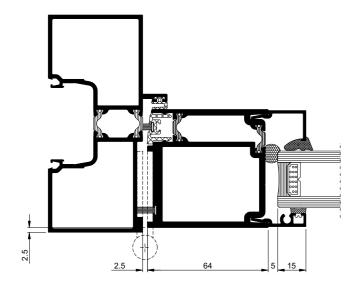




H4 08.01 Viewed Externally

AA®190 TB Door Full details can be downloaded from our website www.kawneer.co.uk


Auto Slider


Head Rail

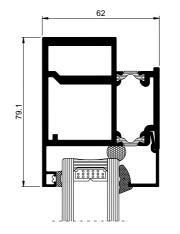


Threshold

Jamb Detail - Lock Stile (Open Out)

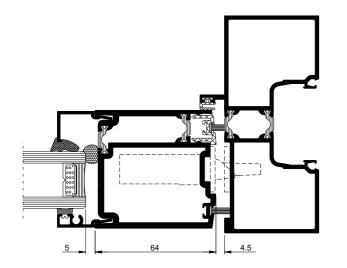

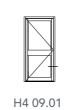

Viewed Externally

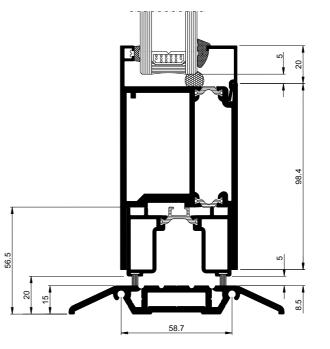





H5 02.01 Viewed Externally



H5 03.01 Viewed Externally





Appendix F. Window Colour Choice Information (Proposed)

The colour chosen is deemed to be the closest match to the existing windows.

RAL Classic	
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V

Yellow hues	>
Orange hues	>
Red hues	>
Violet hues	>
Blue hues	>
Green hues	>
Grey hues	>
Brown hues	>
White & black hues	>

RAL White and black hues

Home > RAL Classic > RAL White and black hues

The category **White and black hues** in the collection **RAL Classic** (which is part of the RAL color system) contains **14** colors. Press a color for more information.









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