

CCTV and Access Point Details Pack

CCTV Camera and Access Control Locations 1 2 3 4

Camera Type A Details 7

Camera Type B Details 8

Camera Type C Details

Drawings included:

Access Control Type A Details 10

Access Control Type B Details

04 Nov 2021

CCTV Camera and Access Control Location


CCTV Camera Type A


CCTV Camera Type B

CCTV Camera Type C

Access Control Type A

Access Control Type B

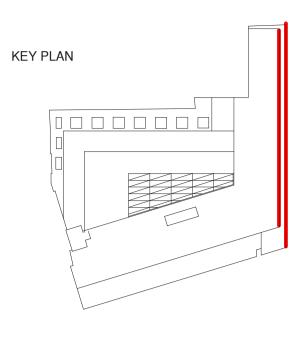

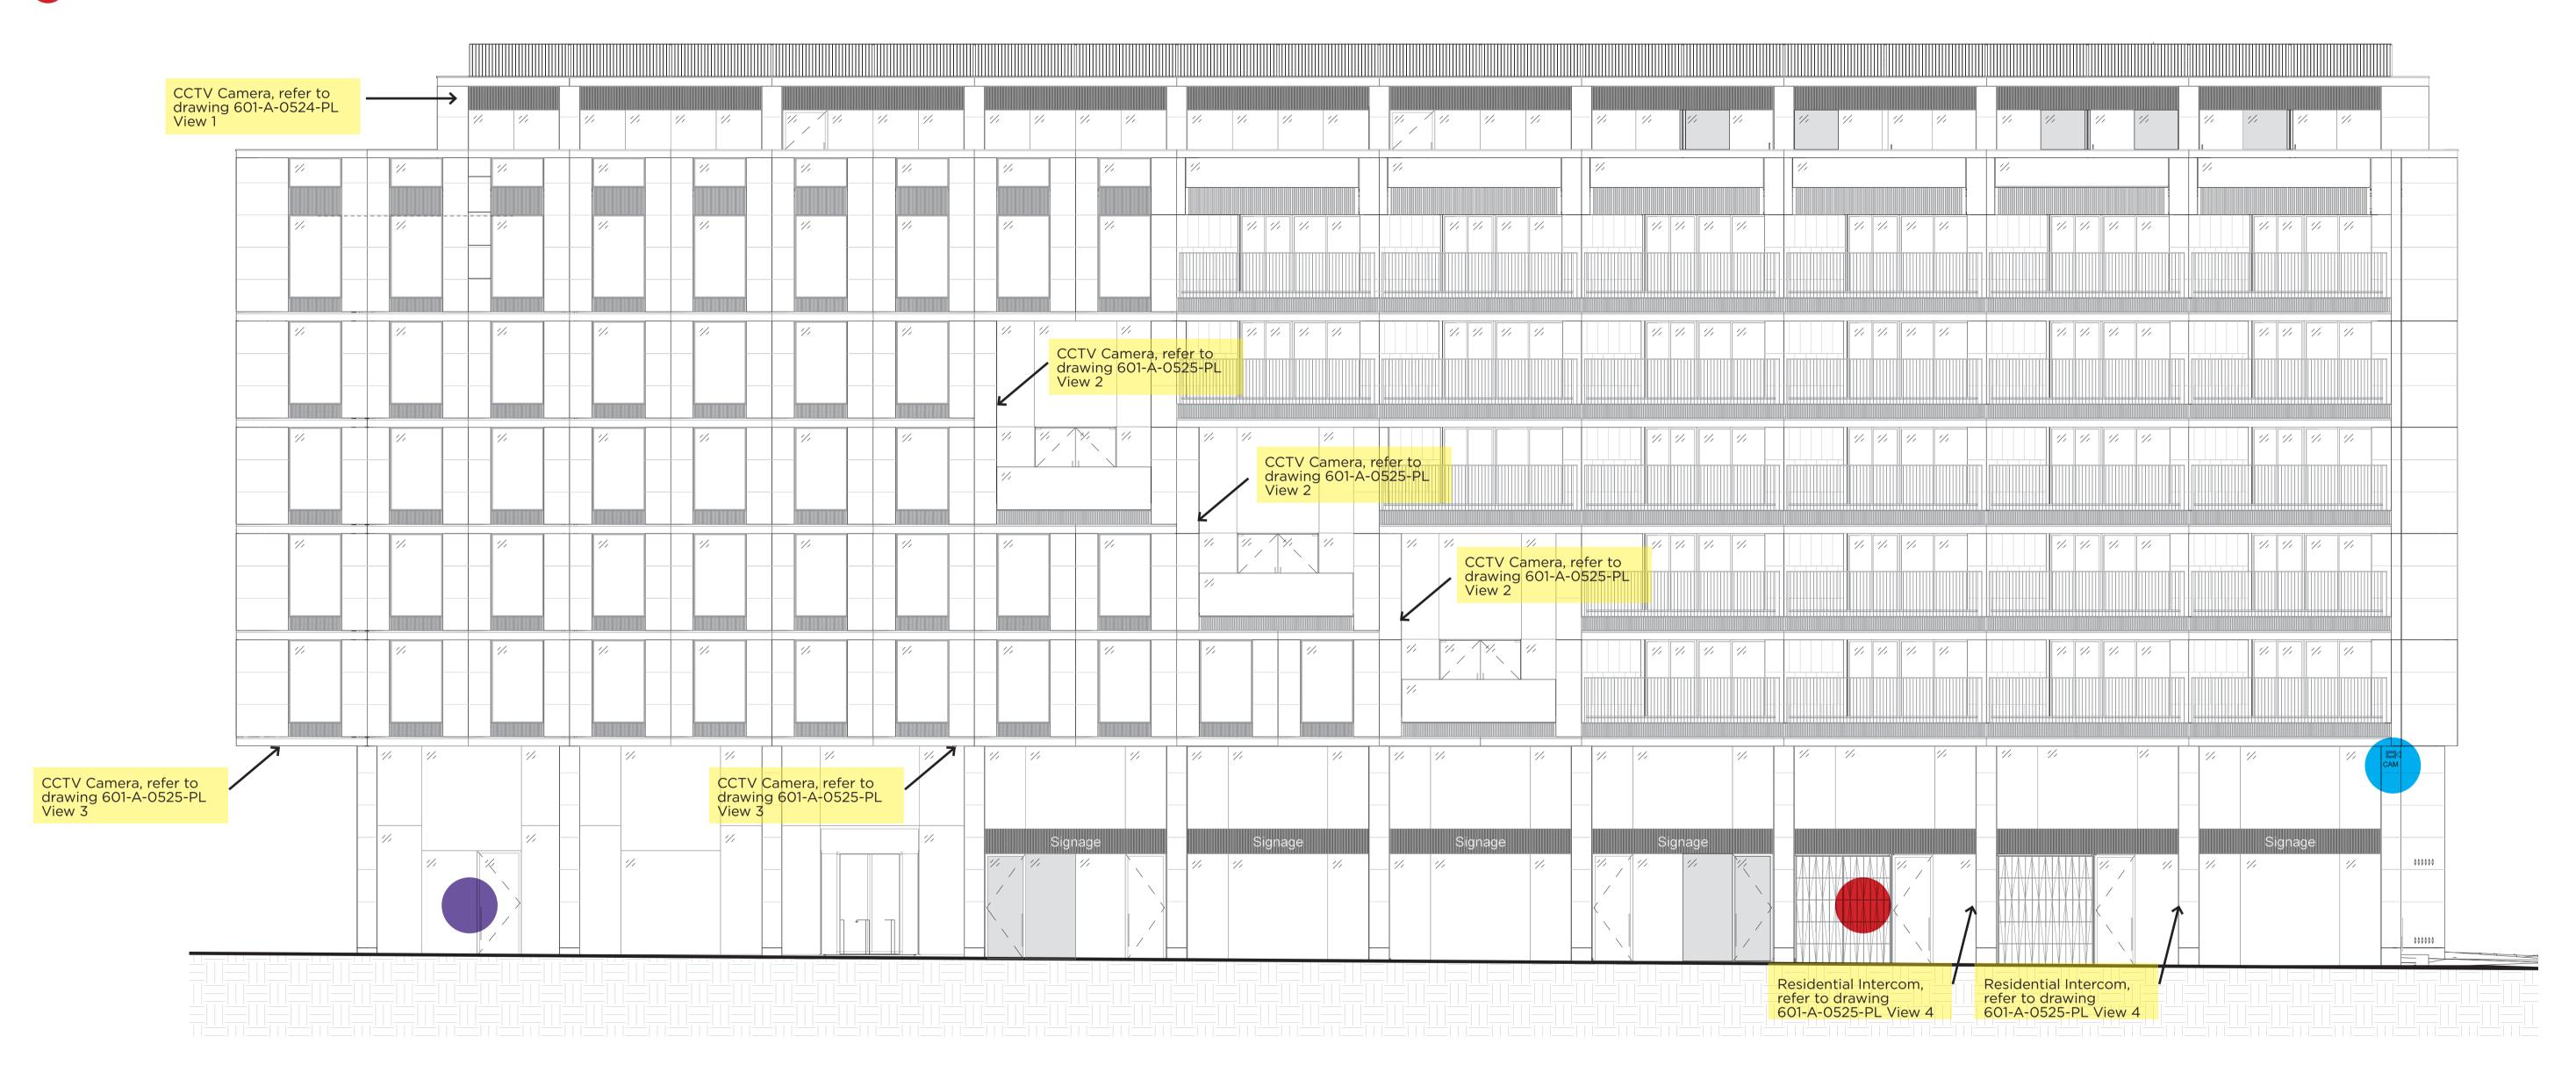

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Lazari Properties 8 Limited

Greater London House Hampstead Road London NW1 7QX United Kingdom Tel +44 20 7388 5444 Fax +44 20 7388 6557

Stephenson House, 75 Hampstead Road, London, NW1 2PL marks barfield architects

Proposed East Elevation CCTV and Access Control Locations 50 Bromells Road London SW4 0BG Job no

United Kingdom	601
Tel +44 20 7501 0180	Date 08/24/21

Scale (@ A1)	Drawing No	Revision	Status
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CCTV Camera and Access Control Location KEY PLAN CCTV Camera Type A CCTV Camera Type B CCTV Camera Type C Access Control Type A Access Control Type B CCTV Camera, refer to drawing 601-A-0524-PL View 2 CCTV Camera, refer to drawing 601-A-0525-PL View 1 CCTV Camera, refer to drawing 601-A-0524-PL View 2 CCTV Camera, refer to drawing 601-A-0525-PL Proposed South Elevation (Drummond Street) SCALE 1:100 Date by Description NOTES FOR ALL DRAWINGS: Stephenson House, 75 Hampstead Road, London, NW1 2PL This drawing is to be read in conjunction with the contract documents, including Lazari Properties 8 marks barfield but not limited to all other drawings, specifications and schedules. This drawing shows the design intent only. This is not a fabrication drawing. Do not scale from this drawing. All setting out dimenisons shown are to be checked and verified by the contractor on site. All dimensions and levels are subject to a site survey. Any discrepancies found in this drawing are to be reported to be the Architect immediately. Any modifications to these drawings necessary to meet Limited architects Proposed South Elevation CCTV and Access Control Locations 50 Bromells Road London SW4 0BG Greater London House Job no Scale (@ A1) Drawing No Status the performance criteria of the specification shall be agreed in writing with the Architect and issued for approval. Please refer to structrual engineer's drawings, Revision Hampstead Road 1:100 London NW1 7QX United Kingdom specificiations and schedules for all structural design, size and performance

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A-0521-PL

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11/04/21 Checker

United Kingdom


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For

Information



KEY PLAN

3 Elevation - North 1 (William Road)
SCALE 1:100

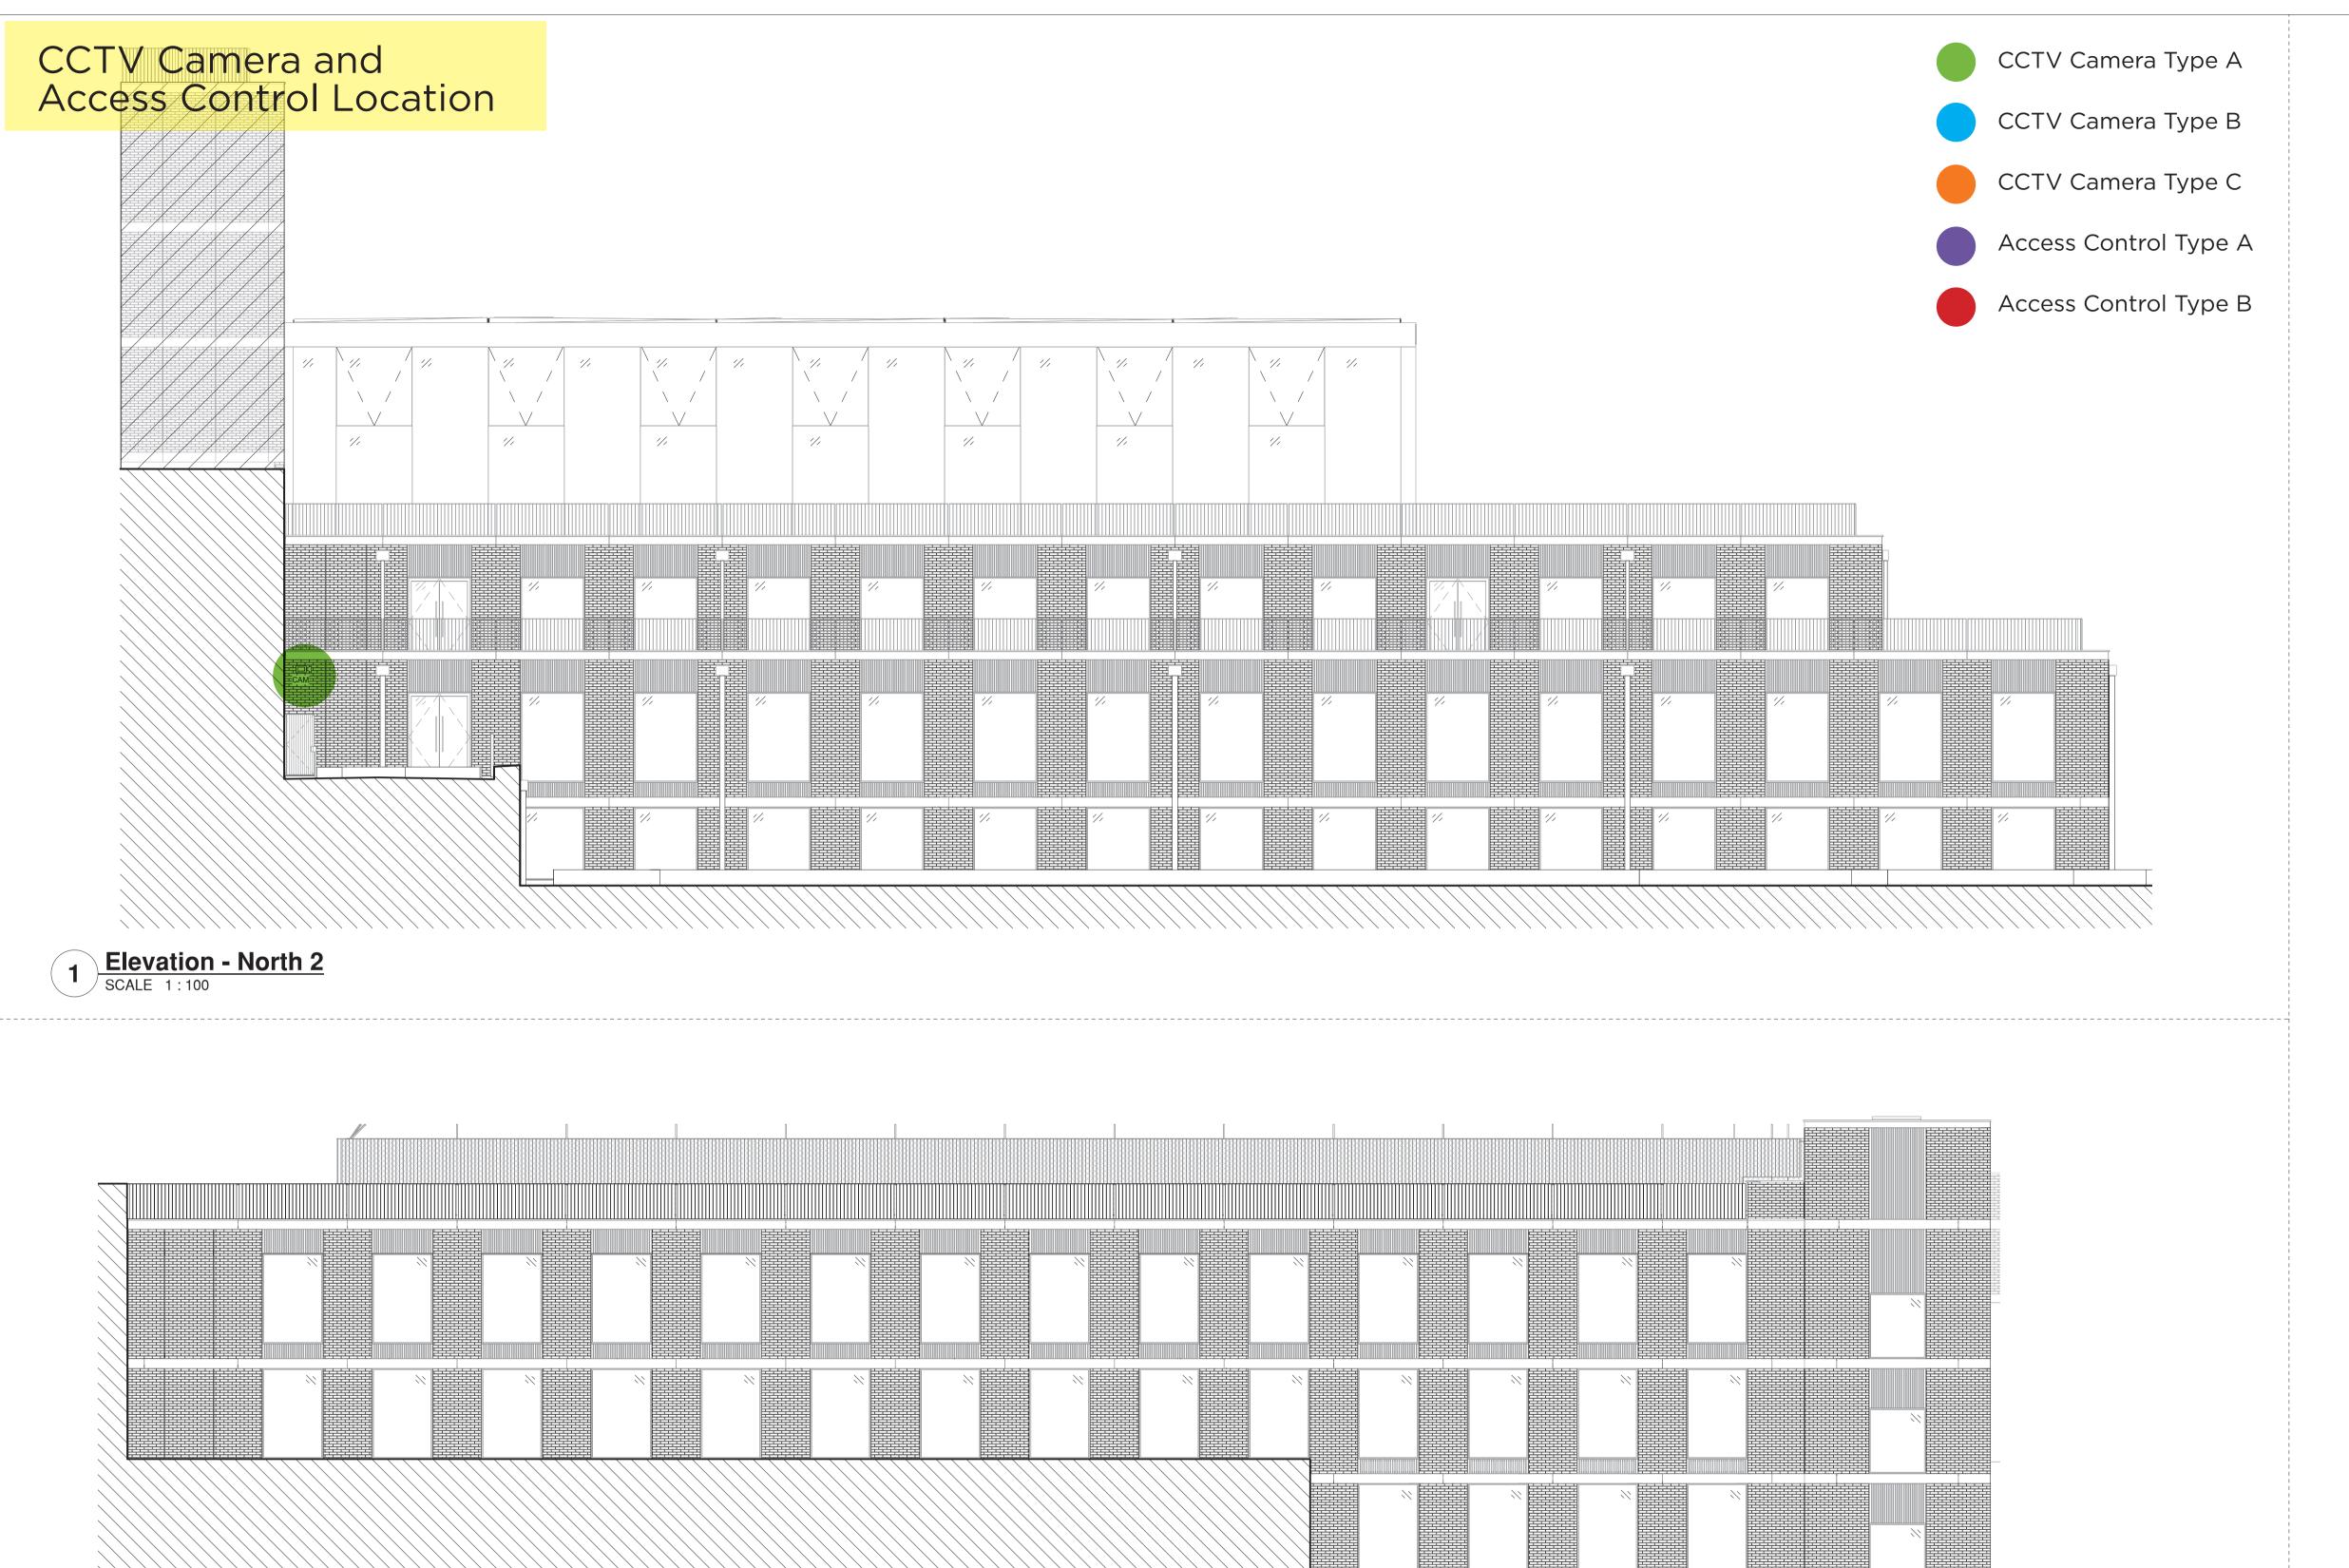2 Elevation - North 3a SCALE 1:100

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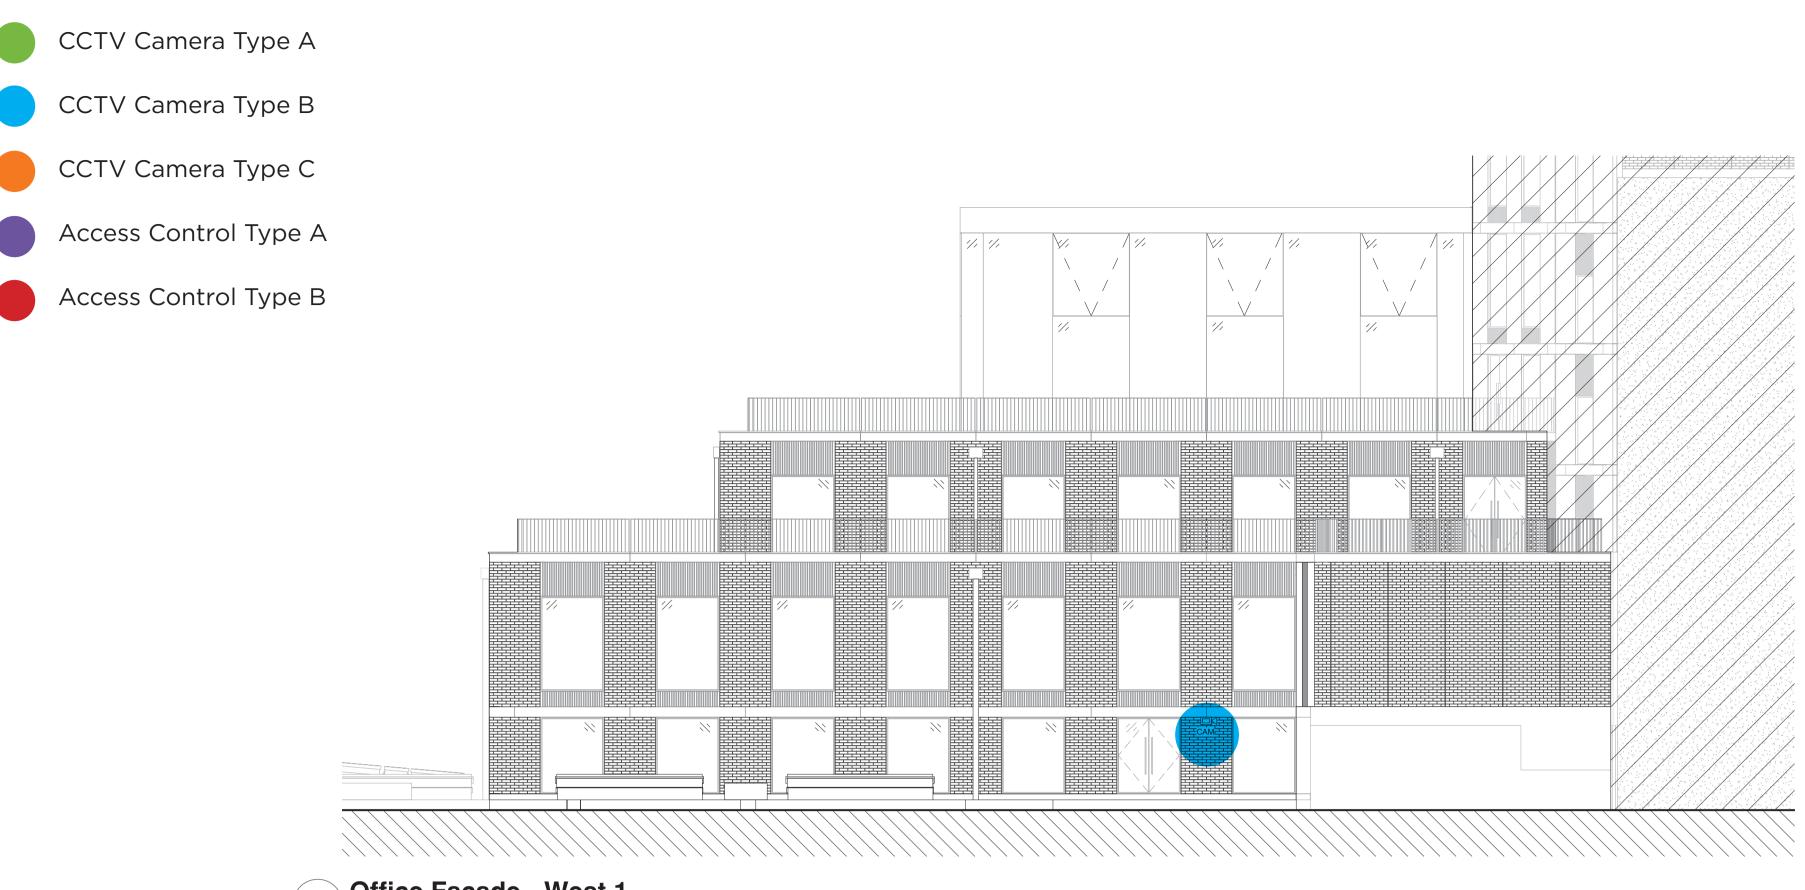
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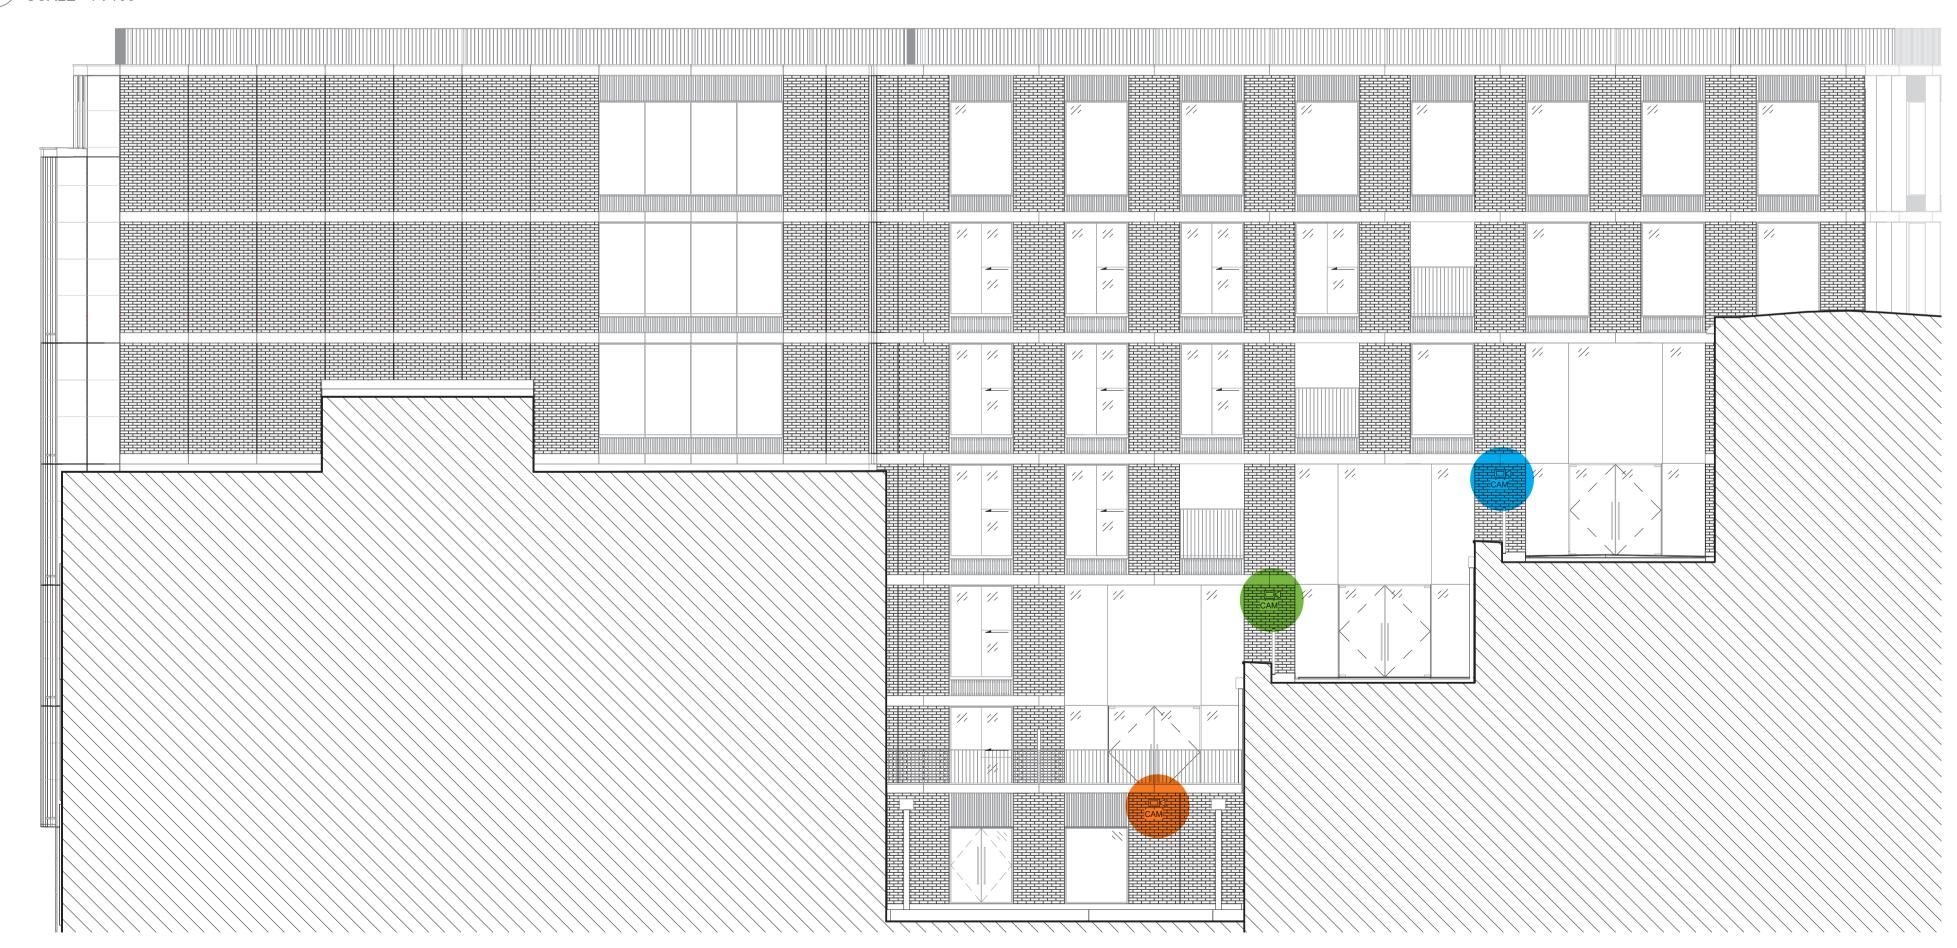
Stephenson House, 75 Hampstead Road, London, NW1 2PL Proposed North Elevation CCTV and Access Control Locations

Drawing No Scale (@ A1) 1:100 A-0522-PL Checked

Revision Status For Information 11/04/21 Checker



1 Office Facade - West 1
SCALE 1:100



2 Facade (Residential + Office) - West 2
SCALE 1:100

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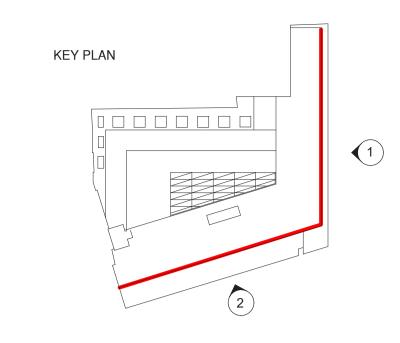
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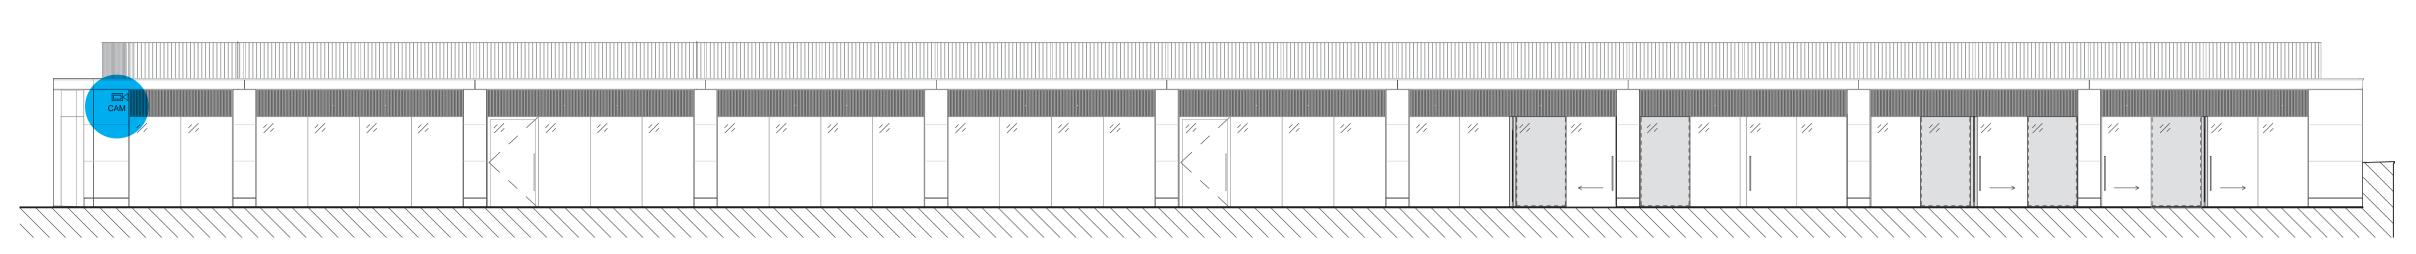
Stephenson House, 75 Hampstead Road, London, NW1 2PL Proposed West Elevation CCTV and Access Control Locations

KEY PLAN


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For





Top floor offices and residential - Hampstead RoadSCALE 1:100

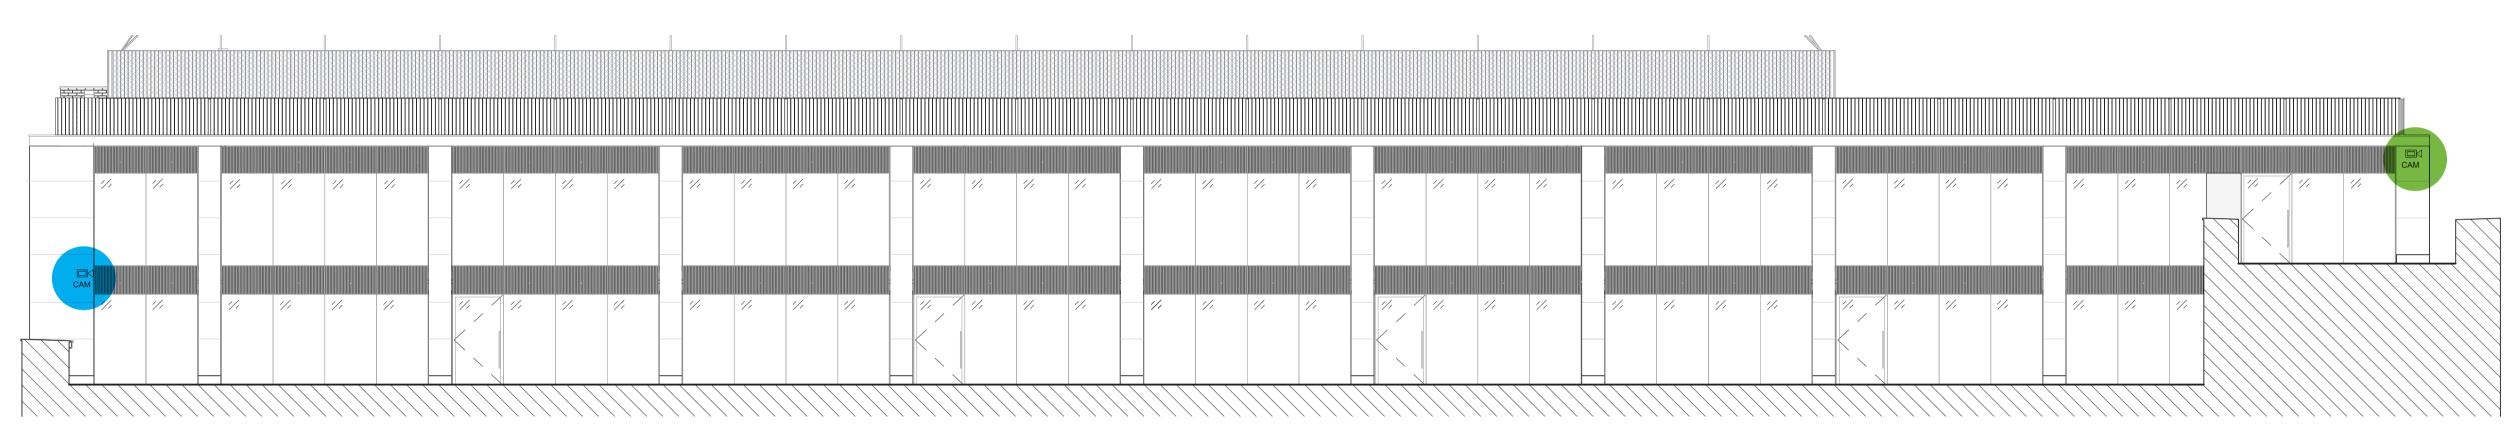

2 Top floor offices - Drummond Street
SCALE 1:100

CCTV Camera Type A

CCTV Camera Type B

CCTV Camera Type C

Access Control Type A

Access Control Type B

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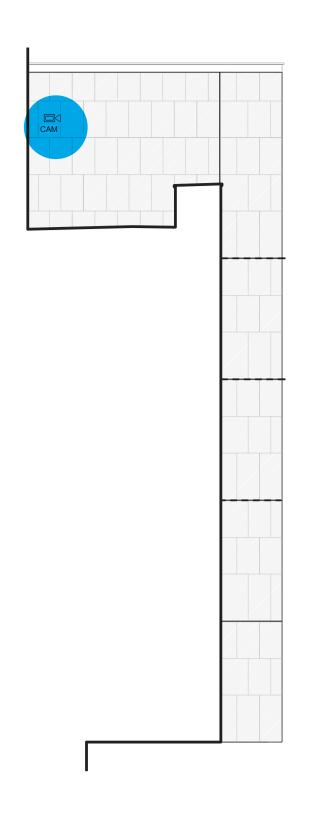
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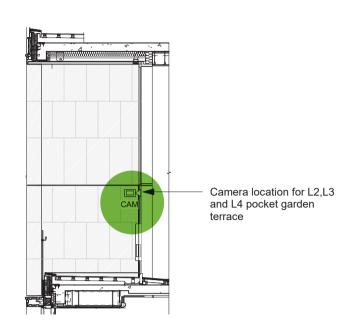
Stephenson House, 75 Hampstead Road, London, NW1 2PL Proposed East and South Setback Elevation CCTV and Access Control Locations_ Job no | Scale (@ A Scale (@ A1) Drawing No Revision Status 1:100 A-0524-PL For

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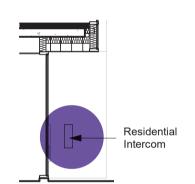
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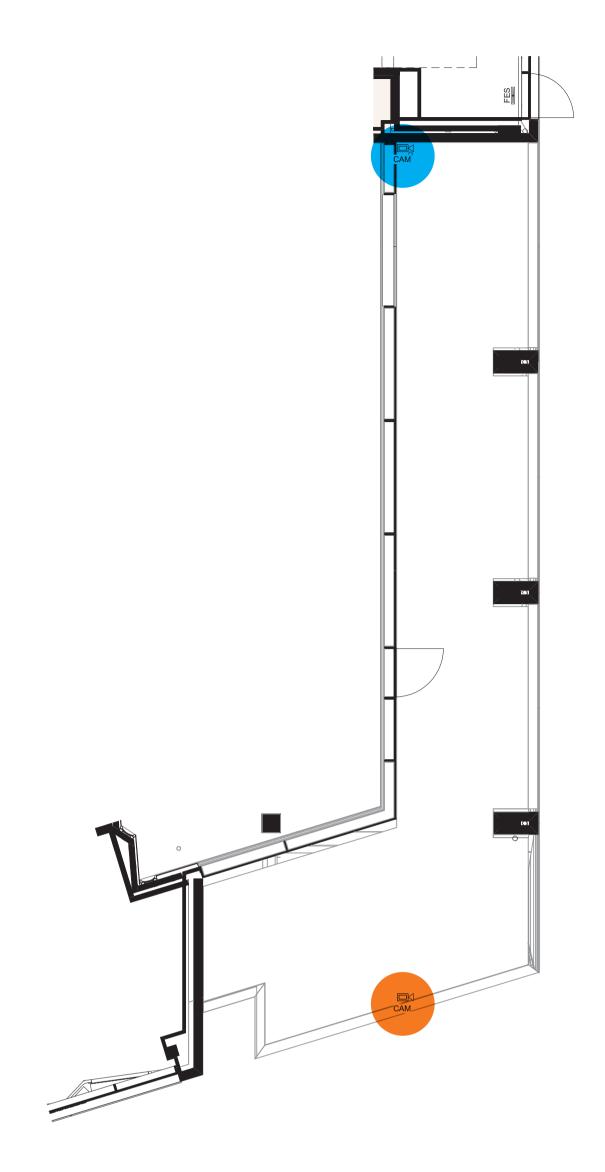
1 Lantern East Elevation
SCALE 1:100

2 Typical Pocket Garden Side Elevation
SCALE 1:100



4 Typical Residential Entrance Side Elevation SCALE 1:100

- CCTV Camera Type A
- CCTV Camera Type B
- CCTV Camera Type C
- Access Control Type A
- Access Control Type B



3 Entrance Reflected Ceiling Plan
SCALE 1:100

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601

Stephenson House, 75 Hampstead Road, London, NW1 2PL Drawing Title
Typical Side Elevation and Entrance Reflected Ceiling Plan 50 Bromells Road London SW4 0BG United Kingdom Job no Scale (@ A1) Drawing No Revision

A-0525-PL

1:100

Checked

11/04/21 Checker


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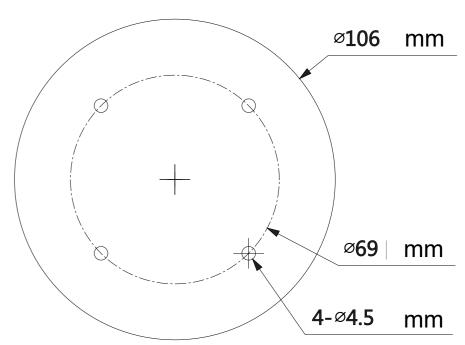
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Camera Type: A











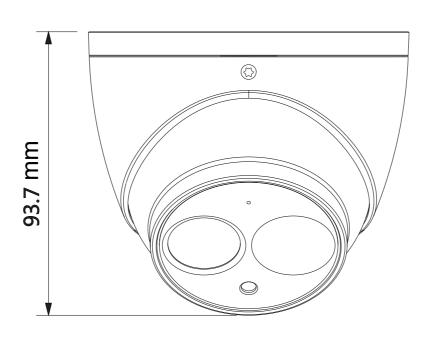


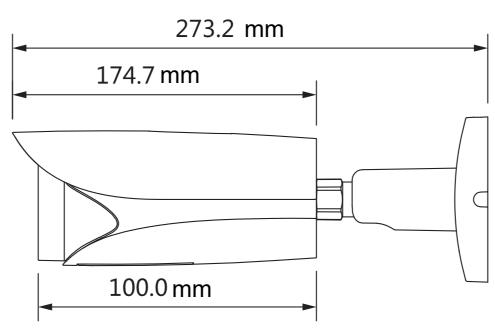


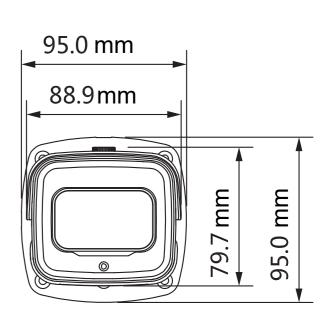

Camera Type: C



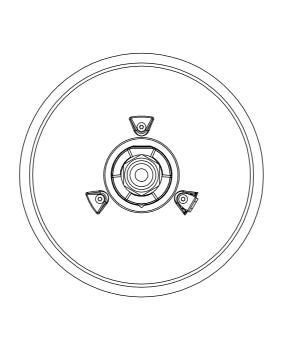

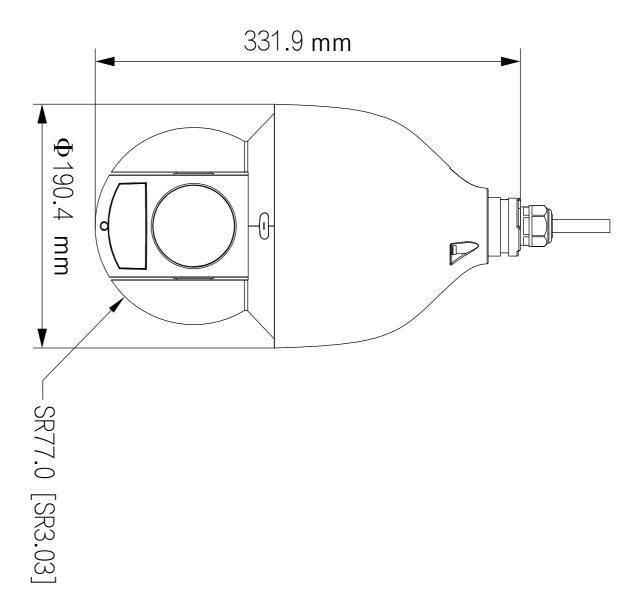

3 mm

↓ 0.14"

45 mm

1.8"



Access Control Type A

Paxton

Entry - VR Panel

System specifications

Maximum total tokens/users -

100 card packs (up to 5,000 tokens/users)

Power over Ethernet (PoE) Yes - IEEE 802.3af class 0

Ethernet bandwidth requirement 1Mb/s multicast per panel during call

100m/328ft

TCP/IP ethernet extension limit

Cable type

Token compatibility

Panels per system

Paxton, EM4100/02, MIFARE®, MIFARE® Classic, MIFARE® DESFire® EV1, MIFARE Plus®, MIFARE Ultralight®, MIFARE

Ultralight C*, MIFARE Mini*, HID* Prox (activiation required)

Features

Audio system Camera system Two way Full colour

Back-lit LCD

PIN/Code entry Yes - only in conjunction with Net2 software & Paxton10

Bluetooth® compatibility

Yes - only in conjunction with Paxton10

Bluetooth modes

'Token mode' - (Present credential to reader)

'Touch to enter' - (Smart credential or Hands free Keyfob in pocket) 'Longe range' - (Smart credential or Hands free Keyfob (Up to 10m))

'Bluetooth off'

Proximity entry Vandal resistant

IDC connector

Yes

Material

316L Stainless Steel Marine Grade

Environment

Operating temperature

-20°C - +50°C -4°F - +122°F

Moisture resistance Vandal Resistance

IK10

DS1060





The Entry panel is a robust door entry panel incorporating both door entry and access control functions. It is powered using power over Ethernet (PoE) and communicates with the other elements of the system using IPv6, providing 'plug and play' installation. Each panel is associated with a Entry control unit which is the interface to the door hardware.


The panel is equipped with a keypad and a proximity token reader. A resident can use either the keypad or a token to gain entry. Installers gain access to the menu options using an engineer code or an engineer token.

Net2 or Paxton10 software can be used to administer the access control functions.

Decide how the units are to be connected. You can either run your own wired network or (with the owner's permission) share the buildings existing data network. If using the owners network, the system uses IPv6 protocol and PoE (Power over Ethernet) so the network must support this switch type.

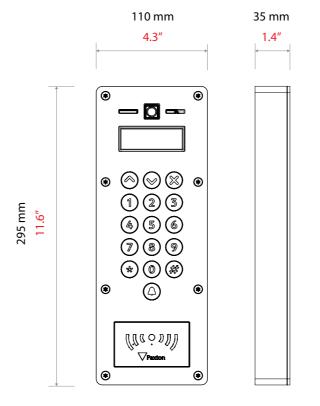

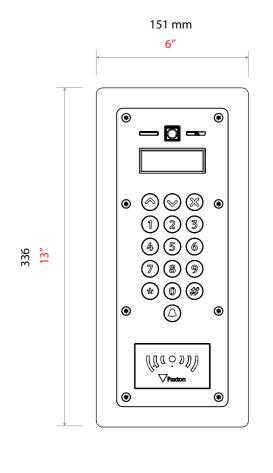

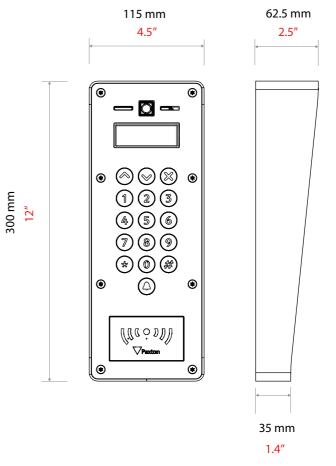



Access Control Type B

Paxton10 Slimline Reader

Paxton 10

Overview

Continuing Paxton's long-standing tradition, offering a wide variety of reader types to suit all applications, the Slimline Reader has been designed to blend seamlessly into any interior style whilst offering ultimate installation simplicity via its 5m/ 16ft encapsulated cable.

The Slimline Reader, in its low profile compact package still provides all the functions you would expect from a Paxton10 reader. It supports all leading token types, including HID Prox®, MIFARE®, Paxton and EM, as well as offering Bluetooth for communication with long range or handsfree credentials and mobile telephones via the Paxton app.

Features

- Multi-format reading technology offering compatibility with Paxton, MIFARE®, HID Prox®, EM and more
- Low power sleep mode with capacitive wake-up
- Built in Bluetooth Low Energy support to allow communication to mobile and wearable devices
- Simple 2-part construction with encapsulated 5m/16ft cable
- IP67 rated
- Simple 4 wire installation





Specifications





System

Token compatibility	Paxton, EM4100/02, Sony *, FeliCa Lite-S
	MIFARE® Classic, MIFARE® DESFire® EV1/EV2
	MIFARE® Plus, MIFARE Ultralight®
	MIFARE Ultralight C®, MIFARE Mini®, NFC®,
	Hitag2, HID® Prox 125kHz low frequency



Electrical

Power consumption	1W (Max)
Operating voltage	12V
Current Draw	40mA (Quiescent)
	100mA (Max)



Communication

RFID frequency	125kHz & 13.56MHz
Data connection	RS485/Paxton10 protocol
Bluetooth®	2.4 GHz



Hardware

Dimensions (W x H x D)	49mm x 104mm x 17.2mm
Cable Type	22AWG, 4 core twisted pair
Cable Length	5m
Maximum cable extension length (Controller > Reader)	100m
Sound	Piezo Buzzer
Colour	Black
Housing material	PC+ABS
Warranty	Paxton 5 year



Environment

Operating temperature	-35°C - +66°C
IP Rating	IP67
IK Rating	IK10
Mounting	Surface only