


inside the shop in the Kitchen



Silencers and the Fan to be installed inside the shop

Project:	Title:	Scale: 1:50 @ A3
324 West End Lane London NW6 1LN	Proposed Ground Floor Plan	Date: 07 . 2021
		Drawing No.: 128 -02/MT
		Revision

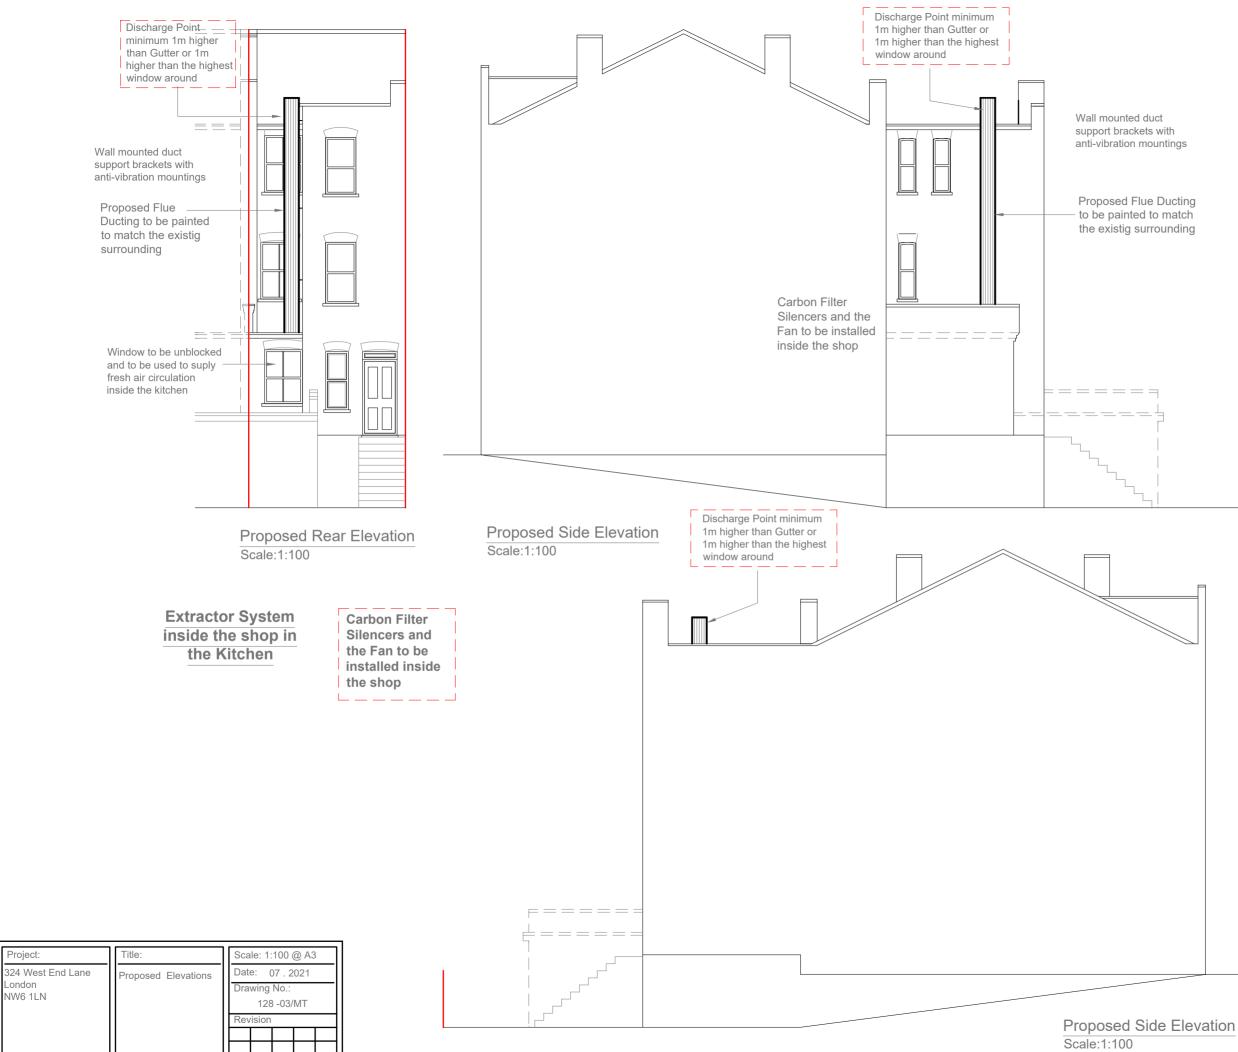

Project:

London

NW6 1LN

All work to comply with current building regulations and codes of practice

All dimensions to be checked on site before the start of any work

Carbon Filter, Silencers and the Fan to be installed inside the shop

Wall mounted duct support brackets with anti-vibration mountings


External Flue Riser - Galvanized steel ducting cross braced to mitigate noise ducting to be at least 1.0m above eaves.

The external part of the ducting running from the building exit point to the flue terminal will be wrapped in 25mm thick mineral wool with minimum density of 35kg/m2 to be held in place with light metal mesh, and metal or plastic strapping bands.

The mineral wool insulation would be lagged with a membrane of flexible sound barrier matting with a density of 5kg/m2 and nominal thickness of 2mm (in black) to be applied around the duct with overlapped/sealed joints to be held in place in accordance with suppliers recommendations.

One layer of Sound Proofing Mat (SBM5) has an insulation value of 24dB

The noise level at the point of nearest window would be mitigated to at least 32dB @ 1.0 meter.

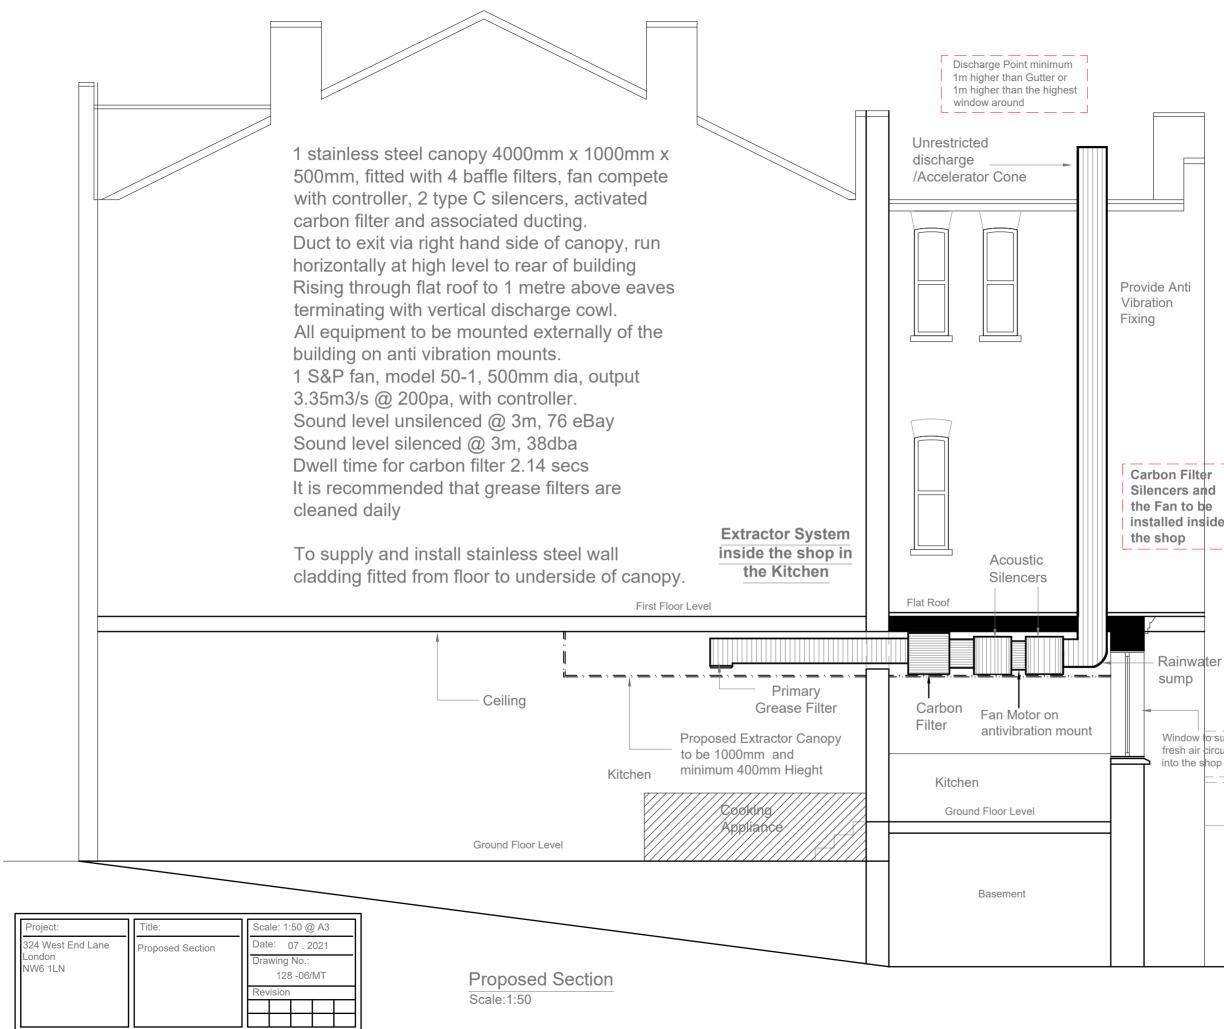

and codes of practice All dimensions to be checked on site before the start of anv work Proposed External Finish Materials to Match Existing External Finish Materials Note: Kitchen Extractor System will included; A Three stage Filtration System, including Grease Filters, Pre-Carbon Filters and Carbon Filters (located inside the side), Ducting to be Circular, Ventilation Duct to Terminate pointing directly upwards and shall *not* be fitted with a Cowl, Fan to be Isolated from the Inlet and Discharge Ducts using Flexible Couplings, Fan to be Mounted using Anti-Vibration Mounts and Duct to be Isolated from the Structure of the Building using Anti-Vibration Mouldings and suitable packing material where is passes through solid Structures. installed inside Extractor Unit Specification: 560/4-1 ELTA SCPP 1 Phase Motor Rating 1.5kW 9.8 FLC Amps 30 SC Amps TC 110 Controller Rainwater Noise Level 66dBA @3MTR Noise Level 55dBA @3MTR (Silencers with POD) Window to suply fresh air circulation

All work to comply with current building regulations