



Scale 1:10 @ A1

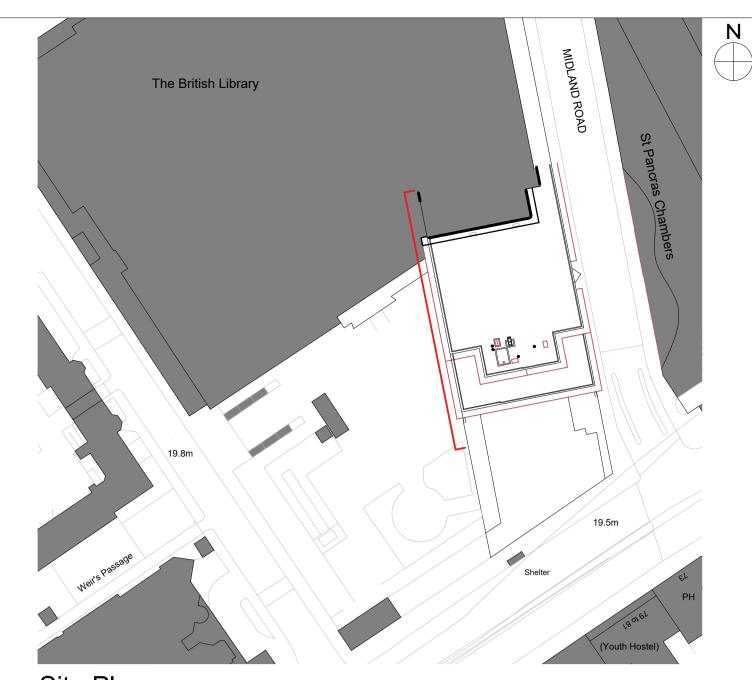

Site Plan Scale 1:1000 @ A1

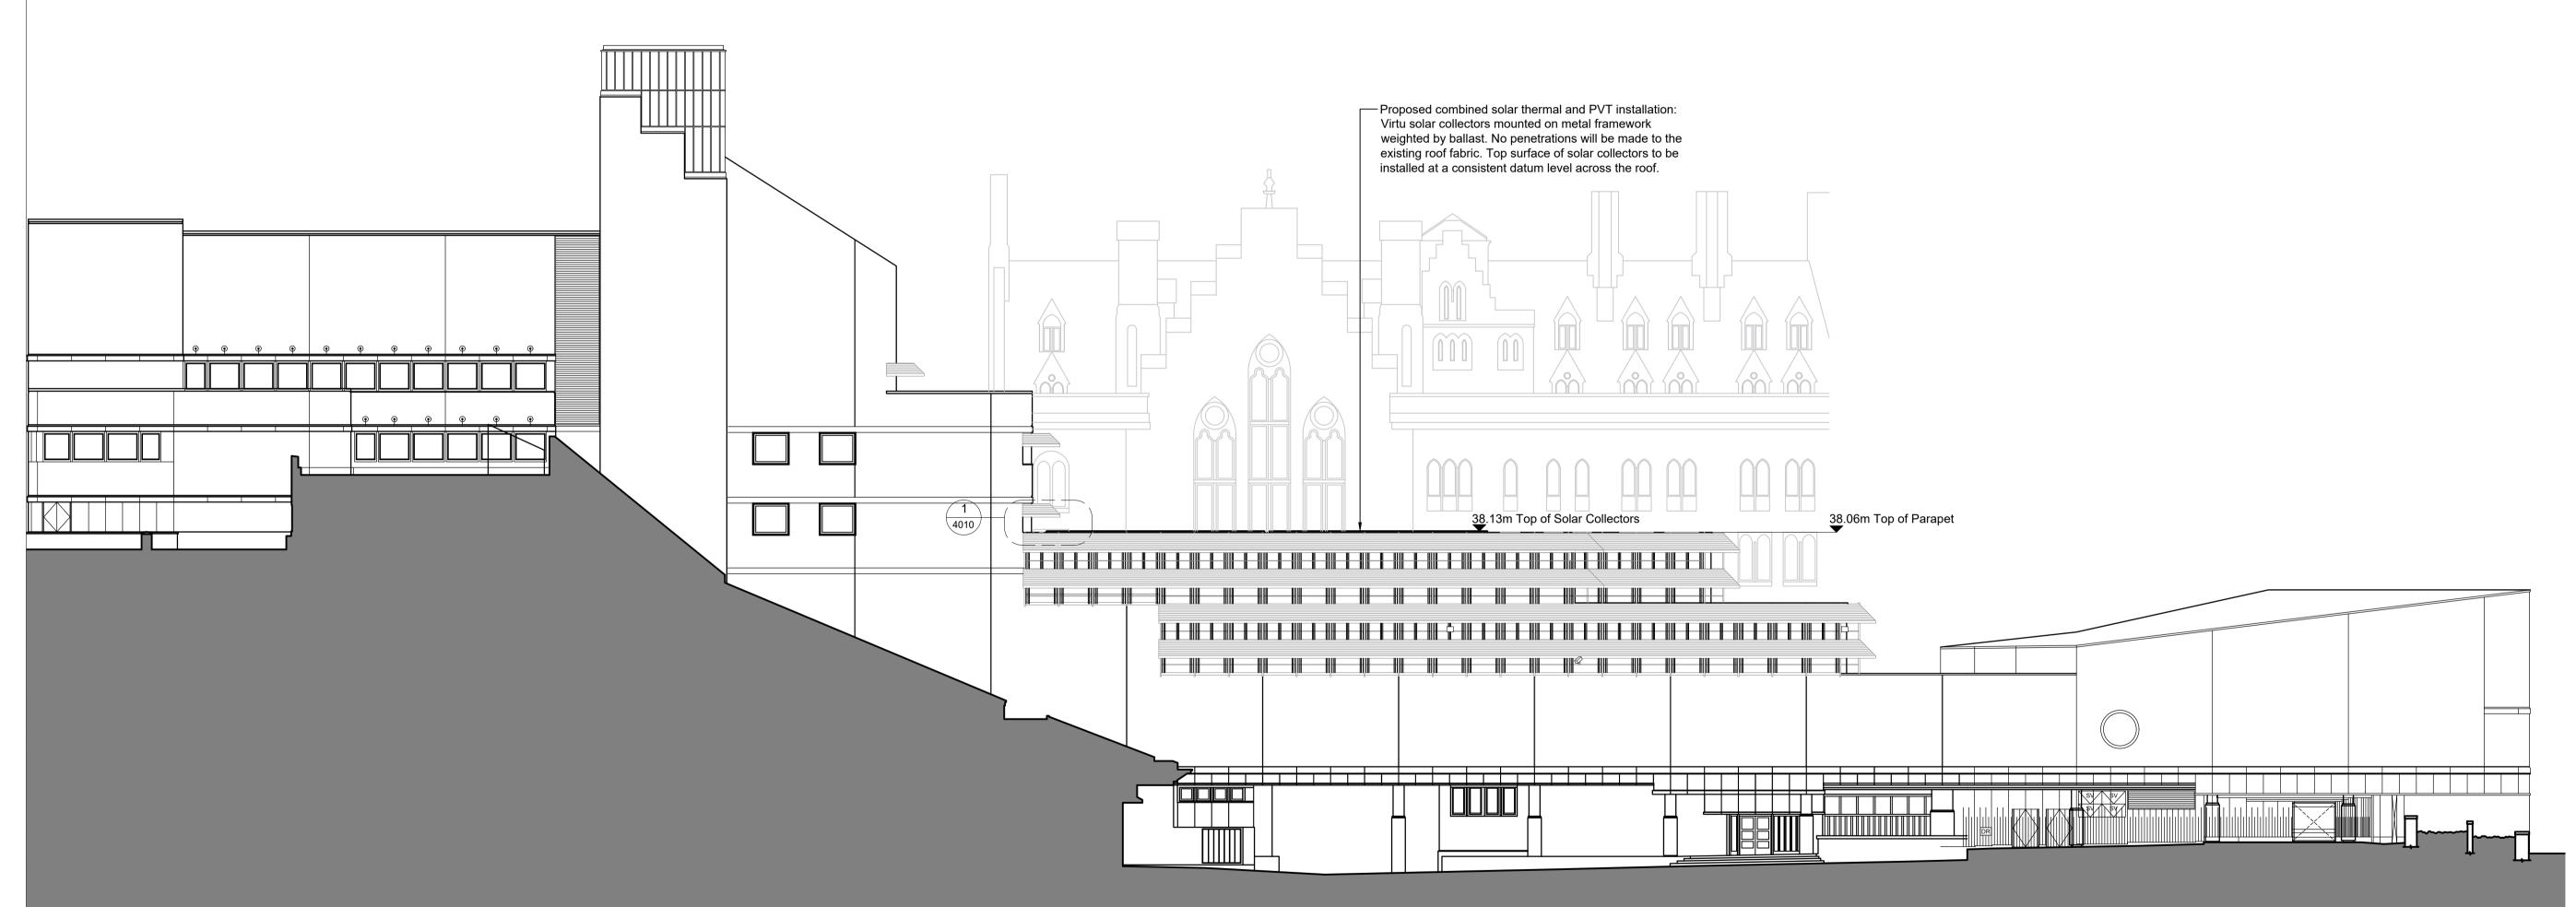

[m] Do not scale from this drawing

Elevation 1 (West Elevation from Plaza)

Scale 1:200 @ A1

0 2 4 6 8 10

AC CP CP By Ck Ap Rev Date Description

1. This is an A1 drawing, if reproduced in any other format the scale shown will be

3. Any ambiguities, omissions and errors, or inconsistencies with other documents, on this drawing should be notified immediately to the architect before the

5. All dimensions, unless otherwise stated, are to the face of unfinished masonry walls or to the face of stud partitions, excluding

6. All dimensions are to be checked on site. any discrepancies are to be notified immediately to the architect before the

8. This drawing is to be read in conjunction with all other relevant drawings and specifications for this project and apparent inconsistencies brought to the attention of

9. It is the responsibility of specialist

manufacturer to ensure full compliance with their composite build up as specified by them, and that the integration of their product into the building design meets the required fire tests and complies with

roofing/wall cladding/insulation

commencement of works on site. 7. All levels are in meters unless otherwise

commencement of works on site. 4. All dimensions are in millimeters unless

incorrect.

2. Do not scale off this drawing.

otherwise stated.

plasterboard.

the architect.

Building Regulations.



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Combined Solar Thermal and PVT Installation

Proposed Elevation 1

Drawn by	CP Checked by	Approved by	Scale 1:20	00	28.07	.21	RIBAS
Project	Originat	or Volume	Level	Туре	Role Number	Suitab	ility Rev
2102	7 -CBI	>-XX -	XX	-DR	-A-4010	-S	I -P

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