



Site Plan
Scale 1:1000 @ A1

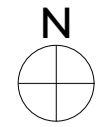

- Notes:
1. This is an AI drawing, if reproduced in any other format the scale shown will be incorrect.
 2. Do not scale off this drawing.
 3. Any ambiguities, omissions and errors, or inconsistencies with other documents, on this drawing should be notified immediately to the architect before the commencement of works on site.
 4. All dimensions are in millimeters unless otherwise stated.
 5. All dimensions, unless otherwise stated, are to the face of unfinished masonry walls or to the face of stud partitions, excluding plasterboard.
 6. All dimensions are to be checked on site. any discrepancies are to be notified immediately to the architect before the commencement of works on site.
 7. All levels are in meters unless otherwise stated.
 8. This drawing is to be read in conjunction with all other relevant drawings and specifications for this project and apparent inconsistencies brought to the attention of the architect.
 9. It is the responsibility of specialist roofing/wall cladding/insulation manufacturer to ensure full compliance with their composite build up as specified by them, and that the integration of their product into the building design meets the required fire tests and complies with Building Regulations.

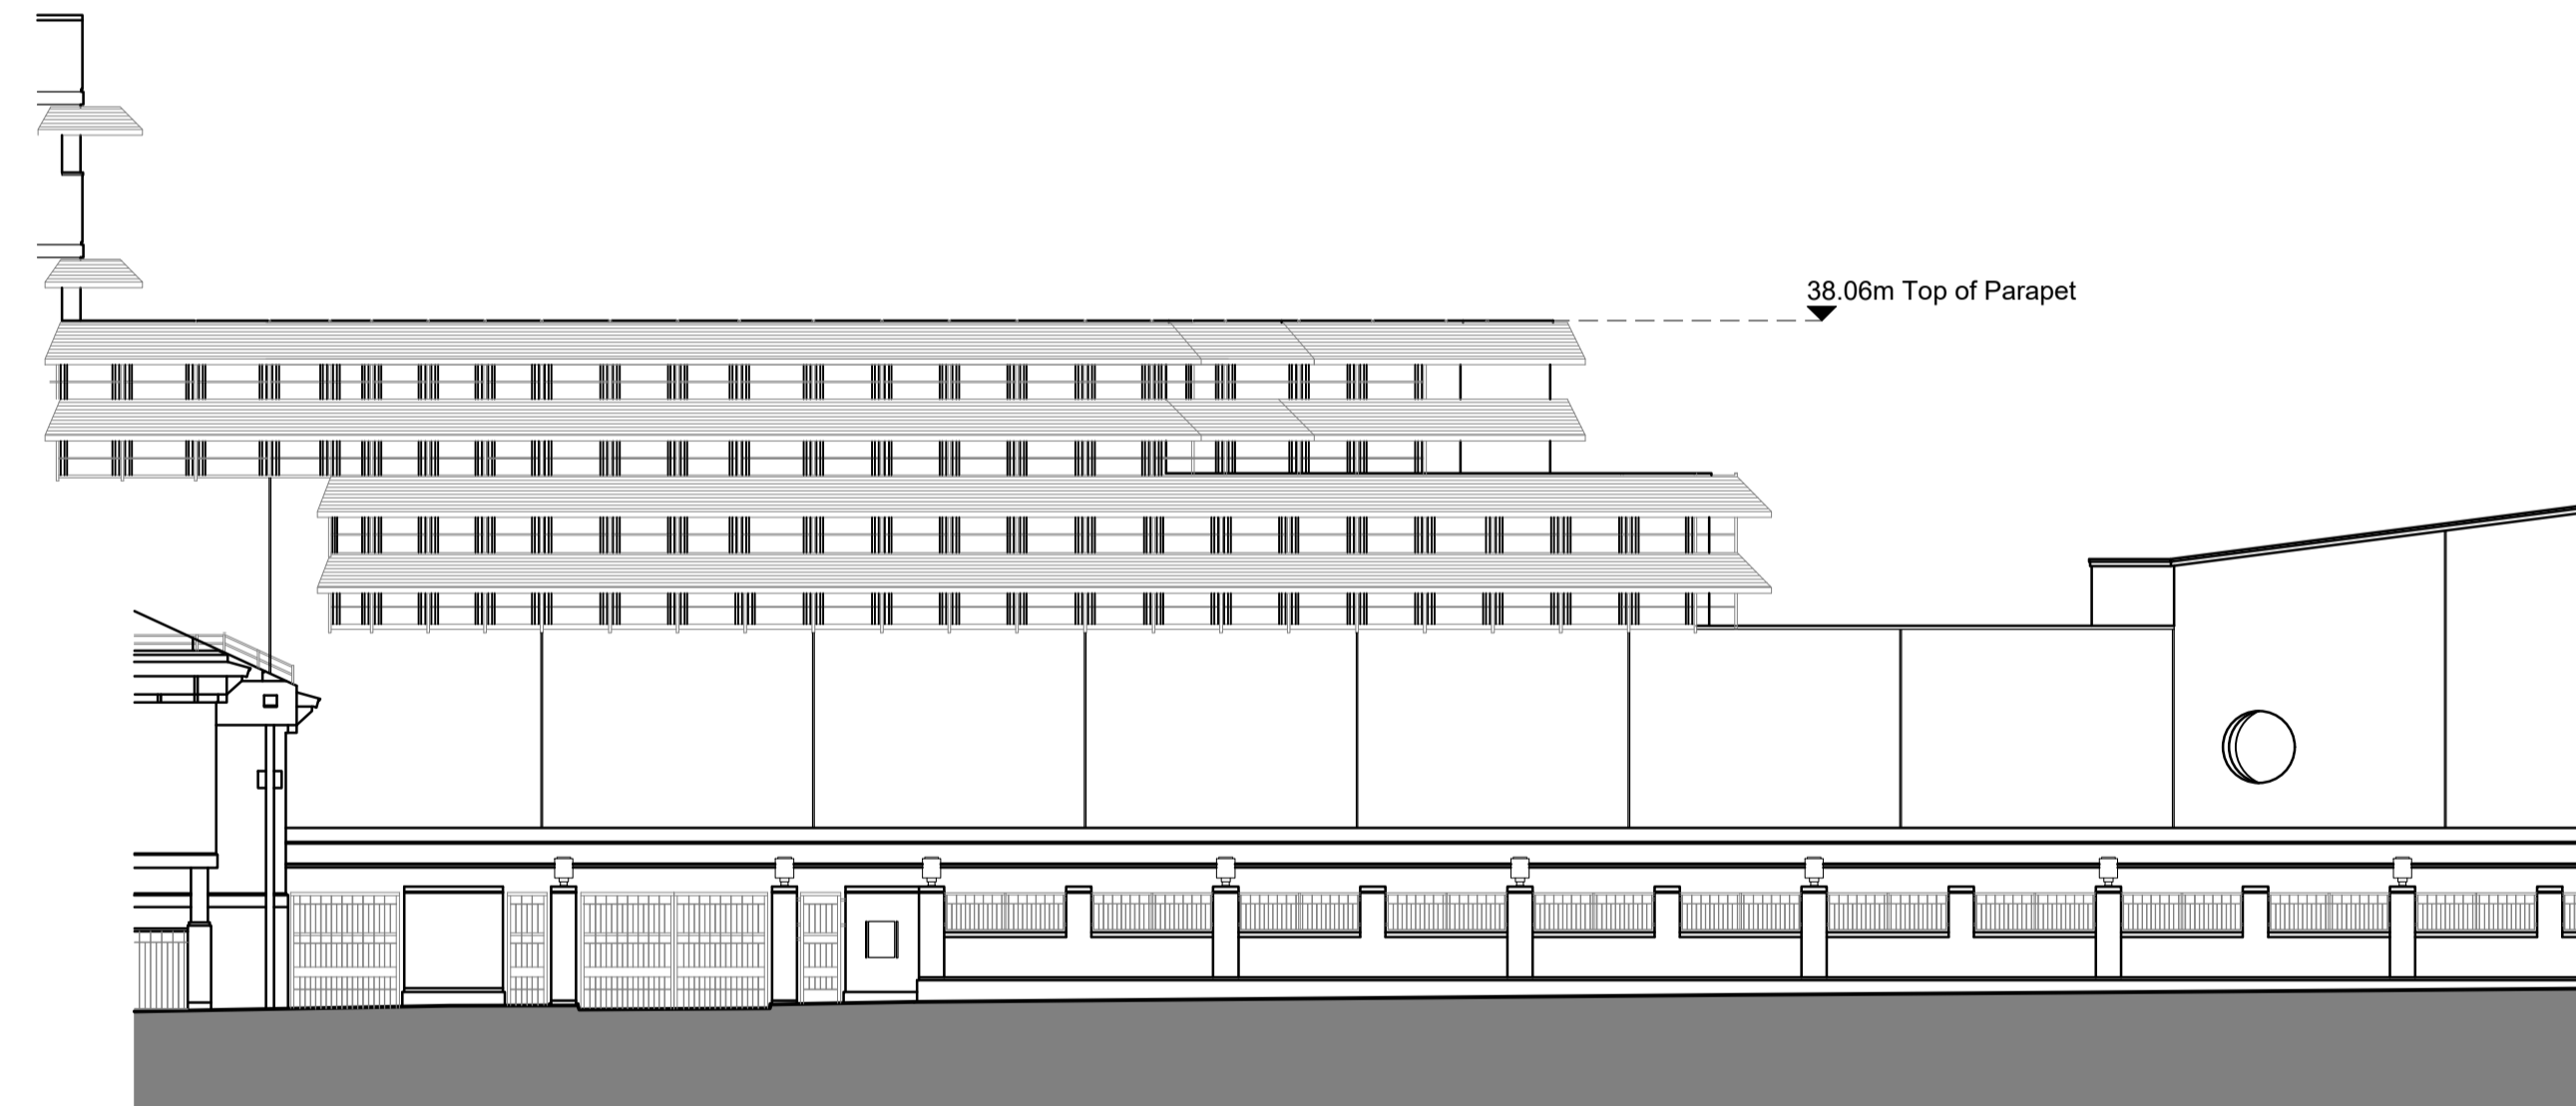

Elevation 3 (West Elevation from Ossulston Street)
Scale 1:200 @ A1

P02	21.06.21	Linetypes adjusted.	AC	CP	CP
P01	11.06.21	First issue.	AC	CP	CP
Rev	Date	Description	By	Ck	Ap



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Project
**The British Library
Combined Solar Thermal and PVT
Installation**

Drawing title
Existing Elevation 3

Drawn by	Checked by	Approved by	Scale	Date	RIBA Stage
AC	CP	CP	1:200	11.06.21	3

Project	Originator	Volume	Level	Type	File Number	Suitability	Revision
21027	-CBP-XX	-XX	-DR	-A-4002	-S1	-P02	

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