


Site Plan Scale 1:1000 @ A1

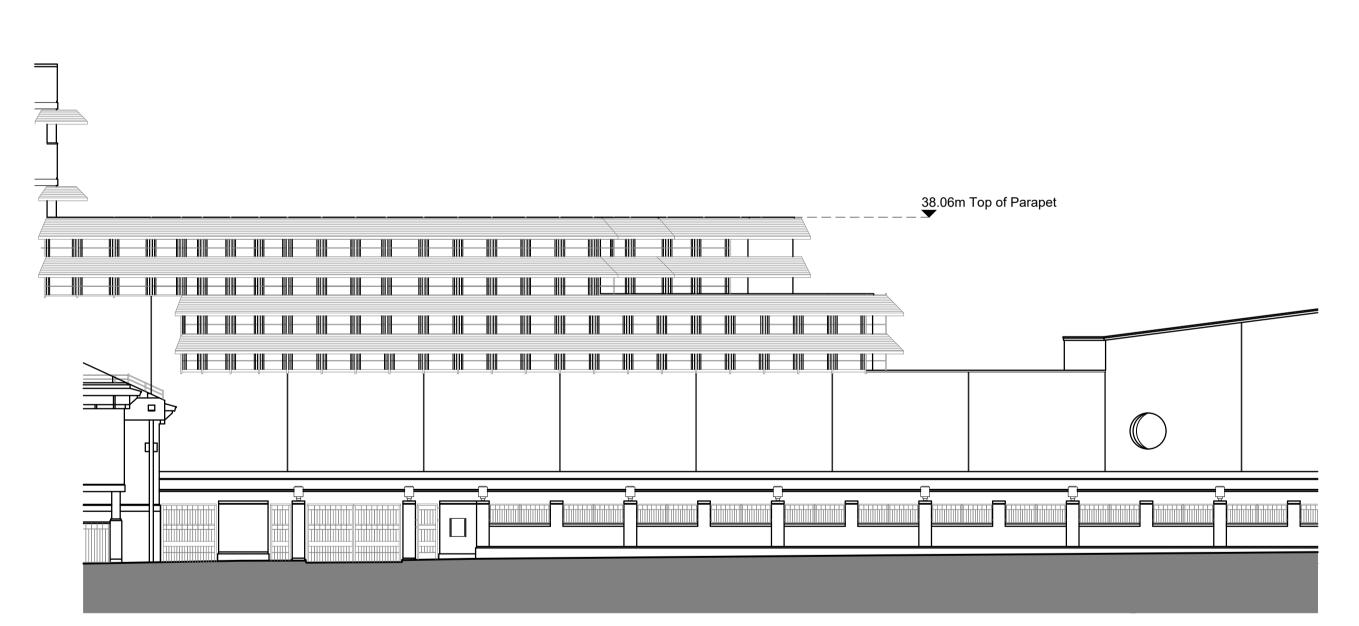

Elevation 3 (West Elevation from Ossulston Street)

Scale 1:200 @ A1

Ref: DRW022 Ver: 2 ISD: 20.06.01

0 2 4 6 8 10

- 1. This is an A1 drawing, if reproduced in any other format the scale shown will be incorrect.

otherwise stated.

2. Do not scale off this drawing. 3. Any ambiguities, omissions and errors, or inconsistencies with other documents, on this drawing should be notified

immediately to the architect before the

- commencement of works on site. 4. All dimensions are in millimeters unless
- 5. All dimensions, unless otherwise stated, are to the face of unfinished masonry walls or to the face of stud partitions, excluding plasterboard.
- 6. All dimensions are to be checked on site. any discrepancies are to be notified immediately to the architect before the commencement of works on site.
- 7. All levels are in meters unless otherwise
- 8. This drawing is to be read in conjunction with all other relevant drawings and specifications for this project and apparent inconsistencies brought to the attention of the architect.
- 9. It is the responsibility of specialist roofing/wall cladding/insulation

manufacturer to ensure full compliance with their composite build up as specified by them, and that the integration of their product into the building design meets the required fire tests and complies with Building Regulations.

	21.06.21 11.06.21	Linetypes adjusted. First issue.		CP CP	•
Rev	Date	Description	Ву	Ck	Ар



## T: 0115 948 1144

www.cbp-arch.co.uk

44 The Ropewalk, Nottingham, NG1 5DW

The British Library

Combined Solar Thermal and PVT Installation

Drawing title

Existing Elevation 3

Drawn by Checked by Approved by Scale
AC CP CP 1:200 Date RIBA Sta 11.06.21 3 Originator Volume Level Type Role Number Suitability Revision 21027 -CBP-XX -XX -DR-A-4002-S1 -P02

Reproduced subject to copyright Original sheet size Al

[m] Do not scale from this drawing