



Daylight & Sunlight Report

89 Fellows Road, Camden, NW3 3JS

26th November 2020

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DAYLIGHT & SUNLIGHT REPORT

Client: Boyer Planning Limited

Project: 89 Fellows Road, Camden, NW3 3JS

Report date: 26th November 2020

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About *MES Building Solutions*

MES Building Solutions (MES) is an established consultancy practice specialising in providing building solutions throughout the UK.

We offer a full range of services for both residential and commercial buildings from small individual properties through to highly complex mixed use developments.

We are an industry leader in delivering a professional, accredited and certified service to a wide range of clients including architects, developers, builders, housing associations, the public sector and private householders.

Employing highly qualified staff, our team comes from a variety of backgrounds within the construction industry with combined knowledge of building design, engineering, assessment, construction, development, research and surveying.

MES Building Solutions maintains its position at the forefront of changes in building regulations as well as technological advances. Our clients, large or small are therefore assured of a cost effective, cohesive and fully integrated professional service.

About the Authors

Chris Jones is the Technical Director at *MES Building Solutions*. Chris has a Masters Degree in Energy Efficient & Sustainable Building, as well as an Honours degree in Mechanical Engineering. Chris has over 15 years' experience in providing sustainable building solutions and leads the Neighbourly Matters team at MES. He undertakes daylighting, sunlight and shadow cast analysis for planning applications. Chris is also a qualified BREEAM and Code for Sustainable Homes assessor and has worked with some of the UK's top developers, as well as housing associations and local authorities.

Andrew Pickersgill is an Associate member of the Royal Institution of Chartered Surveyors and is a member of our neighbourly matters team. He has a BSc (Hons) degree in Building Surveying. Andrew undertakes daylighting, sunlight and shadow analysis for planning applications. He is also involved in party wall issues and carries out other building surveying services for our clients.



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1. Executive Summary

- 1.1 We have carried out calculations following guidance in Site Layout Planning for Daylight & Sunlight (SLPDS), PJ Littlefair 2011 to ascertain the impact of the proposed rooftop extension of 89 Fellows Road, Camden NW3 3JS, on the daylight and sunlight of the neighbouring properties.
- 1.2 We have assessed 49 windows, serving 18 habitable rooms, within 6 neighbouring residential properties. In this case all of the neighbouring windows and rooms comfortably fulfil all the planning guidance.
- 1.3 We have also assessed amenity spaces serving the 6 properties above, along with those serving 5 other properties. All 11 of the amenity spaces assessed comfortably fulfil the BRE planning guidance.
- 1.4 In our opinion the proposals accord fully with the intent and context of the planning guidance in this case.



2. Introduction

2.1 The purpose of this report is to assess the impact of the proposed rooftop extension of 89 Fellows Road, Camden NW3 3JS, on the daylight and sunlight of the neighbouring properties.

2.2 This report considers the daylight and sunlight issues against the criteria set out for national guidance in the following publications:

- Site Layout Planning for Daylight & Sunlight (SLPDS), PJ Littlefair 2011 published by the BRE (Building Research Establishment).

The SLPDS is the culmination of research undertaken by the BRE to determine whether or not a new development will adversely affect the light to nearby properties. The BRE tests are approved by the Department of the Environment and are widely used by local authorities when deciding on development applications.

- BS 8206-2- Code of practice for skylighting.

2.3 There are no minimum mandatory requirements for sunlight & skylight in Building Regulations for England & Wales but the guidance set out in SLPDS is widely accepted as the approved methodology when calculating sunlight & skylight.

2.4 It is worthy of note that SLPDS was first published in 1991 and BS 8206-2 in 1992. However SLPDS was updated in Oct 2011 and we have therefore undertaken this study on the basis of this guidance document.

3. Description of Development

- 3.1 The scheme comprises of a rooftop extension to the existing residential property to provide an additional floor of accomodation.
- 3.2 The property is located on the south side of Fellows Road and is situated within a terraced block of other similarly sized houses adjoining the road.



Site Location Plan



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4. Assessment Process

The effect on neighbouring properties:

- 4.1 The SLPDS describes three parameters to be assessed in order to measure the impact of the proposed new building on Daylight/Sunlight availability to the key adjacent properties. The three parameters to be assessed are as follows:

1) Daylight:

Vertical Sky Component (VSC)
Daylight Distribution (DD)

2) Sunlight:

Annual Probable Sunlight Hours (APSH)

3) Overshadowing (Amenity Space)

On relevant open spaces

- 4.2 The guidance states that rooms to be assessed should be living rooms, kitchens and bedrooms in residential properties. In non-domestic buildings rooms where occupants 'have a reasonable expectation of daylight' should be assessed. Although these spaces are not defined, examples are given of the type of non-domestic buildings that would normally fall into this category. These include schools, hospitals, hotels and hostels, small workshops and *some* offices.
- 4.3 As it is difficult to be sure of the specific use of neighbouring spaces we have taken a view on the relevance of the spaces adjacent to the proposed development. If we have been in any doubt we have carried out the assessment. However it should be noted some of the spaces we have assessed could fall outside the test requirement criteria.
- 4.4 It is important to note that the numerical values in the guidance are advisory and different criteria may be used based on the requirements for daylighting in an area viewed against other site layout constraints.
- 4.5 The neighbouring properties we have assessed are as follows:
- 1 Huson Close
 - 2 Huson Close
 - 3 Huson Close
 - 4 Huson Close
 - 5 Huson Close
 - 6 Huson Close



4.6 The neighbouring amenity spaces we have assessed are as follows:

- 1 Huson Close
- 2 Huson Close
- 3 Huson Close
- 4 Huson Close
- 5 Huson Close
- 6 Huson Close
- 83 Fellows Road
- 85 Fellows Road
- 87 Fellows Road
- 91 Fellows Road
- 93 Fellows Road

4.7 The assessment is based on the following drawings, provided by ZED Architect:


- 89 Fellows road Existing Elevations 101
- 89 Fellows road Existing Roof Layout and Section 100
- 89 Fellows road Proposed Block Plan 115
- 89 Fellows road Proposed Front and Rear Elevations 111
- 89 Fellows road Proposed Side Elevations 112
- 89 Fellows road Proposed Third and Roof layout and Section 110



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5. Daylight

5.1 Site Layout Planning for Daylight & Sunlight contains the following flow chart showing the steps which should be taken in order to establish whether a building will receive adequate daylight:

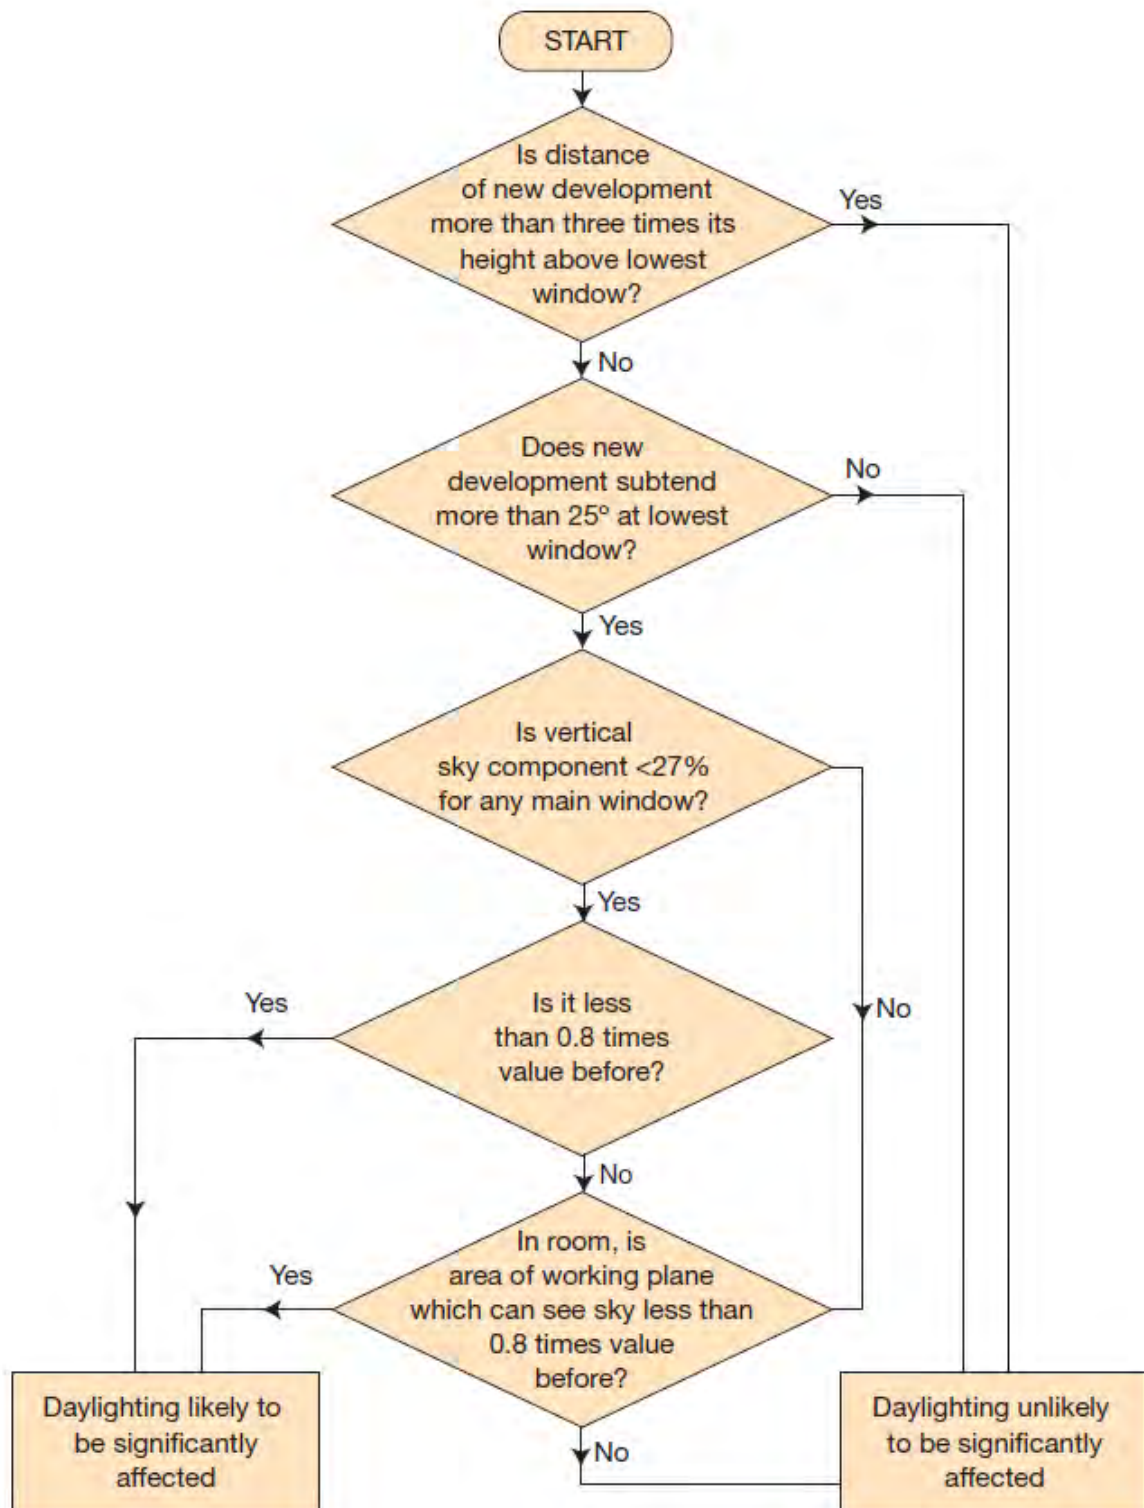

Distance Check:


- 5.2 Site Layout Planning for Daylight & Sunlight (2011) states: "Loss of light to existing windows need not be analysed if the distance of each part of the new development from the existing window is three or more times its height above the centre of the existing window."

Distance Check Results

- 5.3 On this occasion the ratio of the height of the proposed building to its distance from the centre of the lowest existing window is likely to be less than 1:3 and the 25° rule must be applied.

25° Rule:

- 5.4 The angle to the horizontal subtended by the new development at the level of the centre of the lowest affected window should be no greater than 25°. If this is the case then it is unlikely to have a noticeable effect on diffuse skylight enjoyed by the existing building.

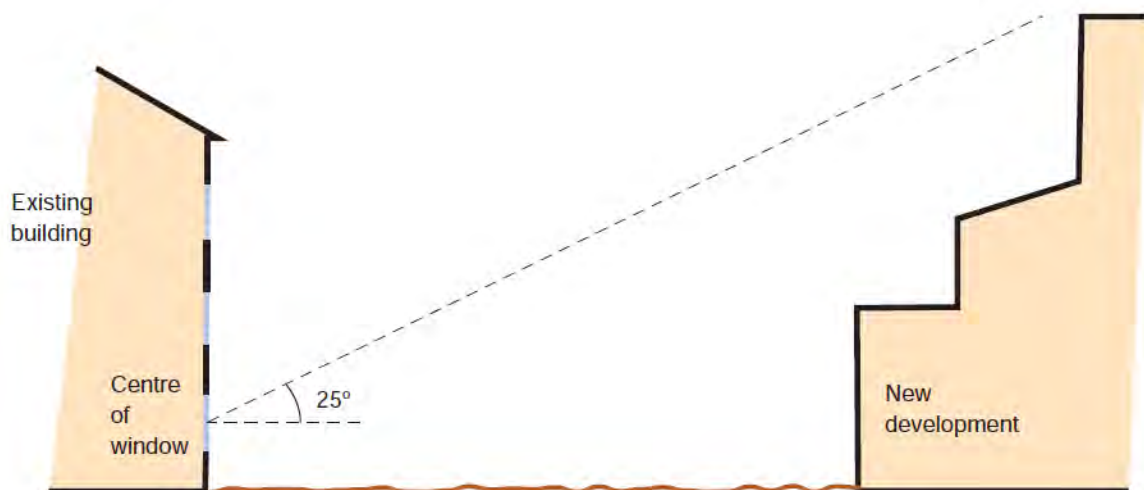

- 5.5 If, for any part of the development, the angle is more than 25°, a more detailed check is needed to find the loss of skylight to the existing building:

25° Rule Results

- 5.6 On this occasion the angle to the horizontal subtended by the new development at the level of the centre of the lowest affected window is likely to be greater than 25° and more detailed checks are necessary:



Vertical Sky Component:

- 5.7 Daylight is the light received from the sun which is diffused through the sky's clouds. Even on a cloudy day when the sun is not visible a room will continue to be lit with light from the sky. This is also known as 'diffuse light'. Any reduction in the total amount of daylight can be calculated by finding the 'Vertical Sky Component'.
- 5.8 The Vertical Sky Component (VSC) is the ratio of the direct skylight illuminance falling on a vertical face at a reference point (usually the centre of a window), to the simultaneous horizontal illuminance under an unobstructed sky.
- 5.9 The guidance states that the VSC will be adversely affected if after a development it is both less than 27% of the overall available diffuse light and less than 0.8 times its former value.
- 5.10 Therefore if the VSC is more than 27% then enough light would still be reaching the window of the neighbouring building. However if the VSC is less than 27% as well as less than 0.8 times its former value the occupants will notice the reduction in the amount of skylight.

VSC Results

- 5.11 Calculations were undertaken in accordance with the planning guidance contained in BRE document 209 'Site Layout Planning for Daylight & Sunlight' - PJ Littlefair 2011.


Detailed results are in Section 8.

- 5.12 As can be seen the proposed development has very little impact on neighbouring properties with all of the 49 windows serving habitable rooms in the 6 neighbouring properties assessed comfortably meeting the BRE guidance for vertical sky component.



Daylight Distribution:

- 5.13 Where room layouts are known (or estimated) the impact on daylighting distribution can be found by plotting what is known as the 'no sky line' in each of the main rooms. These are the same rooms as used for the VSC test.
- 5.14 The no sky line effectively divides the points on the working plane (0.85m high for residential properties and 0.7m high for offices) that cannot see the sky. Therefore areas beyond the no sky line will receive no direct daylight but will instead be lit from reflected light.

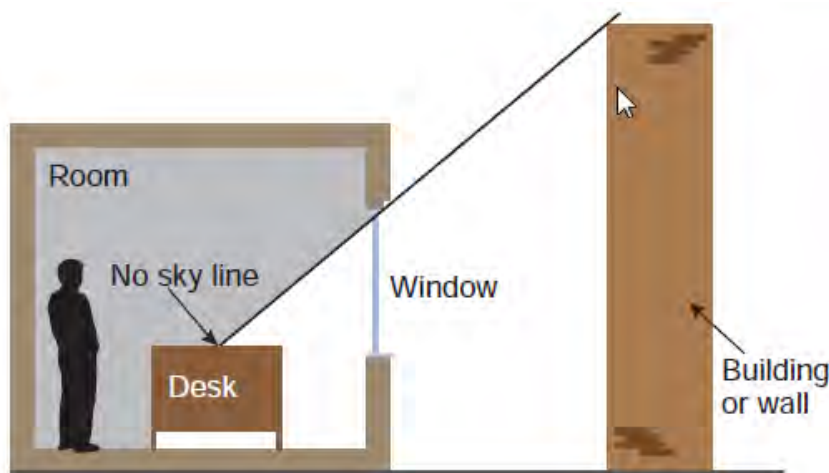

BRE 209

- 5.15 If, following the construction of a new development, the no sky line moves so that the area of the existing room, which does not receive direct skylight, is reduced to less than 0.8 times its former value, this will be noticeable to the occupants.
- 5.16 We have estimated internal layouts to assess the Daylight Distribution in rooms adjacent to the development.

Daylight Distribution Results

- 5.17 Calculations were undertaken in accordance with the planning guidance contained in BRE document 209 'Site Layout Planning for Daylight & Sunlight' - PJ Littlefair 2011.

Detailed results are in Section 8.

- 5.18 As can be seen the proposed development has very little impact on neighbouring properties with all of the 18 habitable rooms in the 6 neighbouring properties assessed comfortably meeting the BRE guidance for daylight distribution.

6. Sunlight

Available Sunlight Hours

- 6.1 Guidance for minimum sunlight values can be found in Section 3 of Site Layout Planning for Daylight and Sunlight (SLPDS).
- 6.2 Habitable rooms in domestic buildings that face within 90° of due south are tested, as are rooms in non-domestic buildings that have a particular requirement for sunlight.
- 6.3 The recommendations are that applicable windows should receive a minimum of 25% of the total annual probable sunshine hours, to include a minimum of 5% of that which is available during the winter months between 21st September to the 21st March (the approximate dates of the spring and autumn equinoxes).
- 6.4 However if this is not possible (or the amount of sunlight is already reduced because of the effect of existing obstructions) then a further reduction in sunlight availability will be noticeable to an occupier if the total number of sunlight hours is below the target 25% of the total annual probable sunshine hours, to include a minimum of 5% of that which is available during the winter months, *and* is less than 0.8 times its former value prior to the development.
- 6.5 There is no requirement for windows that face within 90° of due north so windows that fall into this category have not been considered for sunlight calculations.

Available Sunlight Hours Results

- 6.6 Calculations were undertaken in accordance with the planning guidance contained in BRE document 209 'Site Layout Planning for Daylight & Sunlight' - PJ Littlefair 2011.

Detailed results are in Section 8.

- 6.7 As can be seen the proposed development has very little impact on neighbouring properties with all of the 49 windows serving habitable rooms in the 6 neighbouring properties assessed comfortably meeting the BRE guidance for annual probable sunlight hours.



7. Amenity Space

- 7.1 Recent guidance through the BRE suggests that at least 50% of any garden or open spaces should receive no less than 2 hours of direct sun on the spring equinox (March 21st).
- 7.2 Open spaces would normally include:
- Gardens, usually the main back garden of a house
 - Parks and playing fields
 - Children's playgrounds
 - Outdoor swimming pools and paddling pools
 - Sitting out areas such as those between non-domestic buildings and in public squares
 - Focal points for views such as a group of monuments or fountains

Amenity Space Results

- 7.3 Calculations were undertaken in accordance with the planning guidance contained in BRE document 209 'Site Layout Planning for Daylight & Sunlight' - PJ Littlefair 2011.

Detailed results are in Section 8:

- 7.4 As can be seen the proposed development has very little impact on neighbouring amenity spaces with amenity spaces serving all eleven of the neighbouring properties assessed comfortably meeting the BRE guidance for sunlight to external spaces.



8. Appendices

Results:

*Vertical Sky Component
Available Sunlight Hours*

Daylight Distribution

Amenity Space



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Project Name: 201125 89 Fellows Road
 Report Title: Daylight & Sunlight - Neighbour Analysis
 Date of Analysis: 25/11/2020

Floor Ref.	Room Ref.	Room Use.	Window Ref.		VSC	Pr/Ex	Meets BRE Guidance	Annual	Pr/Ex	Meets BRE Guidance	Winter	Pr/Ex	Meets BRE Guidance								
1 Huson Close																					
Gnd	R1	KD	W1	Existing	23.21	0.97	YES	*North*	1.00	YES	1.00	1.00	YES								
				Proposed	22.59																
			W2	Existing	62.85	0.99	YES							14.00	1.00	YES	1.00				
				Proposed	62.40									14.00			1.00				
			W3	Existing	66.35	0.99	YES							26.00	1.00	YES	3.00				
				Proposed	65.97									26.00			3.00				
1st	R1	Living Room	W1	Existing	31.62	0.98	YES	*North*	1.00	YES	1.00	1.00	YES								
				Proposed	30.87																
			W2	Existing	32.25	0.98	YES							*North*	1.00	YES	1.00	1.00	YES		
				Proposed	31.62																
2nd	R1	Bedroom	W1	Existing	35.76	0.98	YES	*North*	1.00	YES	1.00	1.00	YES								
				Proposed	34.96																
			W2	Existing	36.19	0.98	YES							*North*	1.00	YES	1.00	1.00	YES		
				Proposed	35.50																
2 Huson Close																					
Gnd	R1	KD	W1	Existing	10.03	0.91	YES	*North*	1.00	YES	1.00	1.00	YES								
				Proposed	9.16																
			W2	Existing	19.46	0.96	YES							*North*	1.00	YES	1.00	1.00	YES		
				Proposed	18.63																
			W3	Existing	19.20	0.96	YES							*North*	1.00	YES	1.00	1.00	YES		
				Proposed	18.41																
			W4	Existing	18.22	0.96	YES							*North*	1.00	YES	1.00	1.00	YES		
				Proposed	17.41																
			W5	Existing	16.20	0.95	YES							*North*	1.00	YES	1.00	1.00	YES		
				Proposed	15.43																
1st	R1	Living Room	W1	Existing	30.51	0.97	YES	*North*	1.00	YES	1.00	1.00	YES								
				Proposed	29.53																
			W2	Existing	30.93	0.97	YES							*North*	1.00	YES	1.00	1.00	YES		
				Proposed	30.03																
2nd	R1	Bedroom	W1	Existing	34.56	0.97	YES	*North*	1.00	YES	1.00	1.00	YES								
				Proposed	33.54																
			W2	Existing	34.84	0.97	YES							*North*	1.00	YES	1.00	1.00	YES		
				Proposed	33.89																

Project Name: 201125 89 Fellows Road
 Report Title: Daylight & Sunlight - Neighbour Analysis
 Date of Analysis: 25/11/2020

Floor Ref.	Room Ref.	Room Use.	Window Ref.		VSC	Pr/Ex	Meets BRE Guidance	Annual	Pr/Ex	Meets BRE Guidance	Winter	Pr/Ex	Meets BRE Guidance
3 Huson Close													
Gnd	R1	KD	W1	Existing	1.74	1.00	YES	*North*			*North*		
				Proposed	1.74								
			W2	Existing	18.36	0.95	YES	*North*			*North*		
				Proposed	17.48								
			W3	Existing	18.26	0.95	YES	*North*			*North*		
				Proposed	17.36								
			W4	Existing	18.81	0.95	YES	*North*			*North*		
1st	R1	Living Room	W1	Existing	30.09	0.97	YES	*North*			*North*		
				Proposed	29.05								
			W2	Existing	30.27	0.97	YES	*North*			*North*		
2nd	R1	Bedroom	W1	Existing	34.25	0.97	YES	*North*			*North*		
				Proposed	33.18								
			W2	Existing	34.38	0.97	YES	*North*			*North*		
4 Huson Close													
Gnd	R1	KD	W1	Existing	21.76	0.96	YES	*North*			*North*		
				Proposed	20.83								
			W2	Existing	53.47	0.99	YES	9.00	1.00	YES	0.00	1.00	YES
				Proposed	52.92			9.00			0.00		
			W3	Existing	59.90	0.99	YES	9.00	1.00	YES	0.00	1.00	YES
				Proposed	59.32			9.00			0.00		
			W4	Existing	60.44	0.99	YES	13.00	1.00	YES	0.00	1.00	YES
				Proposed	59.83			13.00			0.00		
			W5	Existing	60.11	0.99	YES	10.00	1.00	YES	0.00	1.00	YES
				Proposed	59.48			10.00			0.00		
			W6	Existing	54.09	0.99	YES	5.00	1.00	YES	0.00	1.00	YES
				Proposed	53.44			5.00			0.00		
1st	R1	Living Room	W1	Existing	30.31	0.97	YES	*North*			*North*		
				Proposed	29.41								
			W2	Existing	30.29	0.97	YES	*North*			*North*		
				Proposed	29.32								
2nd	R1	Bedroom	W1	Existing	34.87	0.97	YES	*North*			*North*		
				Proposed	33.94								
			W2	Existing	34.92	0.97	YES	*North*			*North*		
				Proposed	33.93								

Project Name: 201125 89 Fellows Road
 Report Title: Daylight & Sunlight - Neighbour Analysis
 Date of Analysis: 25/11/2020

Floor Ref.	Room Ref.	Room Use.	Window Ref.		VSC	Pr/Ex	Meets BRE Guidance	Annual	Pr/Ex	Meets BRE Guidance	Winter	Pr/Ex	Meets BRE Guidance
5 Huson Close													
Gnd	R1	KD	W1	Existing	22.16	0.97	YES	*North*			*North*		
				Proposed	21.53								
			W2	Existing	62.88	0.99	YES	15.00	1.00	YES	0.00	1.00	YES
				Proposed	62.51		15.00			0.00			
			W3	Existing	62.95	0.99	YES	15.00	1.00	YES	0.00	1.00	YES
				Proposed	62.50		15.00			0.00			
1st	R1	Living Room	W1	Existing	31.18	0.98	YES	*North*			*North*		
				Proposed	30.54								
			W2	Existing	30.77	0.98	YES	*North*			*North*		
				Proposed	30.03								
2nd	R1	Bedroom	W1	Existing	34.70	0.98	YES	*North*			*North*		
				Proposed	34.01								
			W2	Existing	34.49	0.98	YES	*North*			*North*		
				Proposed	33.69								
6 Huson Close													
Gnd	R1	KD	W1	Existing	19.46	0.98	YES	*North*			*North*		
				Proposed	19.11								
			W2	Existing	16.52	0.98	YES	*North*			*North*		
				Proposed	16.19								
1st	R1	Living Room	W1	Existing	32.80	0.99	YES	*North*			*North*		
				Proposed	32.40								
			W2	Existing	32.16	0.98	YES	*North*			*North*		
				Proposed	31.67								
2nd	R1	Bedroom	W1	Existing	35.97	0.99	YES	*North*			*North*		
				Proposed	35.51								
			W2	Existing	35.70	0.98	YES	*North*			*North*		
				Proposed	35.16								

Project Name: 201125 89 Fellows Road
 Report Title: Daylight Distribution - Neighbour Analysis
 Date of Analysis: 25/11/2020

Floor Ref.	Room Ref.	Room Use.		Room Area	Lit Area Existing	Lit Area Proposed	Pr/Ex	Meets BRE Guidance
1 Huson Close								
Gnd	R1	KD	Area m2 % of room	39.75	37.05 93%	37.04 93%	100.00%	YES
1st	R1	Living Room	Area m2 % of room	22.06	21.75 99%	21.74 99%	100.00%	YES
2nd	R1	Bedroom	Area m2 % of room	16.31	15.99 98%	15.99 98%	100.00%	YES
2 Huson Close								
Gnd	R1	KD	Area m2 % of room	19.85	16.22 82%	16.19 82%	100.00%	YES
1st	R1	Living Room	Area m2 % of room	21.94	21.65 99%	21.65 99%	100.00%	YES
2nd	R1	Bedroom	Area m2 % of room	16.35	16.04 98%	16.04 98%	100.00%	YES
3 Huson Close								
Gnd	R1	KD	Area m2 % of room	19.75	16.16 82%	16.16 82%	100.00%	YES
1st	R1	Living Room	Area m2 % of room	22.03	21.79 99%	21.79 99%	100.00%	YES
2nd	R1	Bedroom	Area m2 % of room	16.31	16.06 98%	16.06 98%	100.00%	YES
4 Huson Close								
Gnd	R1	KD	Area m2 % of room	34.88	24.50 70%	24.48 70%	100.00%	YES
1st	R1	Living Room	Area m2 % of room	21.94	21.73 99%	21.73 99%	100.00%	YES
2nd	R1	Bedroom	Area m2 % of room	16.35	16.12 99%	16.12 99%	100.00%	YES
5 Huson Close								
Gnd	R1	KD	Area m2 % of room	36.32	29.99 83%	29.98 83%	100.00%	YES
1st	R1	Living Room	Area m2 % of room	22.03	21.82 99%	21.82 99%	100.00%	YES
2nd	R1	Bedroom	Area m2 % of room	16.31	16.10 99%	16.10 99%	100.00%	YES
6 Huson Close								
Gnd	R1	KD	Area m2 % of room	19.75	18.17 92%	18.16 92%	100.00%	YES
1st	R1	Living Room	Area m2 % of room	21.86	21.69 99%	21.69 99%	100.00%	YES
2nd	R1	Bedroom	Area m2 % of room	16.35	16.15 99%	16.15 99%	100.00%	YES

Project Name: 201125 89 Fellows Road
 Report Title: Two hours Sunlight to Amenity - Neighbour Analysis
 Date of Analysis: 25/11/2020


Floor Ref.	Amenity Ref.	Amenity Area	Lit Area Existing	Lit Area Proposed	Pr/Ex	Meets BRE Guidance
1 Huson Close						
Gnd	A1	Area m2 Percentage	23.43 0.00 0%	0.00 0.00 0%	1.00	YES
2 Huson Close						
Gnd	A1	Area m2 Percentage	41.17 0.00 0%	0.00 0.00 0%	1.00	YES
3 Huson Close						
Gnd	A1	Area m2 Percentage	43.24 0.00 0%	0.00 0.00 0%	1.00	YES
4 Huson Close						
Gnd	A1	Area m2 Percentage	22.76 0.00 0%	0.00 0.00 0%	1.00	YES
5 Huson Close						
Gnd	A1	Area m2 Percentage	20.08 0.00 0%	0.00 0.00 0%	1.00	YES
6 Huson Close						
Gnd	A1	Area m2 Percentage	48.14 0.00 0%	0.00 0.00 0%	1.00	YES
83 Fellows Road						
Gnd	A1	Area m2 Percentage	24.13 4.50 19%	4.50 4.50 19%	1.00	YES
85 Fellows Road						
Gnd	A1	Area m2 Percentage	42.20 17.13 41%	17.13 17.13 41%	1.00	YES
87 Fellows Road						
Gnd	A1	Area m2 Percentage	41.73 17.74 43%	17.74 17.74 43%	1.00	YES



Project Name: 201125 89 Fellows Road
 Report Title: Two hours Sunlight to Amenity - Neighbour Analysis
 Date of Analysis: 25/11/2020


Floor Ref.	Amenity Ref.	Amenity Area	Lit Area Existing	Lit Area Proposed	Pr/Ex	Meets BRE Guidance
91 Fellows Road						
Gnd	A1	Area m2 Percentage	42.45 23.30 55%	23.30 55%	1.00	YES
93 Fellows Road						
Gnd	A1	Area m2 Percentage	23.60 4.14 18%	4.14 18%	1.00	YES

Window & Room References:



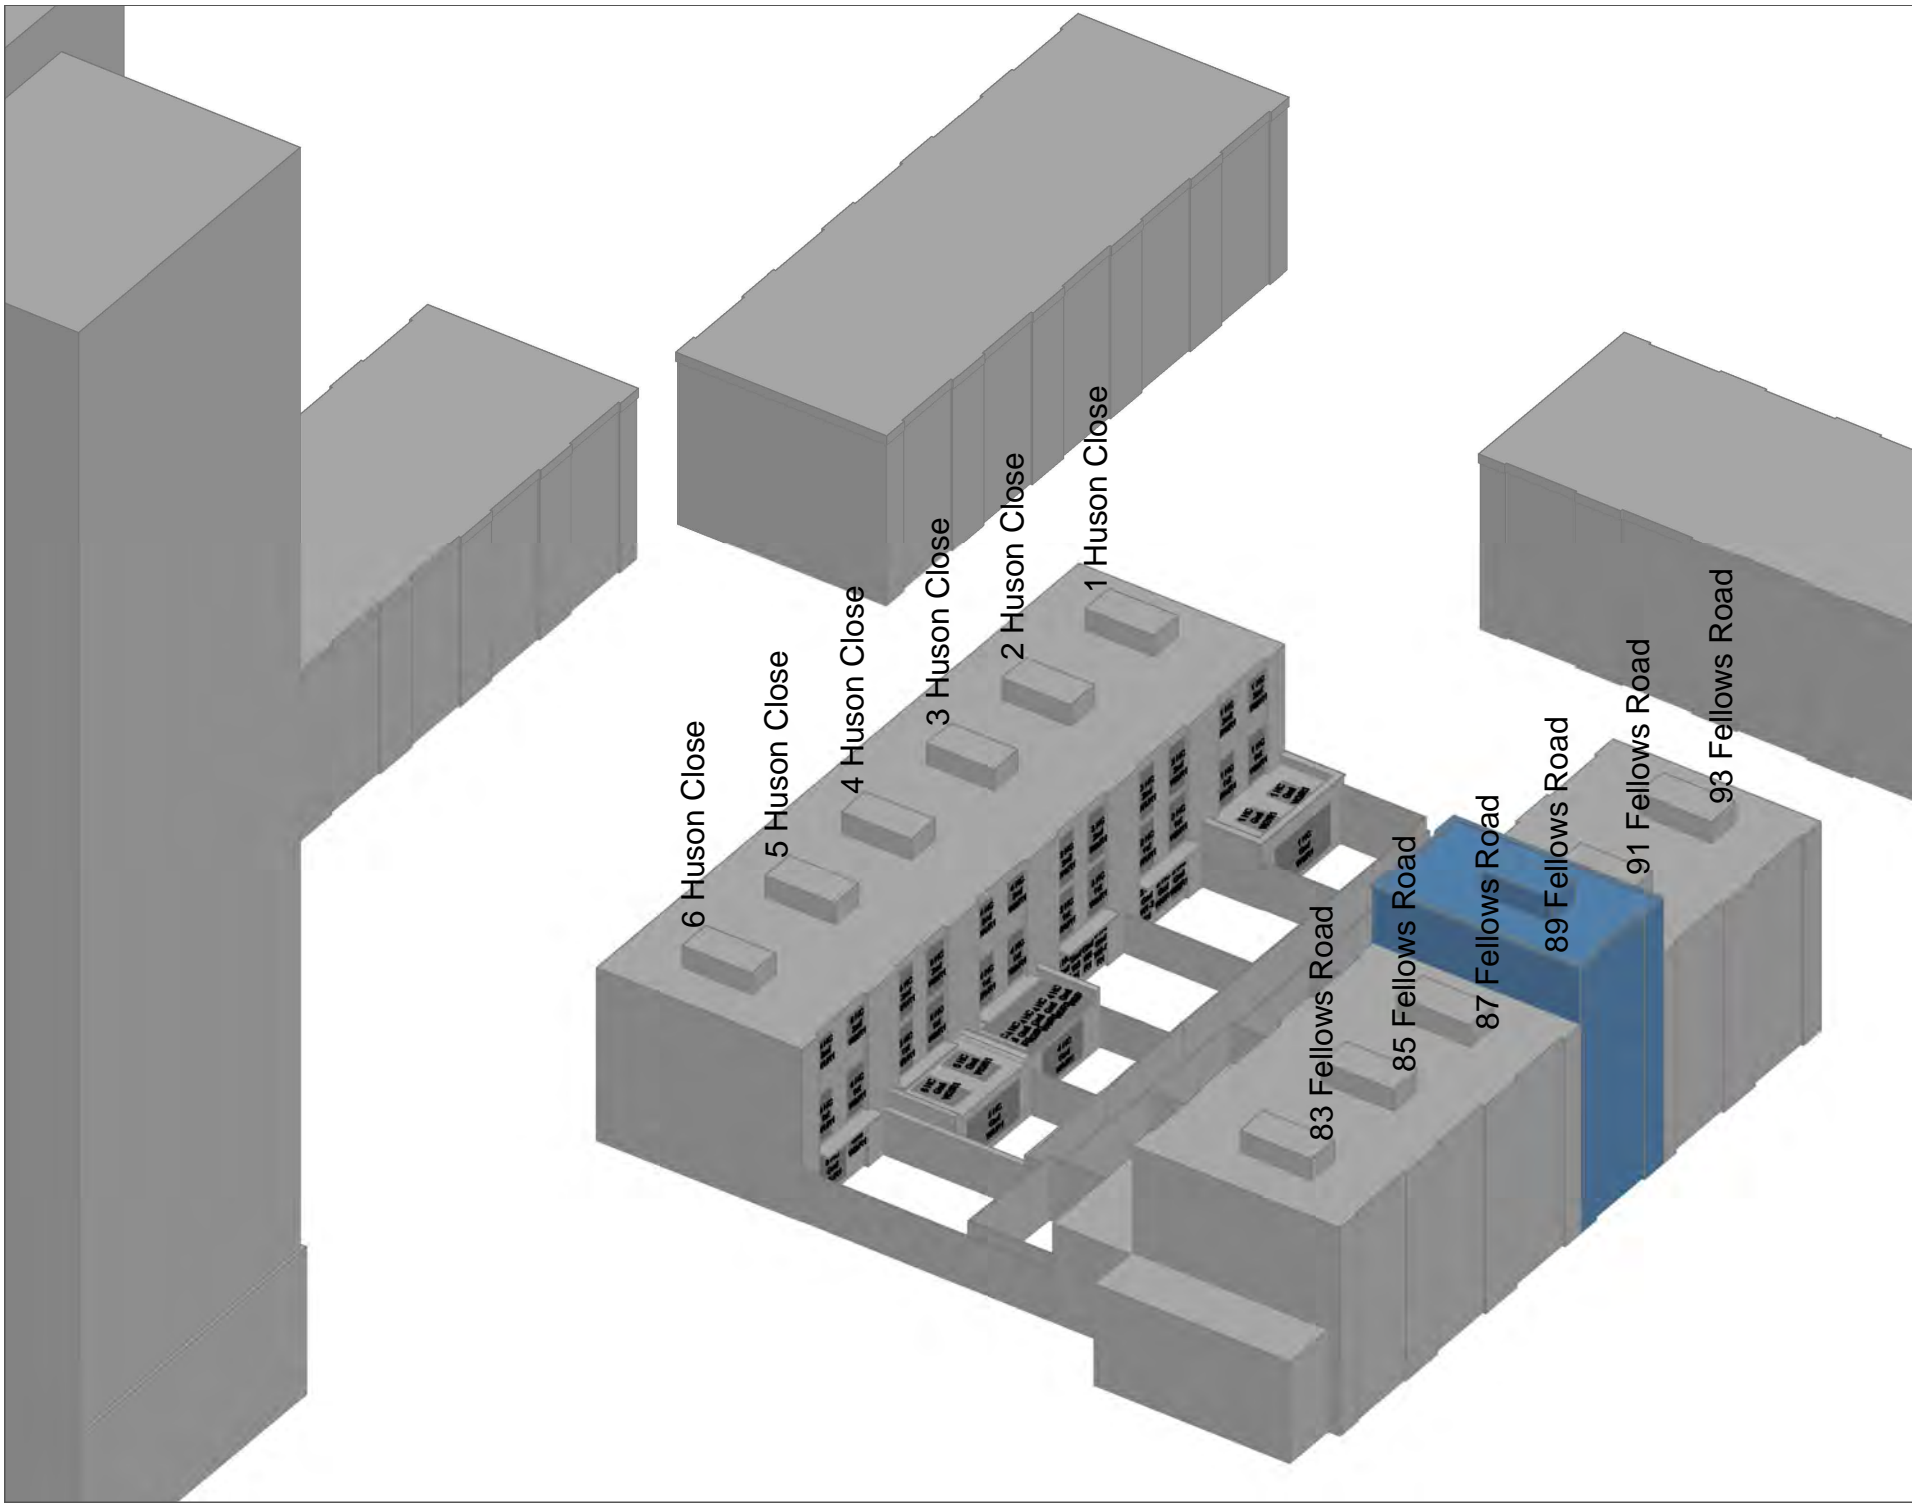

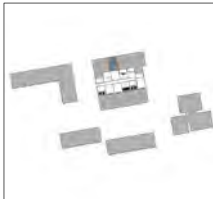NOTES		
		
NO.	REVISION	DATE
A	-	-
B	-	-
C	-	-
D	-	-
 <p>MES Building Solutions Newark Beacon Beacon Hill Office Park Newark Notts. NG24 2TN 01636 653 055 www.mesbuildingsolutions.co.uk</p>		
<p>CLIENT Boyer Planning Limited</p>		
<p>PROJECT 89 Fellows Road</p>		
<p>DRAWING TITLE 3D Overview</p>		
<p>DRAWN BY AP/JB</p>		<p>CHECKED BY CJ</p>
<p>DATE 25/11/2020</p>		<p>DRAWING NO. -</p>
<p>SCALE NTS</p>		

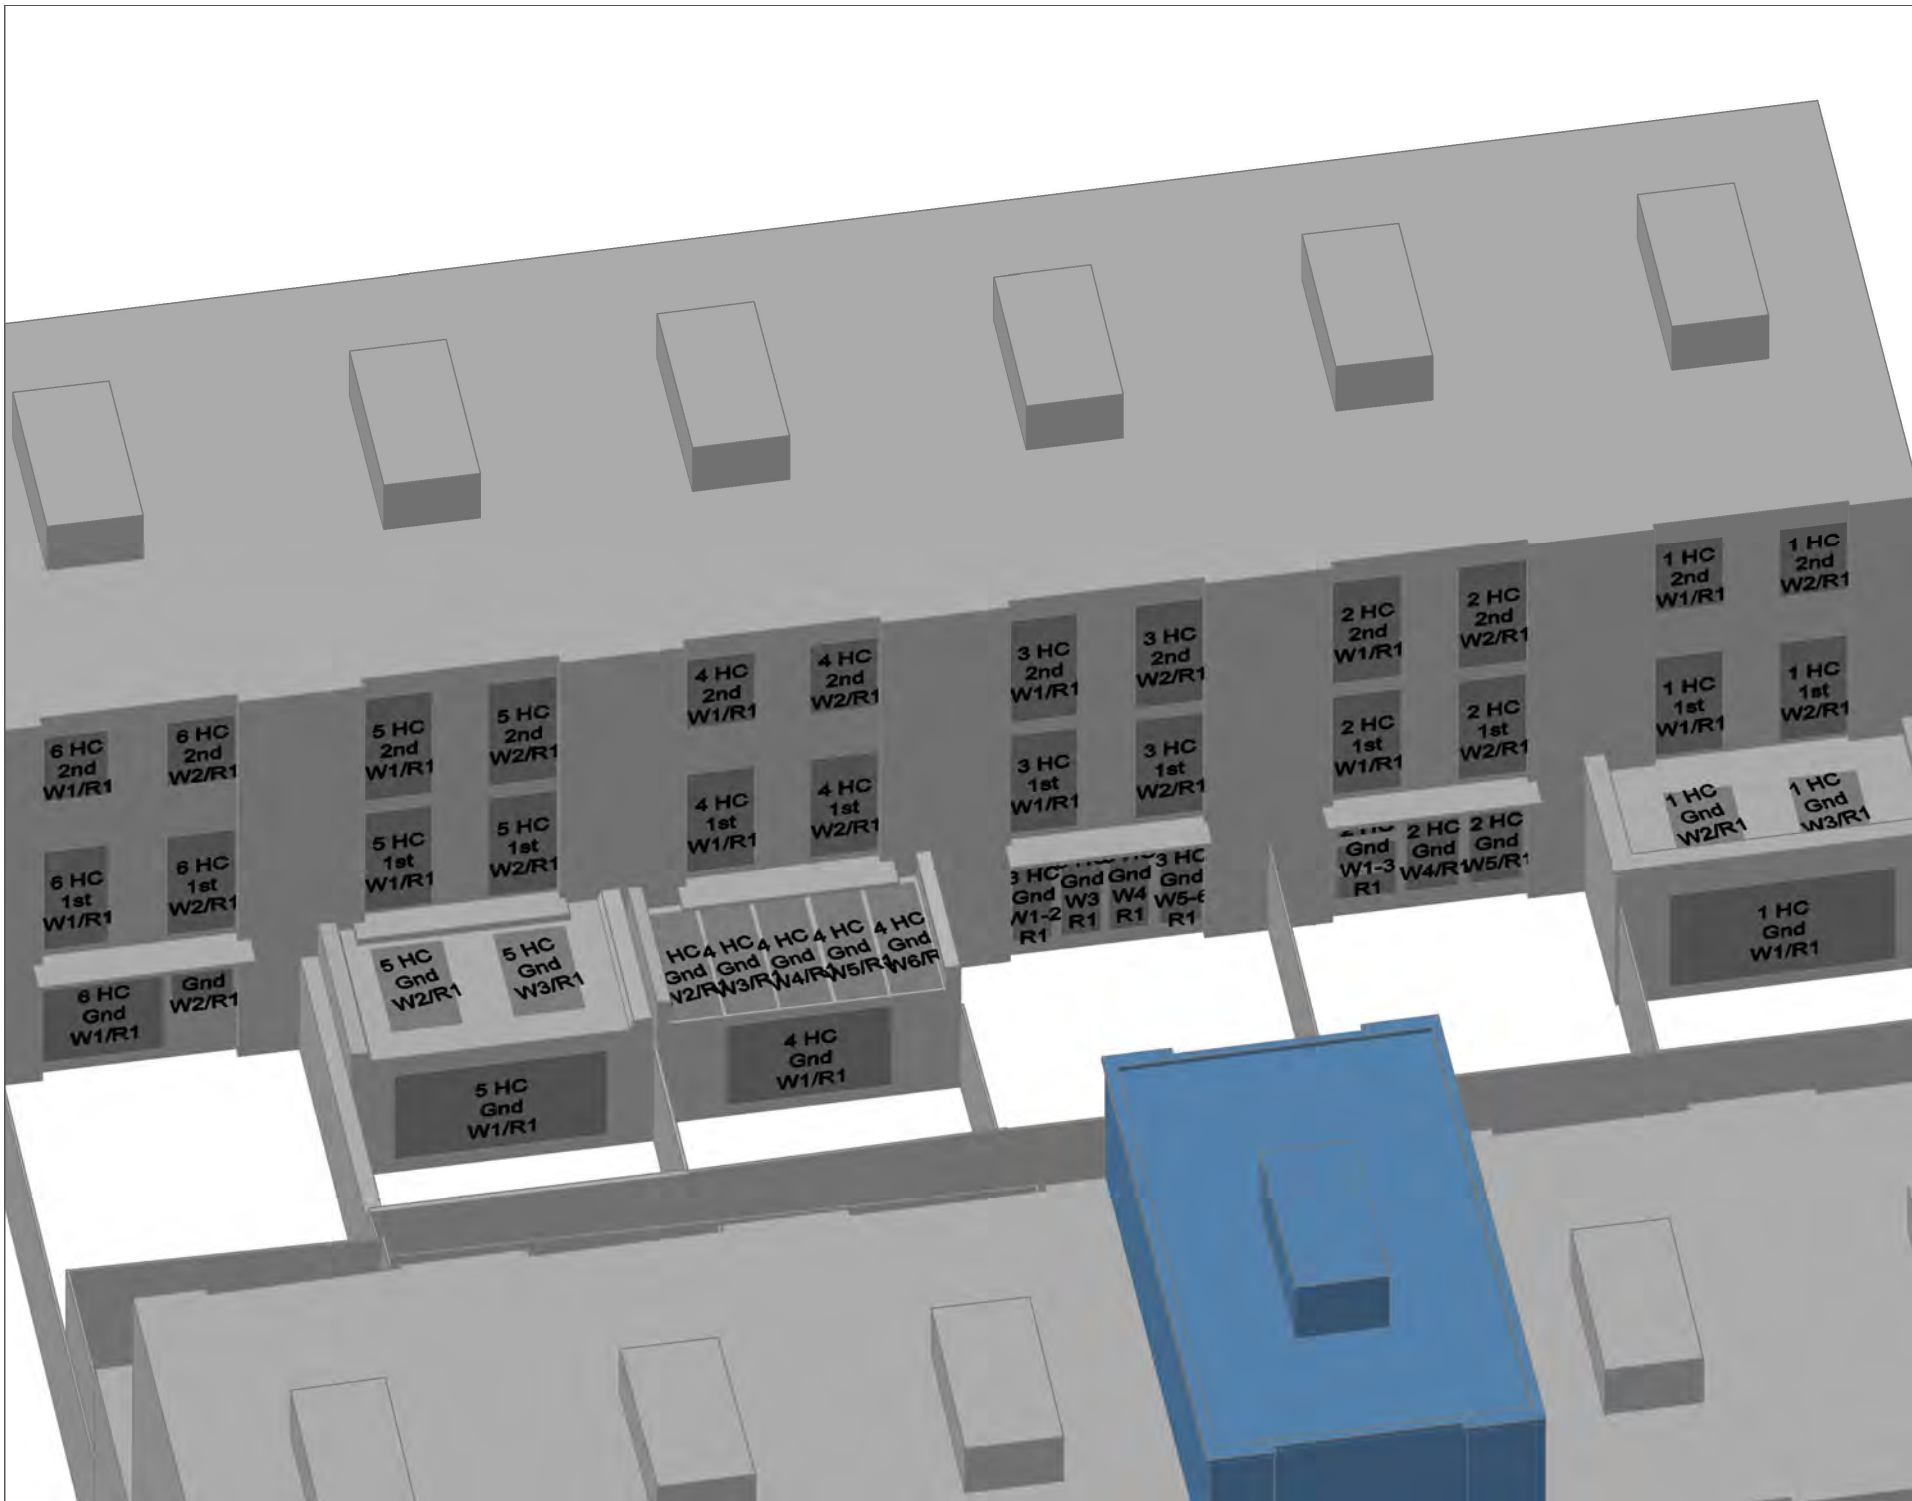

NOTES

NO.	REVISION	DATE
A	-	-
B	-	-
C	-	-
D	-	-

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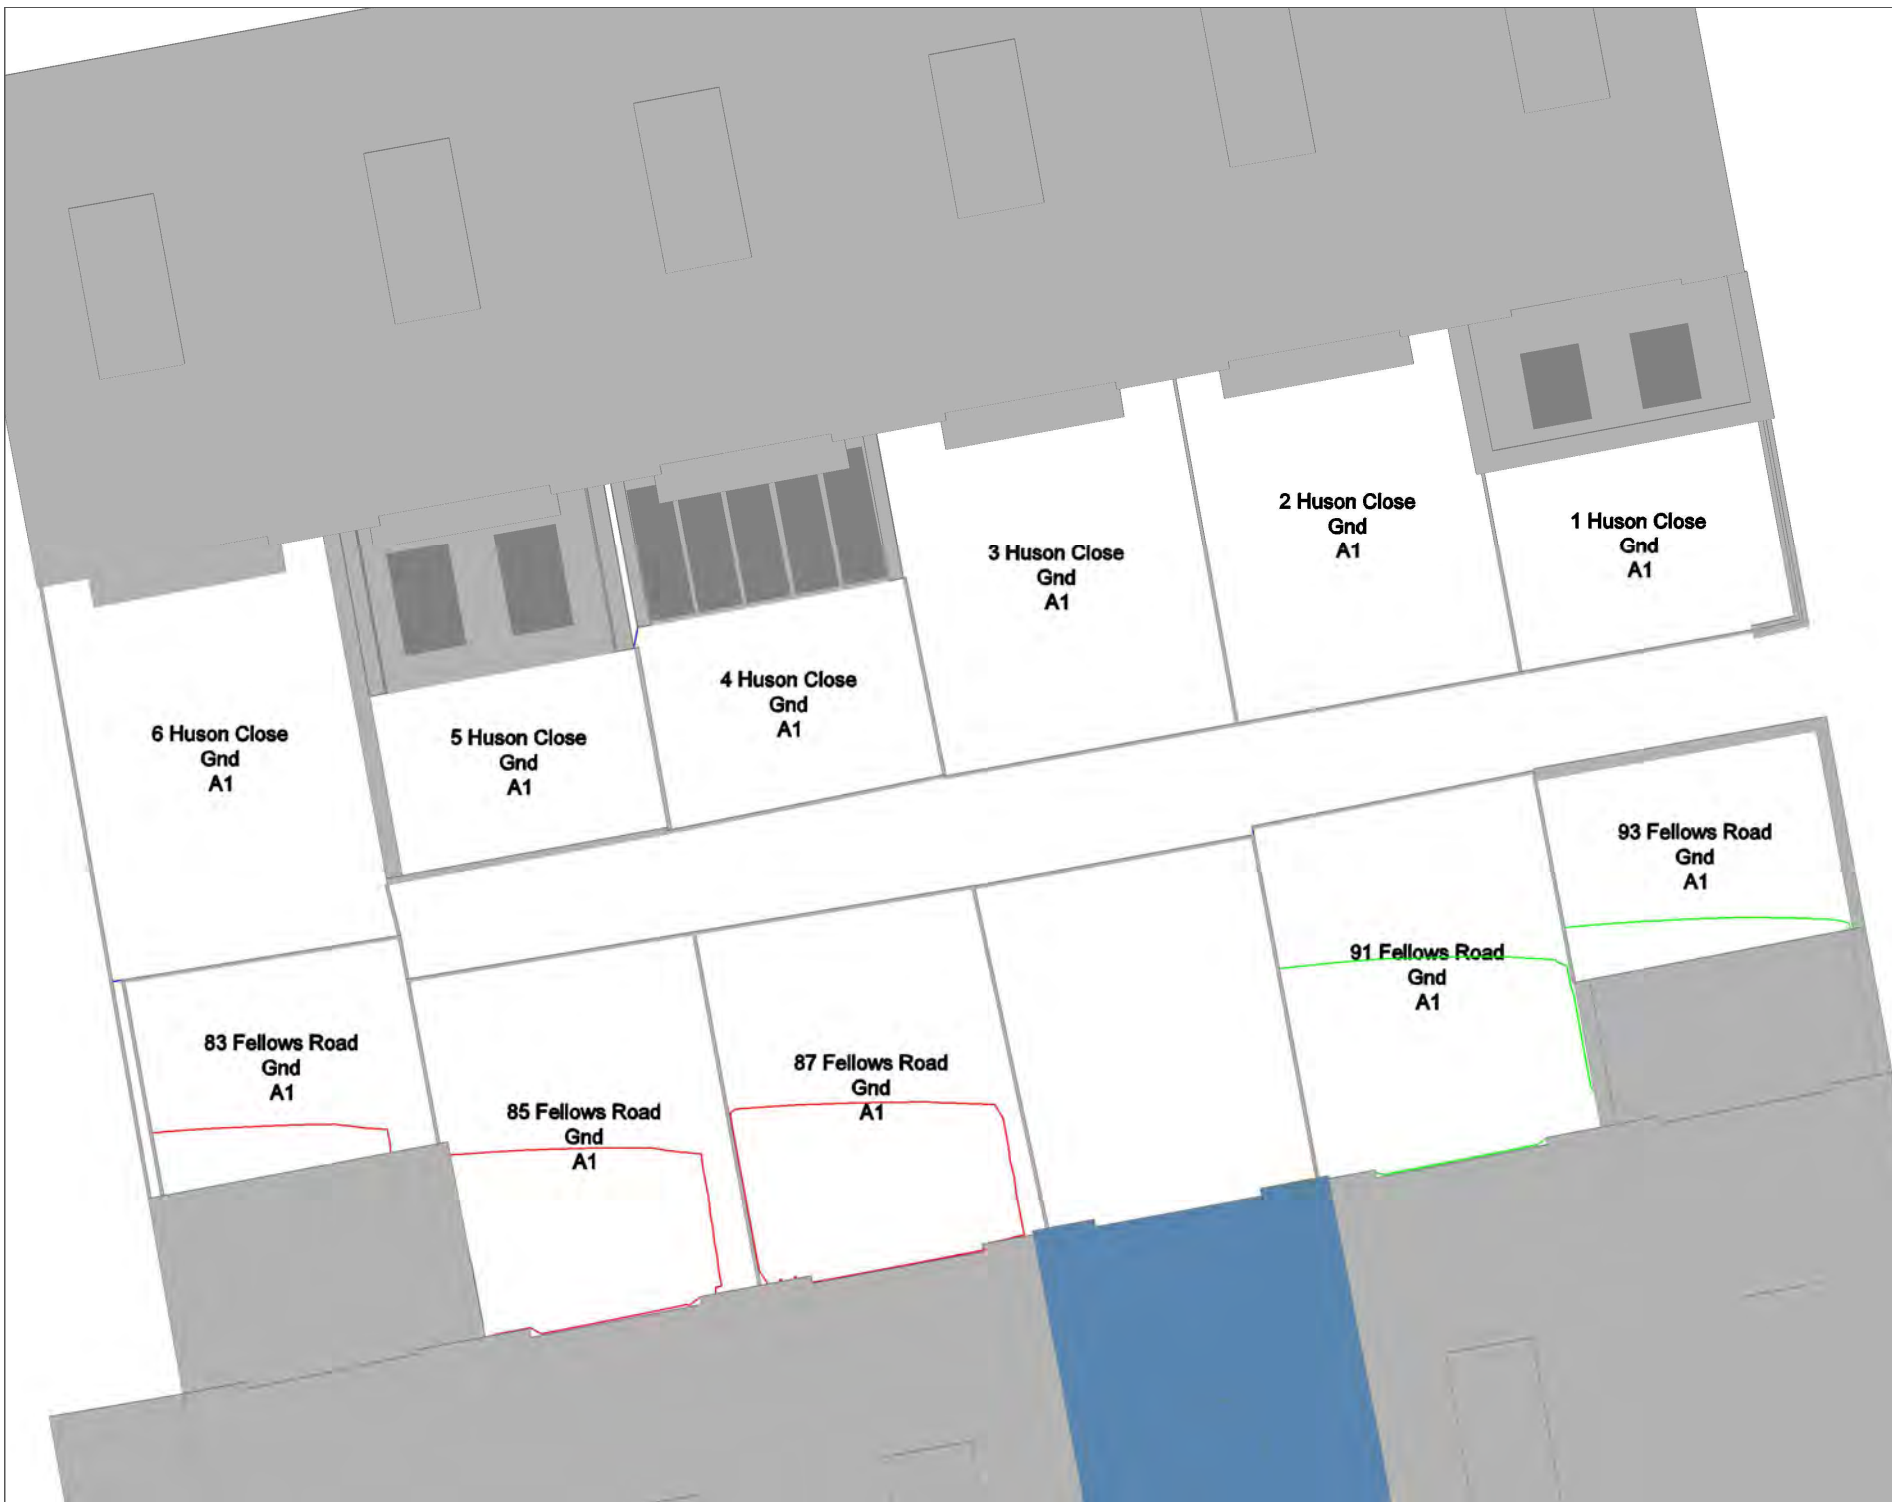
MES Building Solutions
Newark Beacon
Beacon Hill Office Park
Newark
Notts. NG24 2TN
01636 653 055
www.mesbuildingsolutions.co.uk

CLIENT
Boyer Planning Limited

PROJECT
89 Fellows Road

DRAWING TITLE
Window Labels

DRAWN BY AP/JB	CHECKED BY CJ
DATE 25/11/2020	DRAWING NO. -
SCALE NTS	



NOTES

NO.	REVISION	DATE
A	-	-
B	-	-
C	-	-
D	-	-

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CLIENT
Boyer Planning Limited

PROJECT
89 Fellows Road

DRAWING TITLE
Amenity

DRAWN BY AP/JB	CHECKED BY CJ
DATE 25/11/2020	DRAWING NO. -
SCALE NTS	

9. Notes

- 9.1 This report has been prepared for the sole use of the Client. No representation or warranty (expressed or implied) is given to any other parties. Therefore this report should not be relied upon by any third party and we accept no liability from the use of this report by any other party.
- 9.2 Where full access was not available we have made reasonable estimations of internal layouts, floor areas, window sizes and positions etc.
- 9.3 Our calculations model has been built from a combination of architect's plans, partial site survey, site and aerial photographs.
- 9.4 We are not aware of any conflicts of interest between ourselves and any other party concerning this project.