
Proposed conversion into two units with no additional footprint

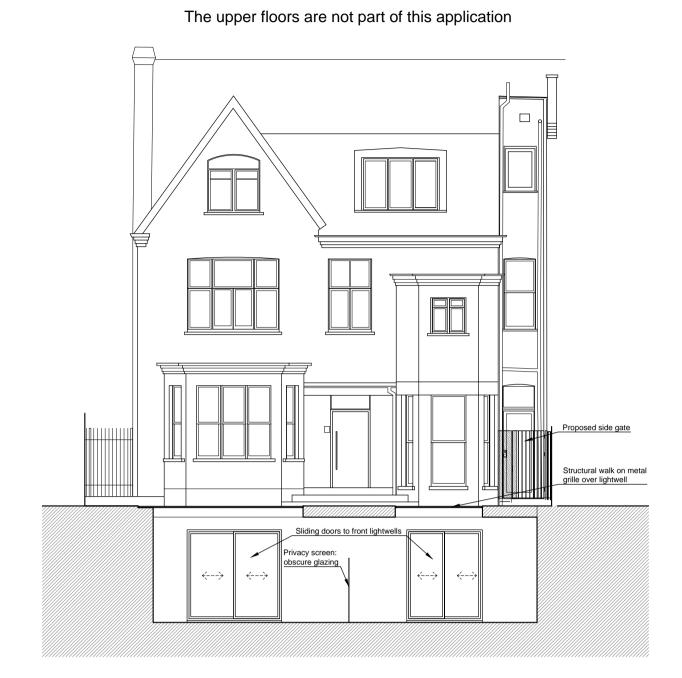


Proposed Front Elevation/Section through front lightwell Scale 1:100




Proposed Rear Elevation/Section through rear lightwell Scale 1:100


Additional Notes

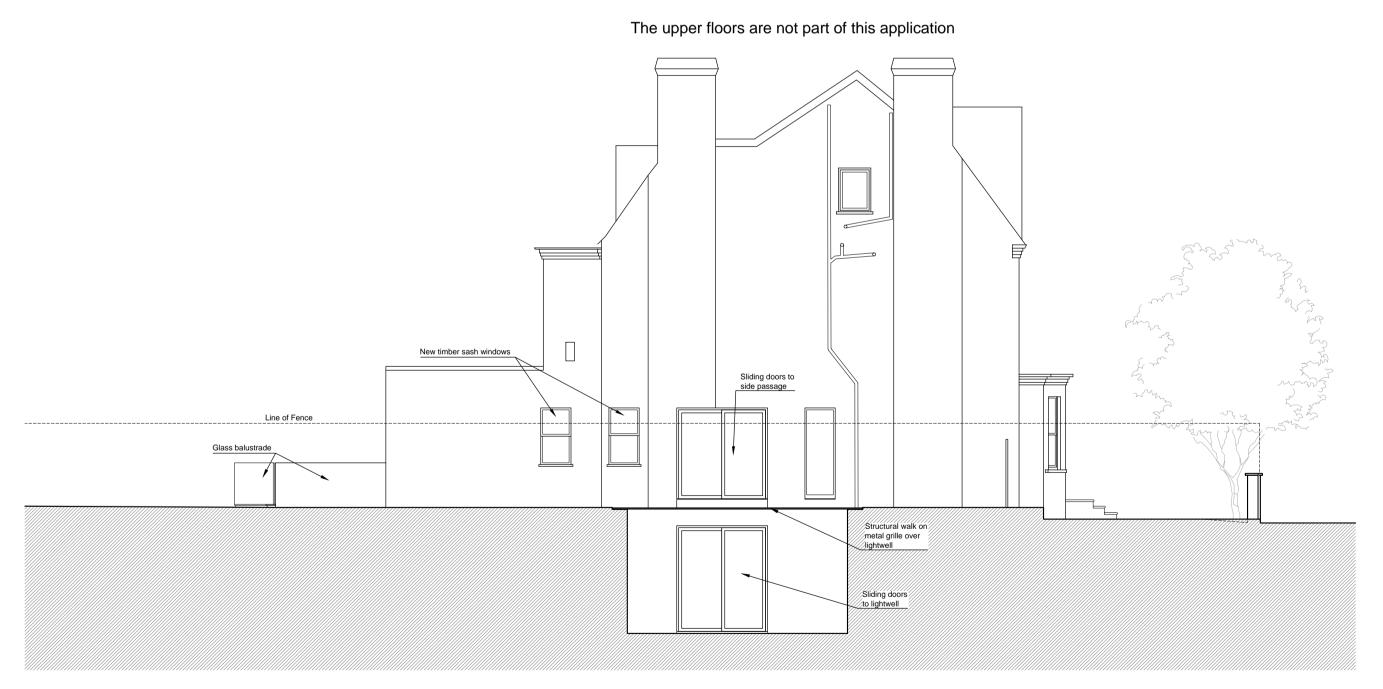


Proposed Side Elevation/Section through side lightwell Scale 1:100

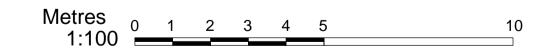


Bins Storage Details

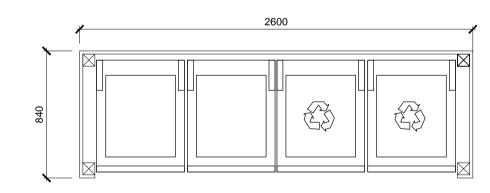

Bins / Recycle Storage - Plan Scale 1:25

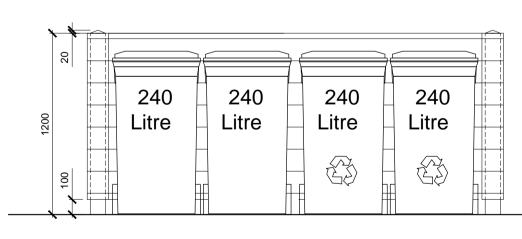

Refuse Bins - Elevation

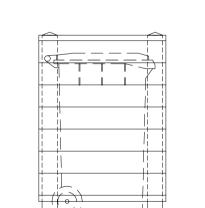

Refuse Bin Enclosure Details

Sides timber enclosure: 140x21mm thick pressure treated timber horizontal slats with 10mm gaps between slats, allow 100mm gap at bottom. Painted Matte Black, inside & out.

Posts: 80x80mm pressure treated SW timber.
Top of post to be 20mm high Pyramid shape.

Painted Matte Black.

Side Elevation

Local authorities (Planning Group or Building Control) might request for additional items / information to be added / revised.

Contractor, sub-contractor or supplier is to report any errors, omission or discrepancies on the drawings, and shall not vary any work shown on the drawings without obtaining prior approval from the architect. Contractor, sub-contractor or supplier is responsible for requesting any additional information from the architect for the correct execution of the works.

Contractor, sub-contractor or supplier shall supply to the architect all shop drawings, illustrations, specifications, etc. of all specialist work to be incorporated into the main contract works, and shall immediately inform the architect if any work shown on this drawing is not in accordance with the relevant codes of practice recognised as good practice throughout the

industry or if it does not comply with the relevant local authority bye-laws or building regulations.

Contractor to verify all dimensions on site before commencing any work on site or preparing any shop drawings. Figured dimensions to take precedence over scaled dimensions.

Contractor, sub-contractor or supplier shall immediately advise the architect / quantity surveyor of the effect upon programme and cost of any alterations to the proposed works shown on this drawing.

All materials, components and workmanship to comply with the relevant British Standarts, Codes of Practice and appropriate manufacturers' recommendations that from time to time shall apply.

This drawing superseeds all previous issues of the same drawing number with earlier revisions.

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REV	DATE	Initials	REVISION	PROJECT
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Conversion of Ground and Lower Ground Floors	A	ARCHITECT	URE	Planning
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12 Platt's Lane, NW3 7NR	Α			
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DRAWING TITLE Existing Elevations as approved									
Bins storage details									
SCALE 1:100	DATE 04/06/2021	DRAWN MSS	CHECKED YS	PF					

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