




PER-EXISTING Front Elevation



EXISTING Front Elevation

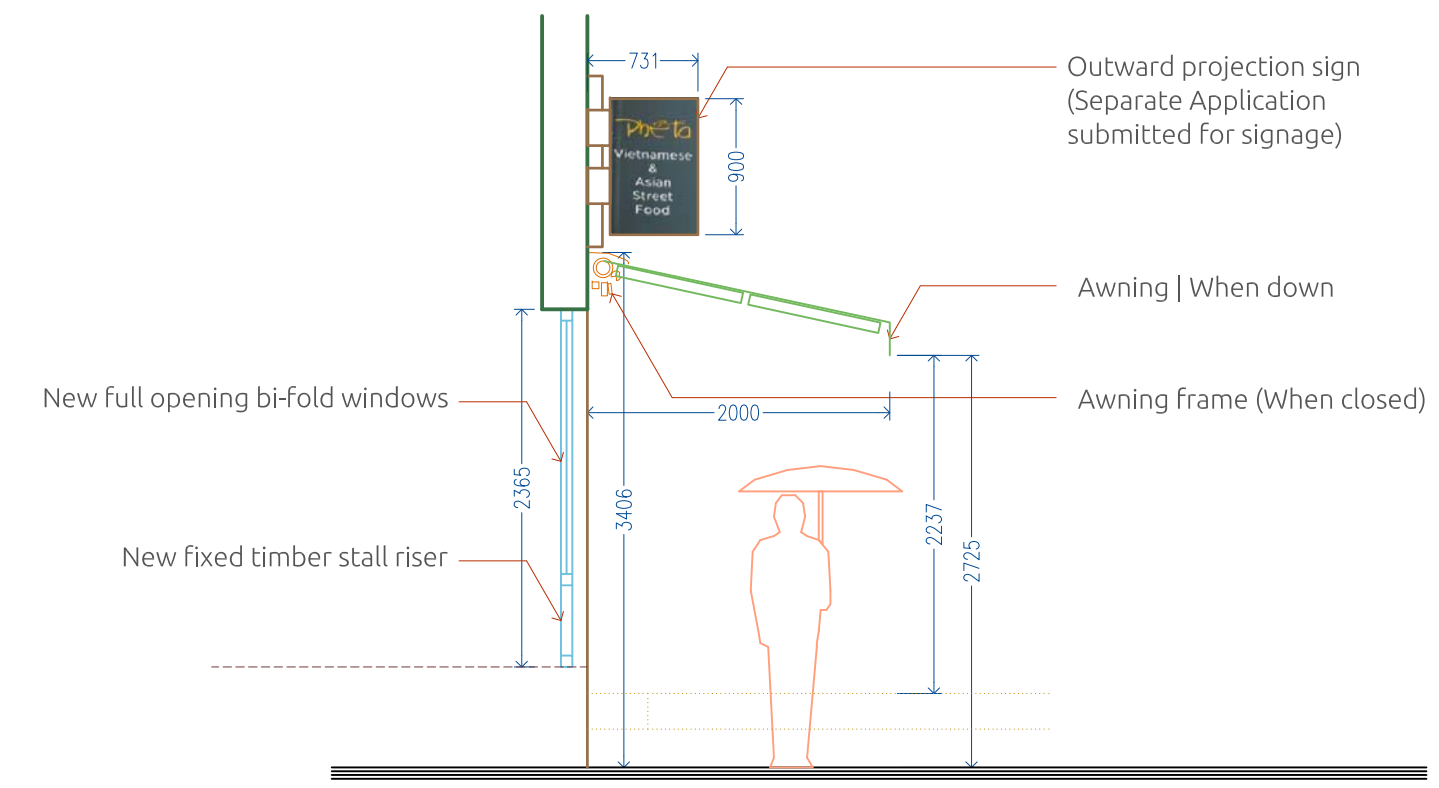

PROPOSED Side Elevation

Scale : 1:150



PER-EXISTING Front Elevation

Scale : 1:150



EXISTING Front Elevation

Scale : 1:150



PROPOSED Front Elevation

Scale : 1:150

0 0.5 1.0 1.5 2.0 2.5 5.0 Meters

Notes



1 | Do not scale from this drawing. Use figured dimensions only. The contractor is requested to check all dimensions before the work is put in hand.

2 | Read in conjunction with all other Architect's and structural engineer's drawings.

3 | Report any discrepancies to the contract administrator before undertaking the work described in the drawings.

4 | Dimensions are approximate site dimensions and are to be verified by the contractor on site before any fabrication / site works occur.

5 | Contractor is responsible for all temporary propping to existing structure.

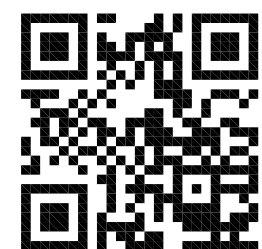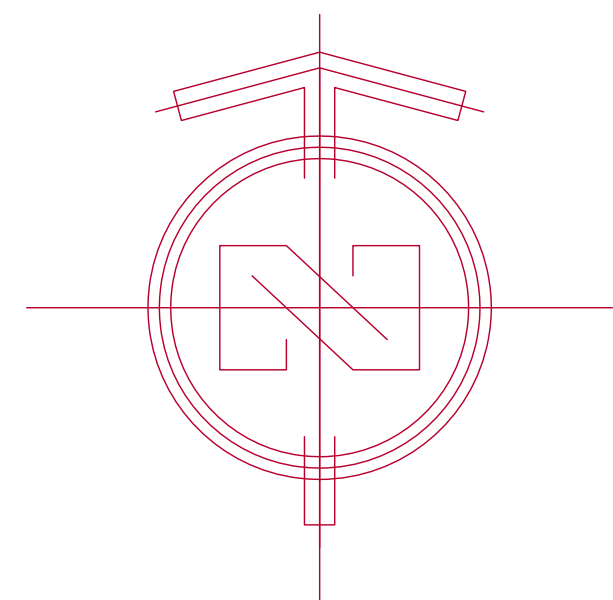

Project :	2	Designed By :	Aa. H.	Date :	16 - MAY - 2021
Location:	CANFIELD GARDENS	Drawn By :	Co. A.	Revision Number :	07
Ordered By :	N. A. L. D.	Checked By :	Aa. H.	Drawing Title :	Elevations
Project Number :	2,0,0,9,3,7	Approved By :	An. H.	DWG No :	AR - 011
		Field :	Architecture		
		Scale :	1 50 @ A0		