






Clarifications of the Roof Plant Screen Proposal

To be read in conjunction with application ref: 2021/0880/P submitted for the discharge of part (c) of Planning Condition 3 –
Detailed Drawings / Materials of Planning Permission ref: 2018/0663/P.


Drawings included:

- 01. Plant screen location plan  
- 02. Plant screen height 
- 03. Plant screen details  

01 Plant Screen Location

- The proposed roof plant screen is in the same location as shown on the planning drawings A-0211-PL Rev A and A-0301-PL Rev C submitted under 2019/3232/P and approved on 12 September, 2019.
- The screen is set back from the edge of the roof on Drummond street by 2.3m to minimise its visual impact.
- The residential plant does not have a dedicated screen due to the plant being much smaller in scale and of low profile.
- The roof balustrade has been designed to offer a degree of screening and will help minimise the visual impact of the residential plant.

- The proposed roof plant screen is in the same location as shown on the planning drawings A-0211-PL Rev A and A-0301-PL Rev C submitted under 2019/3232/P and approved on 12 September, 2019.
- The screen is set back from the edge of the roof on Drummond street by 2.3m to minimise its visual impact.
- The residential plant does not have a dedicated screen due to the plant being much smaller in scale and of low profile.
- The roof balustrade has been designed to offer a degree of screening and will help minimise the visual impact of the residential plant.

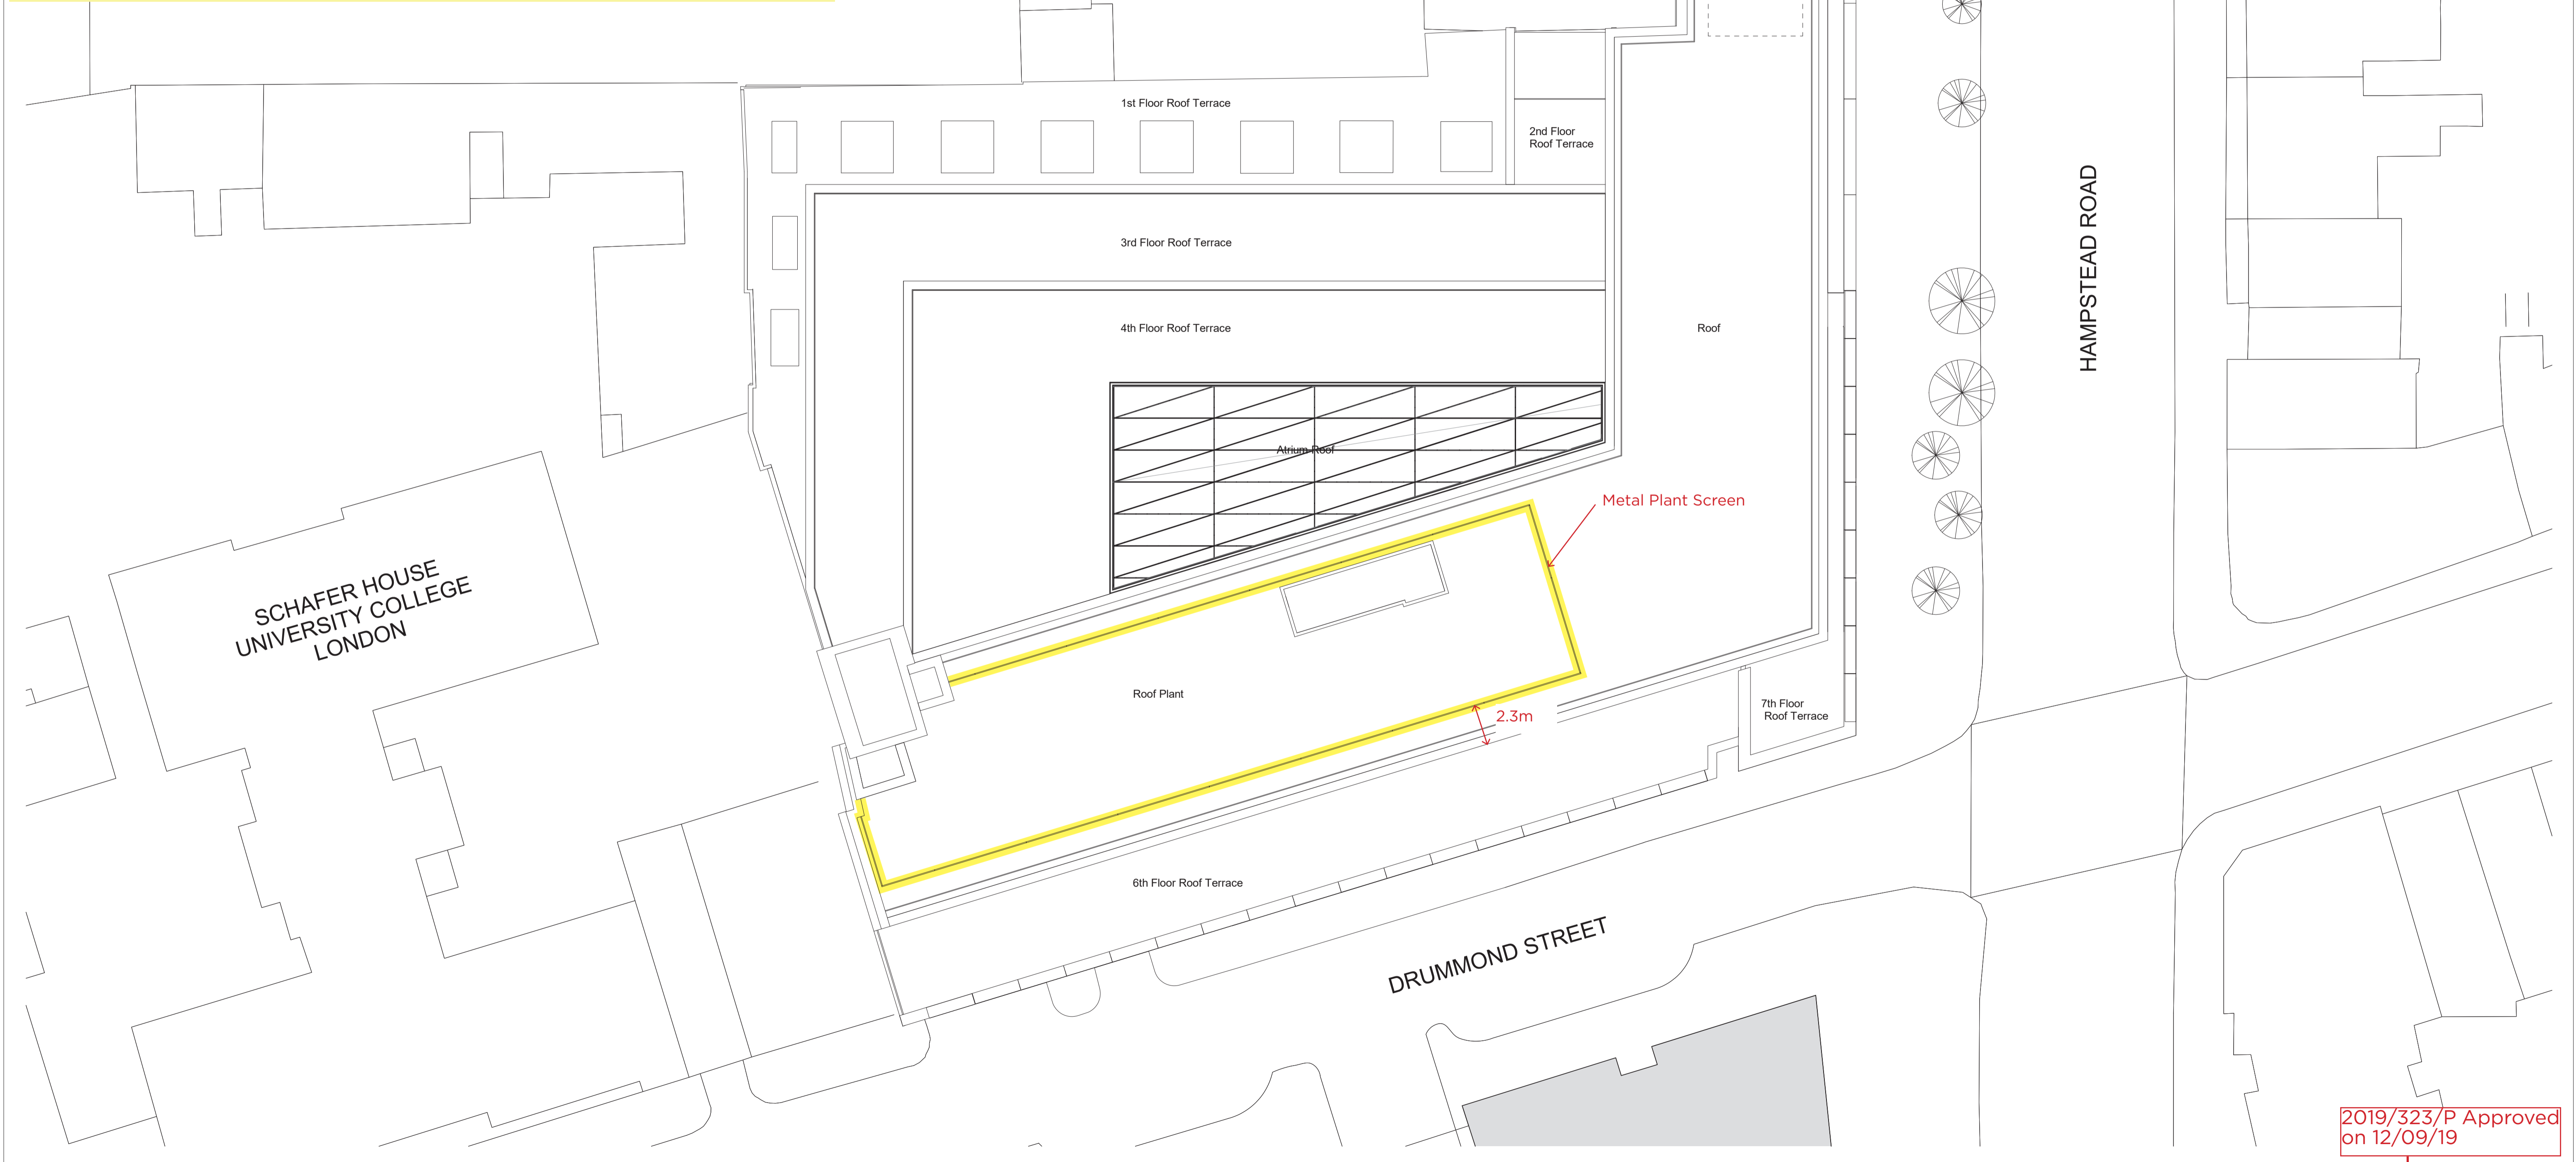


2019/323/P Approved on 12/09/19

NOTES FOR ALL DRAWINGS:
 This drawing is to be read in conjunction with the contract documents and all other consultants' drawings, specifications and schedules, including but not limited to the structural engineer's drawings, specifications and schedules for all structural design, sizes and performance criteria. This drawing shows the design intent only. This is not a fabrication drawing.
 Do not scale from this drawing. All dimensions, including setting out dimensions, and all levels shown are to be checked and verified by the contractor on site and are subject to a site survey. Any discrepancies found in this drawing, or between what is shown on the drawings and conditions found after opening up of the existing works, are to be reported to the Architect immediately, and in accordance with the provisions of the building contract. Any modifications or due to unforeseen conditions related to the existing structure or fabric, shall be agreed in writing with the Architect and issued for approval in accordance with the provisions of the building contract.
 Marks Barfield architects has prepared this drawing using information derived from a survey prepared by Lane & Frankham dated 28 March 2017, upon which it is entitled to rely. Marks Barfield Architects accepts no liability for the survey information nor does it warrant that information shown on the drawing related to the existing structure and fabric is either accurate or complete.
 © Marks Barfield Architects 2019

| Rev | Date | by | Description |
|-----|------------|----|---|
| A | 06/09/2019 | YZ | Updated to reflect changes to boundary wall on Drummond Street and updated atrium stair to reflect current design |
| | | | |
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Key


1

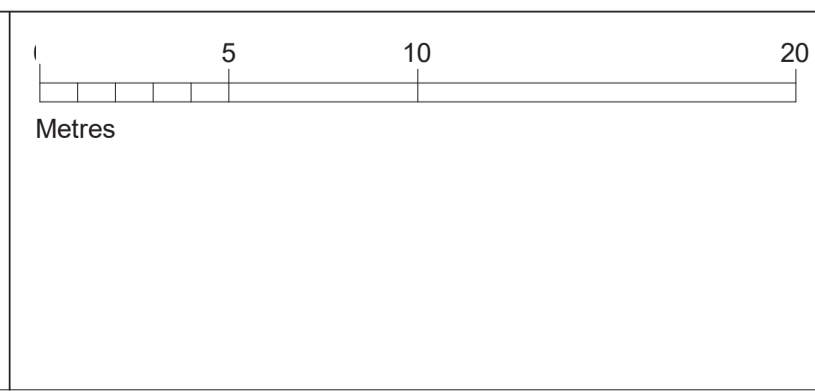

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| | | | | |
|---|-------------------------|-------------------------|---------------|--------------------|
| Stephenson House | | | | |
| Drawing Title Proposed Roof General Arrangement Plan | | | | |
| Job no 601 | Scale (@ A1) 1 : 200 | Drawing No A-0211-PL | Revision A | Status Planning |
| Date 02/06/17 | Checked YB | | | |




2019/323/P Approved on 12/09/19

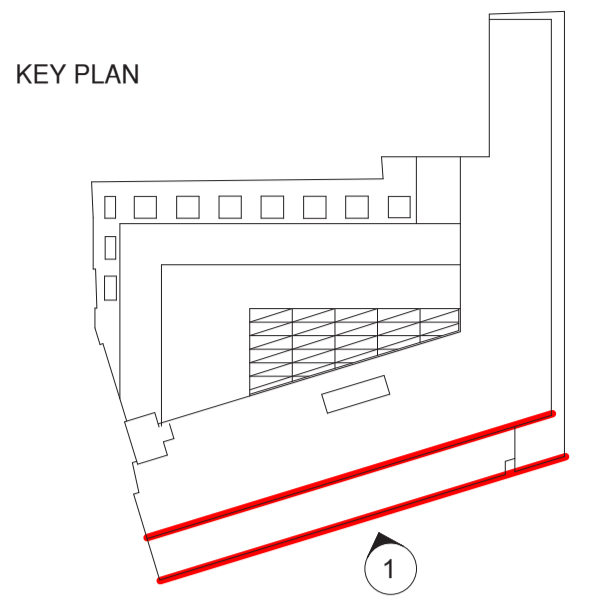NOTES FOR ALL DRAWINGS:
This drawing is to be read in conjunction with the contract documents, including but not limited to all other drawings, specifications and schedules. This drawing shows the design intent only. This is not a fabrication drawing. Do not scale from this drawing. All setting out dimensions shown are to be checked and verified by the contractor on site. All dimensions and levels are subject to a site survey. Any discrepancies found in this drawing are to be reported to the Architect immediately. Any modifications to these drawings necessary to meet the performance criteria of the specification shall be agreed in writing with the Architect and issued for approval. Please refer to structural engineer's drawings, specifications and schedules for all structural design, sizes and performance criteria. © Marks Barfield Architects 2019

| Rev | Date | by | Description |
|-----|------------|----|--|
| A | 19/12/2017 | JT | Updated to reflect Technical Design |
| B | 16/01/2018 | JT | Updated to reflect Technical Design |
| C | 30/05/2019 | CK | Updated due to existing western boundary wall being retained |

| Key | Description |
|-----|---|
| 1 | Pre-fabricated brick panel |
| 2 | Pre-fabricated masonry panel |
| 3 | Low iron glazing in bronze anodised aluminium frame |
| 4 | Glazed feature 'lantern' |
| 5 | Low iron frameless atrium glazing |
| 6 | Ventilated spandrel panel |
| 7 | Spandrel panel |
| 8 | Bronze anodised aluminium |
| 9 | Bespoke metal gate and louvres |
| 10 | Bespoke PPC metal balustrade |
| 11 | Glazed balustrade |
| 12 | Metal Plant Screen |

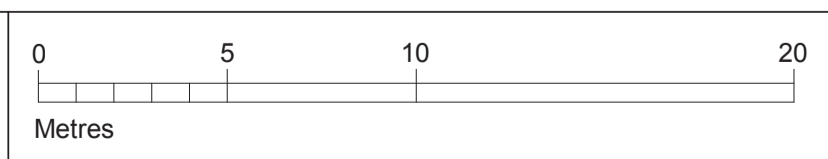

2

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Architect
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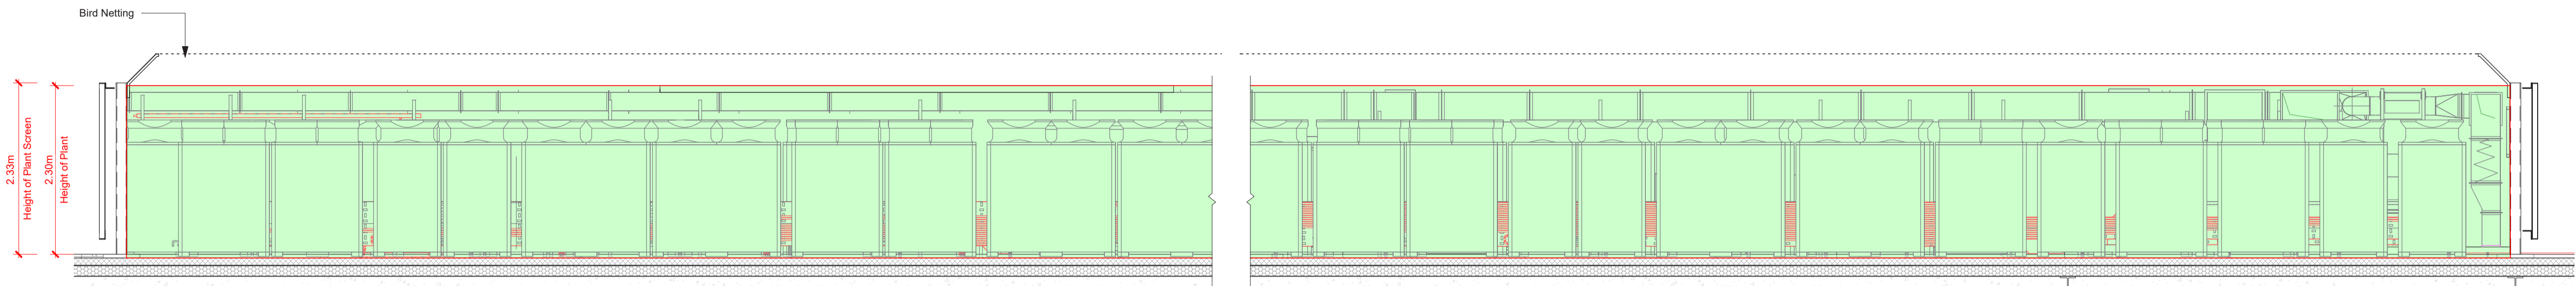
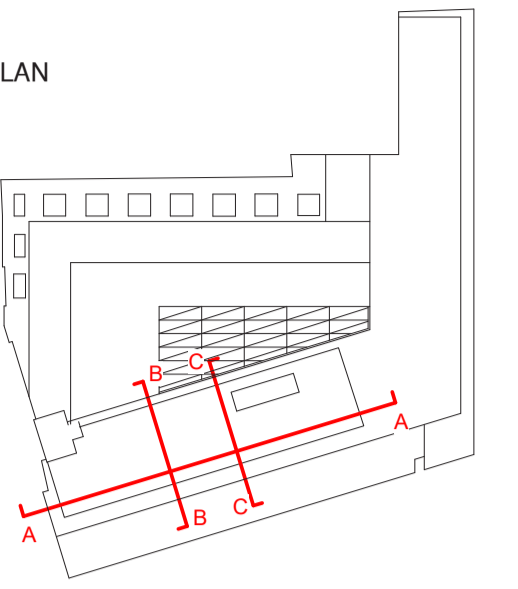
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| Stephenson House | | | | |
|--|--------------|------------|----------|----------|
| Drawing Title | | | | |
| Proposed South Elevation (Drummond Street) | | | | |
| Job no | Scale (@ A1) | Drawing No | Revision | Status |
| 601 | 1 : 200 | A-0301-PL | C | Planning |
| Date | Checked | | | |
| 02/06/17 | YB | | | |


02 Plant screen height

- The extent of the screen is no greater than the commercial plant area it encloses.
- The height of the screen is no greater than the plant it encloses.
- The screen is 2.33m high as measured from the finished roof.


KEY PLAN



1 Roof Section A
SCALE 1 : 50

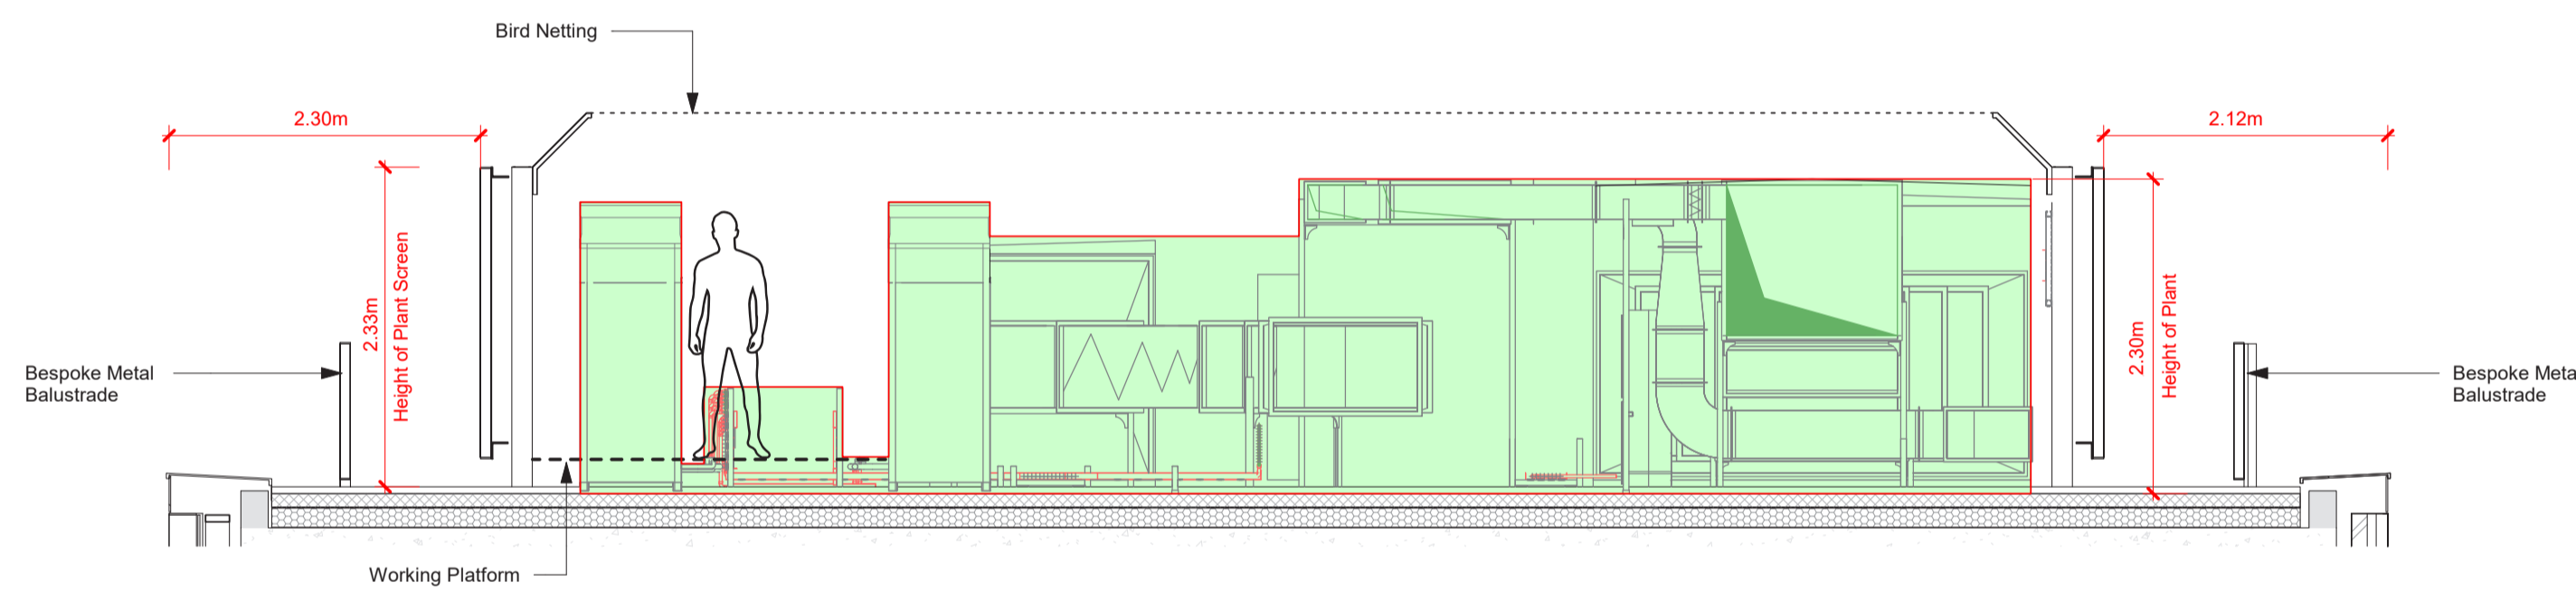

2 Roof Section B
SCALE 1 : 50

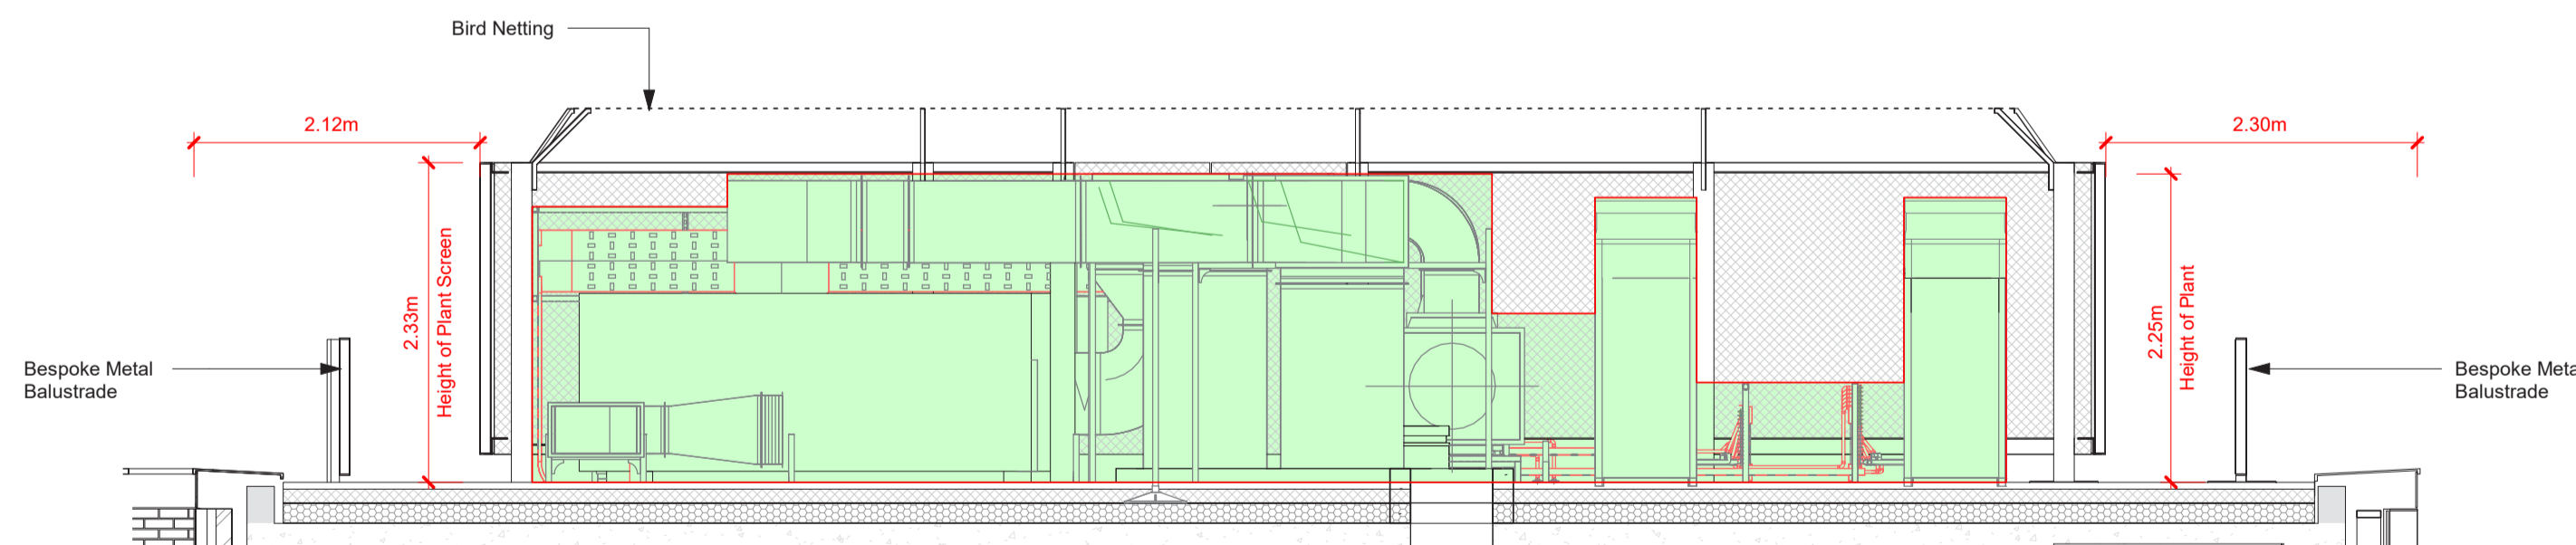

3 Roof Section C
SCALE 1 : 50

- The extent of the screen is no greater than the commercial plant area it encloses.
- The height of the screen is no greater than the plant it encloses.
- The screen is 2.33m high as measured from the finished roof.

NOTES FOR ALL DRAWINGS:

This drawing is to be read in conjunction with the contract documents, including but not limited to all other drawings, specifications and schedules. This drawing shows the design intent only. This is not a fabrication drawing. Do not scale from this drawing. All setting out dimensions shown are to be checked and verified by the contractor on site. All dimensions and levels are subject to a site survey. Any discrepancies found in this drawing are to be reported to the Architect immediately. Any modifications to these drawings necessary to meet the performance criteria of the specification shall be agreed in writing with the Architect and issued for approval. Please refer to structural engineer's drawings, specifications and schedules for all structural design, size and performance criteria.
© Marks Barfield Architects 2021

| Rev | Date | by | Description | Key |
|-----|------|----|-------------|-----|
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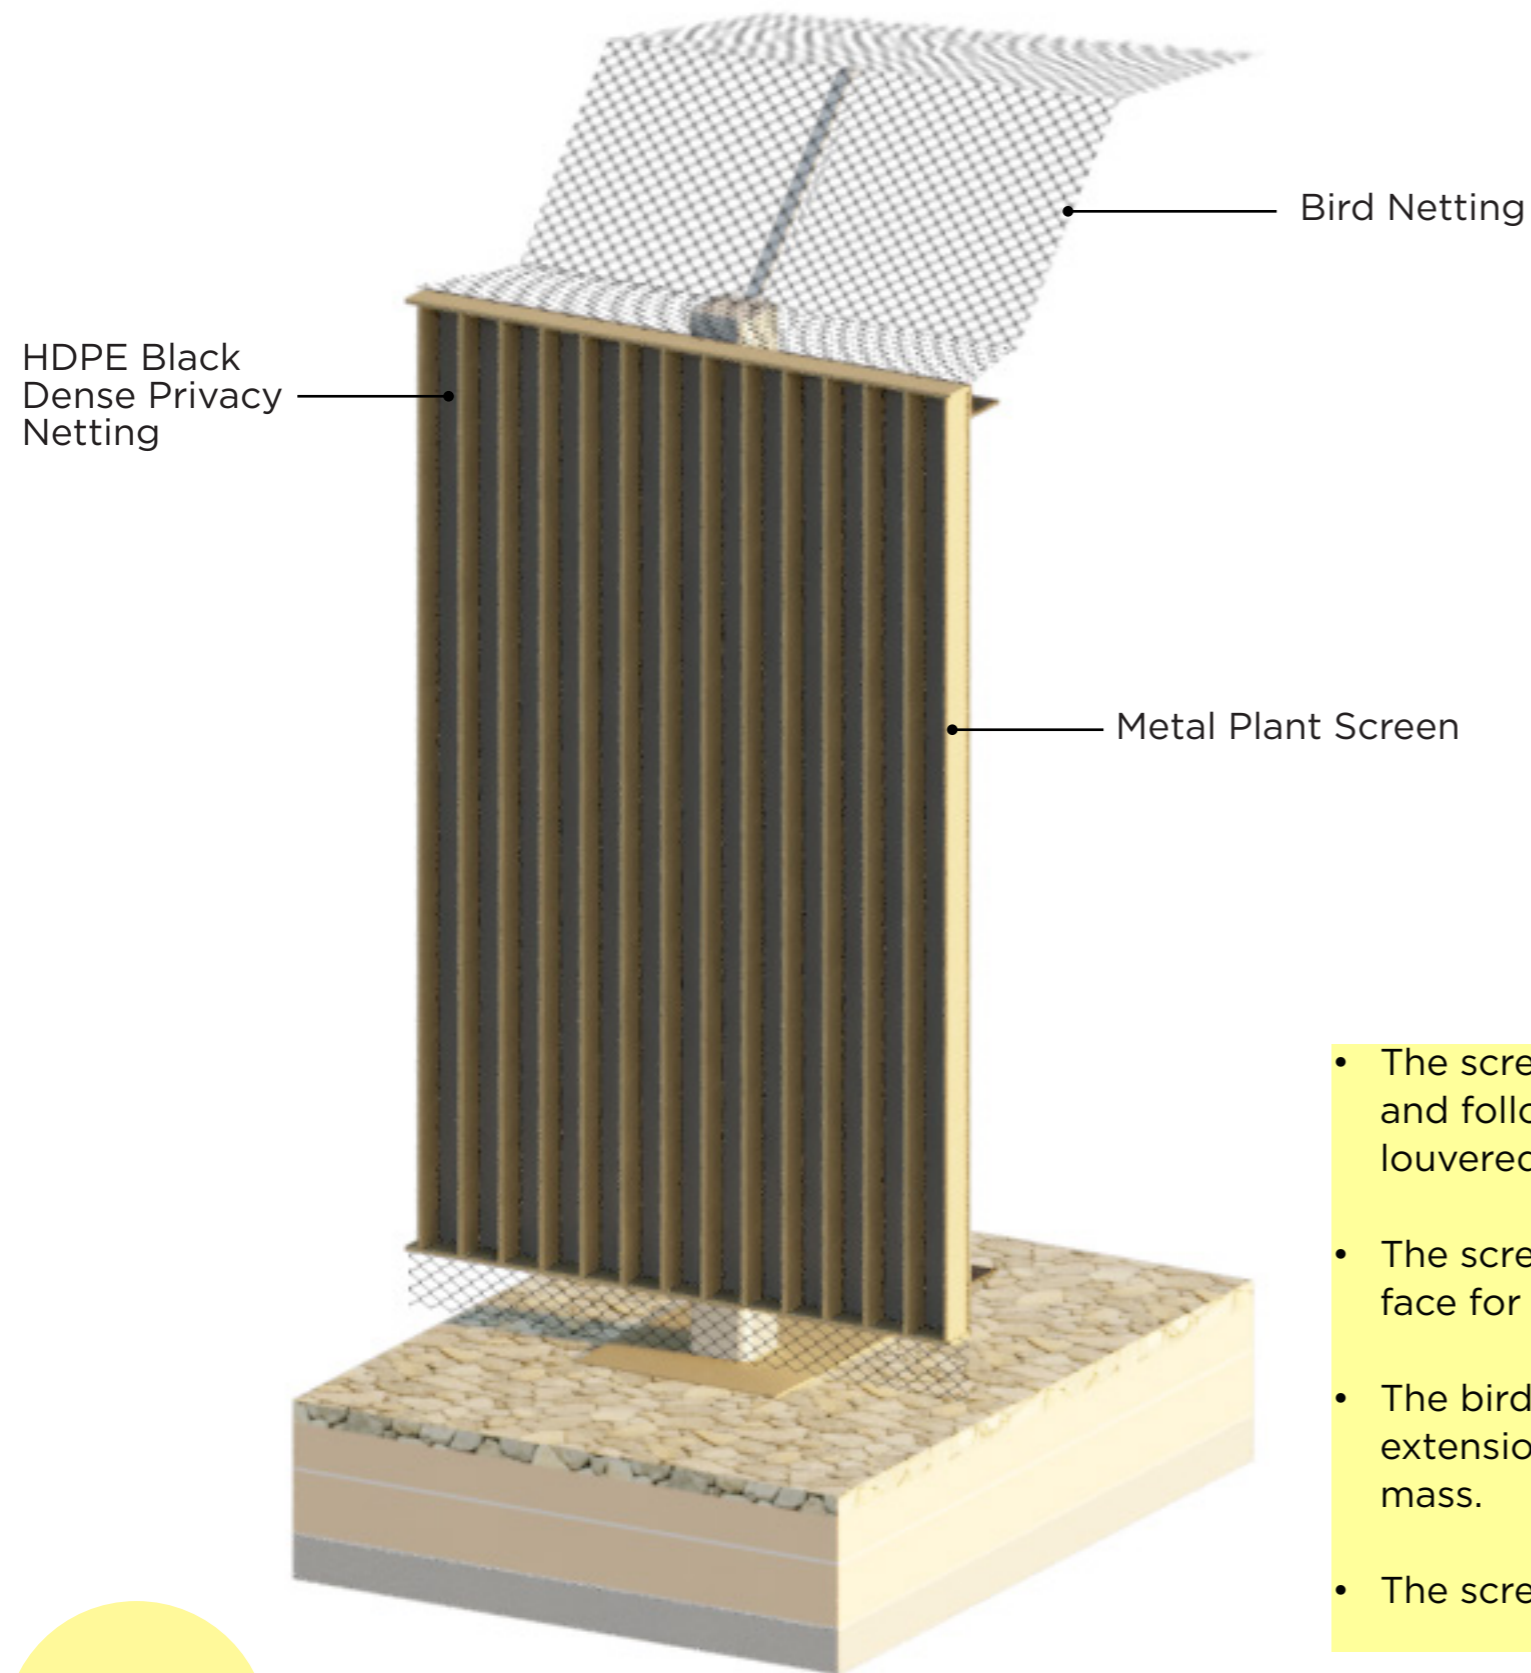
Architect
marks barfield architects

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Tel +44 20 7501 0180

| | | | | |
|--|-------------------------------|------------------------------|----------|-------------------------------|
| Stephenson House, 75 Hampstead Road, London, NW1 2PL | | | | |
| Drawing Title Plant Screen Height | | | | |
| Job no 601 | Scale (@ A1) 1 : 50 | Drawing No SK-1461 | Revision | Status Construction |
| Date 05/04/21 | Checked YB | | | |


03 Plant Screen Design

- The screen has been designed by Marks Barfield Architects specifically for this project and follows the design language already set by the balustrades. It is not a traditional louvered screen.
- The screen consists of 75mm wide vertical metal fins with black netting on the rear face for added privacy as can be seen in the submitted details, ref 0500.
- One of the unique design features of the screen is that it has no visible intermediate horizontal elements, only vertical fins. The corners of the screen are mitred to create continuity in the rhythm of the vertical fins.
- The bird netting that spans across the top of the screen is supported on splayed extension brackets which help reduce the height of the screen and minimise its visual mass.
- The screen needs to be open at the top to allow the plant equipment to ventilate.



Metal Plant Screen




Hot dipped galvanised, wet painted steel RAL 1035 Pearl Beige.

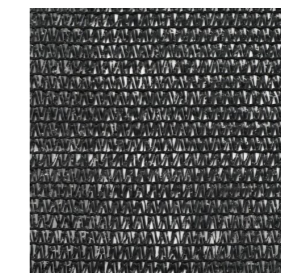

HDPE Black Dense Privacy Netting

HDPE black dense privacy netting afixed to the back of the screen

- The screen has been designed by Marks Barfield Architects specifically for this project and follows the design language already set by the balustrades. It is not a traditional louvered screen.
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- The bird netting that spans across the top of the screen is supported on splayed extension brackets which help reduce the height of the screen and minimise its visual mass.
- The screen needs to be open at the top to allow the plant equipment to ventilate.

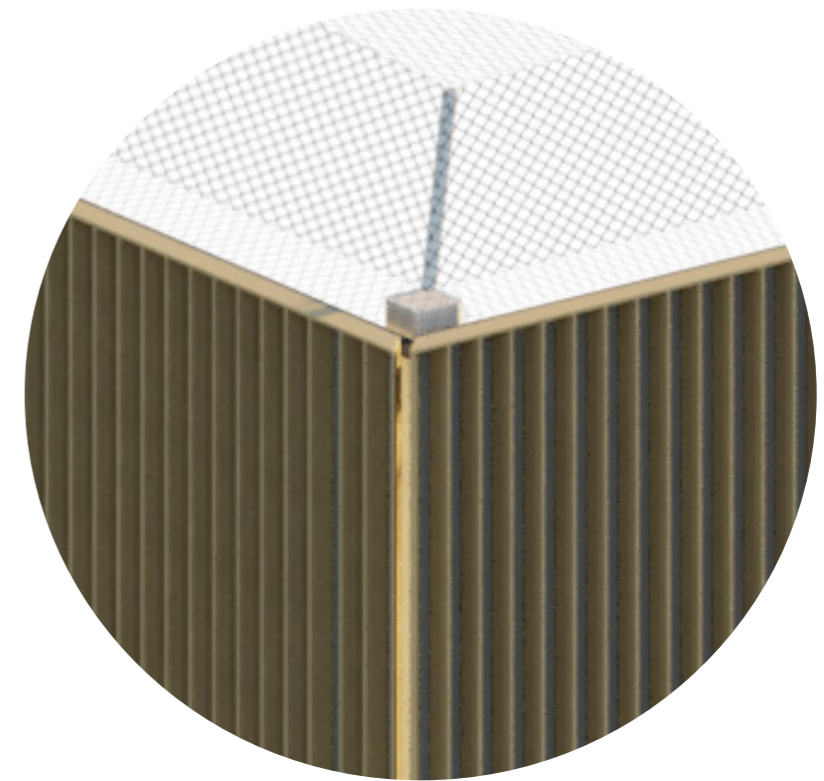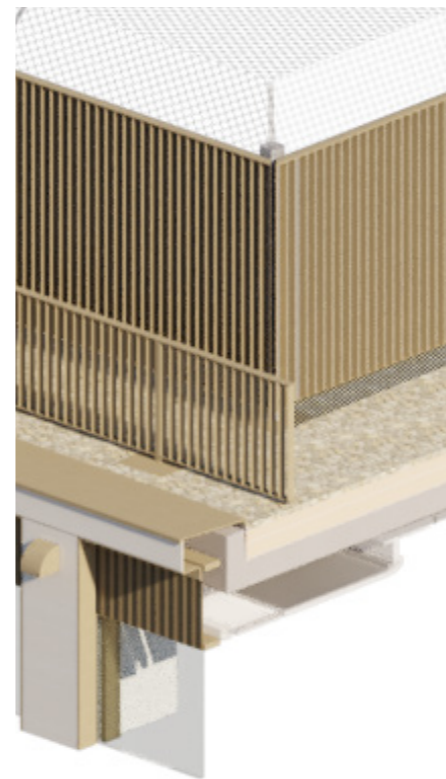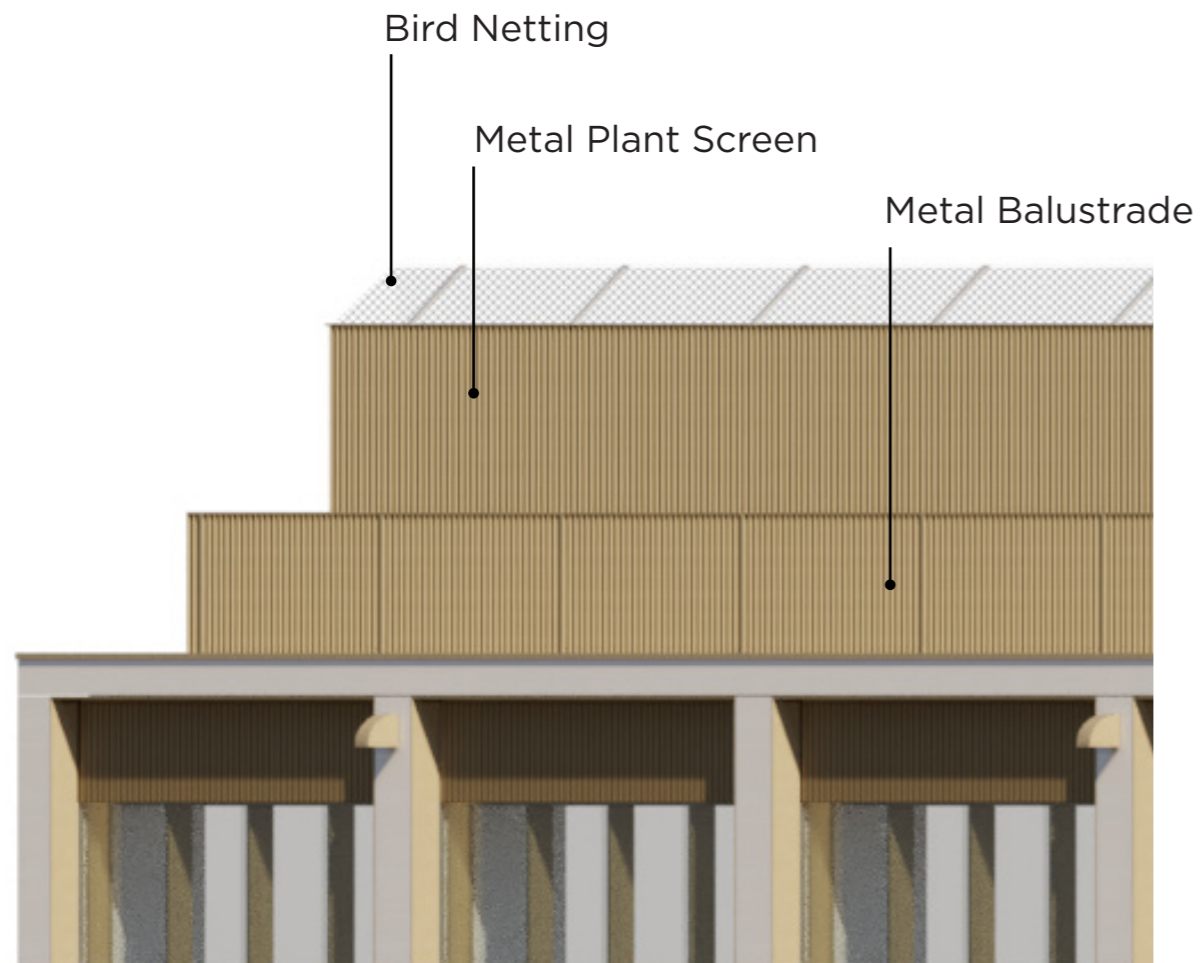

- One of the unique design features of the screen is that it has no visible intermediate horizontal elements, only vertical fins. The corners of the screen are mitred to create continuity in the rhythm of the vertical fins.

Metal Plant Screen

Metal Balustrade

