



GENERAL NOTES


- CHECK ALL DIMENSIONS ON SITE.
- ALL DIMENSIONS ARE IN MILLIMETRES UNLESS OTHERWISE STATED.
- ALL VERTICAL MEASUREMENTS ASSUME GROUND TO BE LEVEL UNLESS OTHERWISE STATED.
- THIS DRAWING SHOULD BE READ IN CONJUNCTION WITH THE GENERAL NOTES.
- WORKS TO BE CARRIED OUT WITH MATERIALS AND WORKMANSHIP IN COMPLIANCE WITH APPROVED DOCUMENT FOR REGULATION 7 (THE AMENDED BUILDING REGULATIONS 2010)
- WORKS TO BE CARRIED OUT IN A SAFE MANNER IN ACCORDANCE WITH CDM REGULATIONS 2007.
- OPEN UP EXISTING STRUCTURE AS REQUIRED BY THE BUILDING INSPECTOR
- THIRD PARTY SUPPLIER TO MEASURE ON SITE BEFORE MANUFACTURING
- GENERAL CONTRACTOR TO VERIFY FIELD CONDITIONS PRIOR TO COMMENCEMENT OF EACH PORTION OF THE WORK.
- ANY DISCREPANCIES IN THESE DRAWINGS SHOULD BE NOTIFIED TO US PRIOR TO ANY WORKS PROCEEDING.
- UNLESS OTHERWISE INDICATED, PLAN DIMENSIONS ARE TO COLUMN GRID ON CENTERLINES, NOMINAL SURFACE OF MASONRY, FACE OF STUDS AND FACE OF CONCRETE WALLS AND BEAM CENTRE TO CENTRES.
- "FLOOR LINE" REFERS TO TOP OF CONCRETE SLABS. FINISH FLOORING IS INSTALLED ABOVE THE FLOOR LINE. FOR DEPRESSED FLOORS AND CURBS, SEE STRUCTURAL DRAWINGS.
- REPETITIVE FEATURES ARE NOT ALWAYS DRAWN IN THEIR ENTIRETY AND SHALL BE COMPLETELY PROVIDED AS IF DRAWN IN FULL.
- WHERE A DOOR IS LOCATED NEAR CORNER OF ROOM AND IS NOT LOCATED BY DIMENSION ON PLAN OR DETAILS, DIMENSION SHALL BE 100MM FROM FACE OF STUD (WALL).
- LINE OF EXISTING FLOOR SLABS, AS SHOWN ON THE BUILDING ELEVATIONS AND SECTIONS ARE APPROXIMATE.
- FLOOR LEVELS AND BOUNDARIES ASSUMED WHERE NOTED, DEPICTED BY LINE DASH LINES.
- REFER TO ARCHITECTURAL, STRUCTURAL, MECHANICAL, ELECTRICAL, GENERAL SPECIFICATION AND OTHER CATEGORIES OR DRAWINGS FOR ADDITIONAL NOTES.
- VERIFY SIZE/LOCATION/FINISH/FIRE-RATING, ETC. AND PROVIDE COMPLETE AND REQUIRED OPENINGS THROUGH FLOORS AND WALLS, ACCESS DOORS, FURRING, CURBS, ANCHORS & INSERTS.
- CONTRACTOR TO CARRY OUT MOST LOGICAL SOLUTION BUT TO CHECK WITH ARCHITECT OR ENGINEER IF UNSURE, REQUESTS BY CLIENTS THAT DEVIATE FROM DESIGN VOIDS THE DESIGN LIABILITY.
- SEE STRUCTURAL GENERAL NOTES AND PLANS TO COMPLEMENT ARCHITECTURAL PLANS AT ALL TIMES, DO NOT ASSUME ANYTHING.

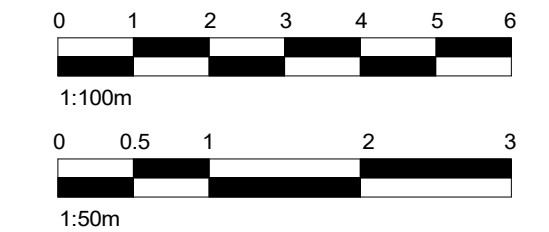


1 Proposed Front Elevation
1 : 100

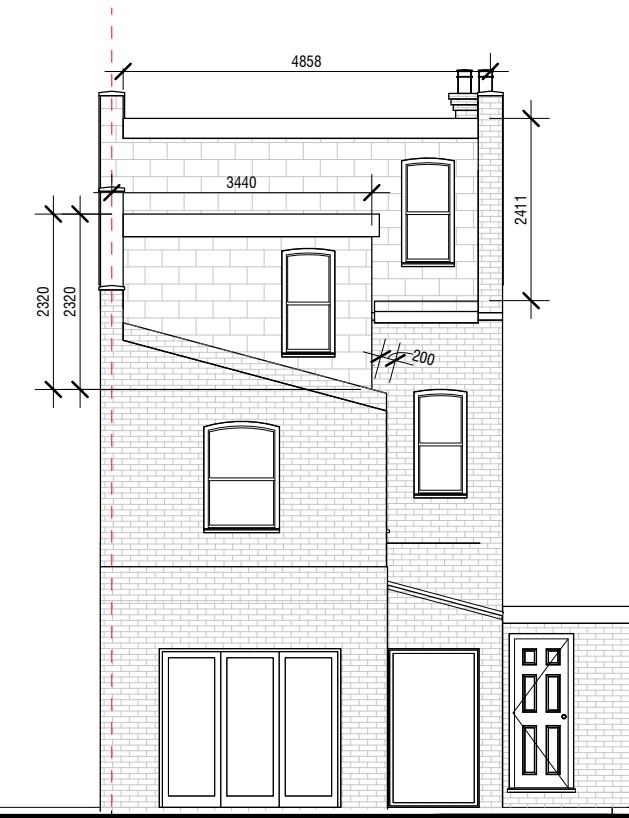


3 Proposed Rear Elevation
1 : 100

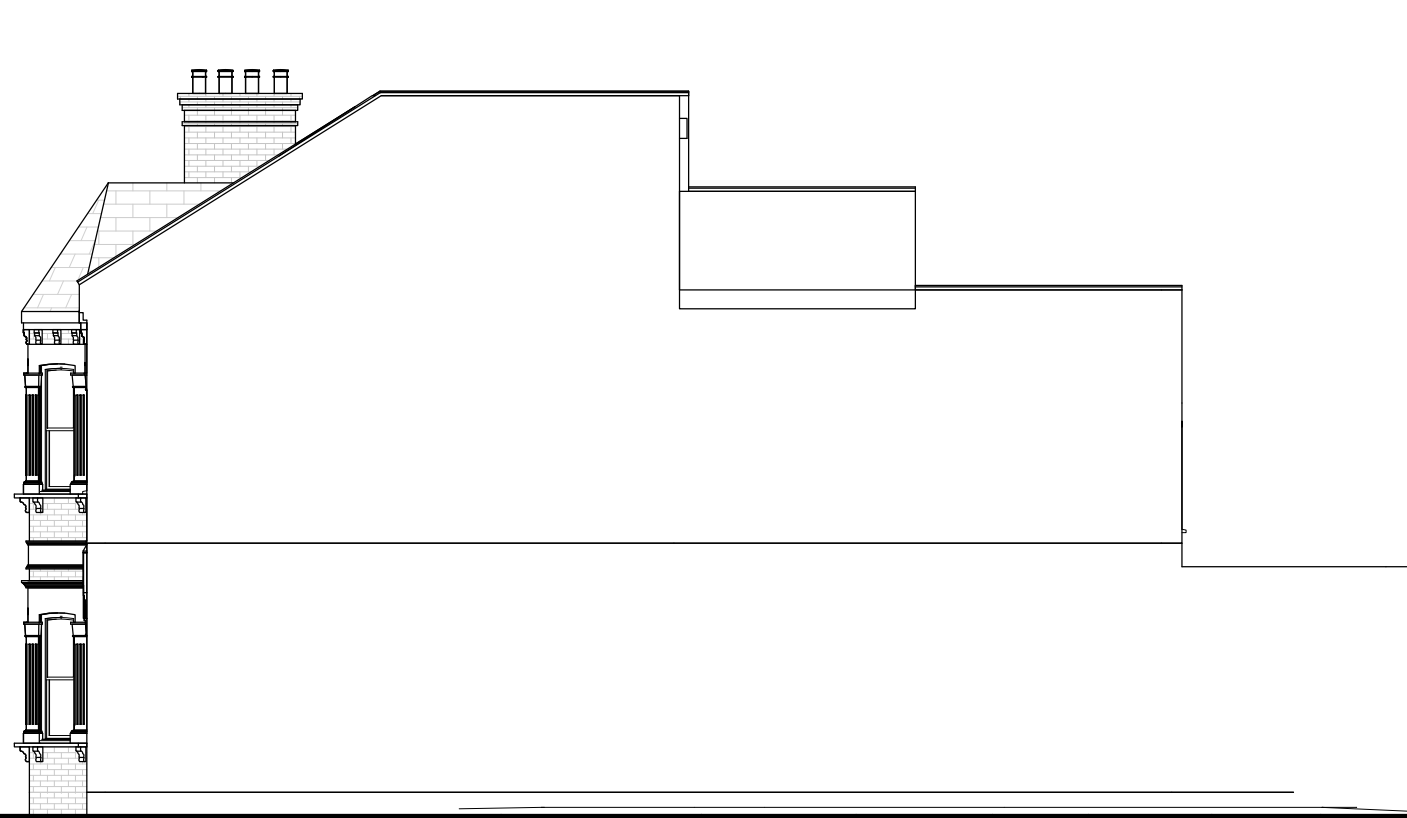



2 Proposed Right Side Elevation
1 : 100

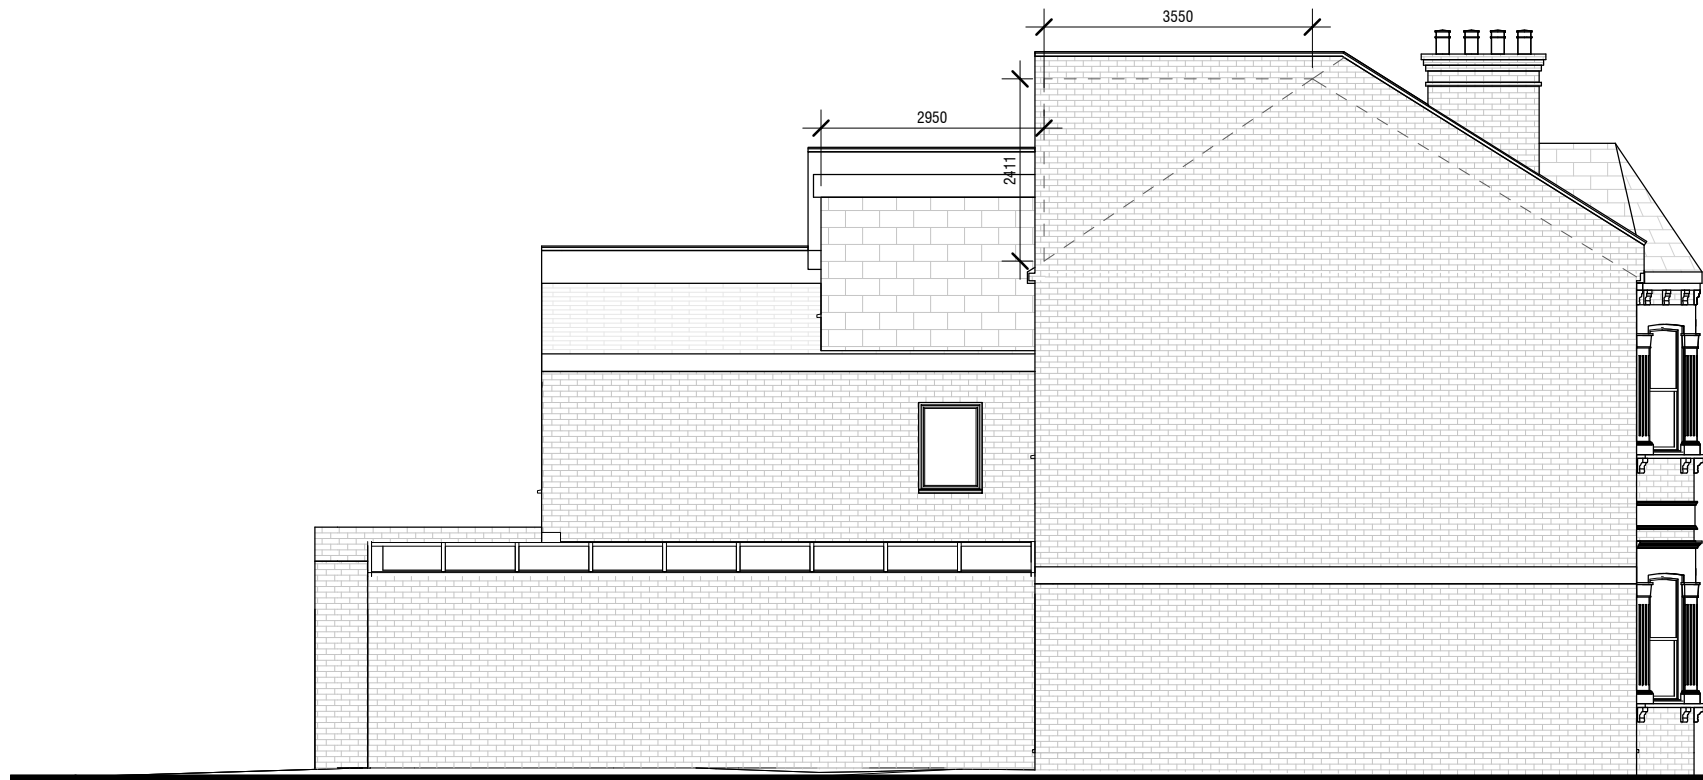

4 Proposed Left Side Elevation
1 : 100

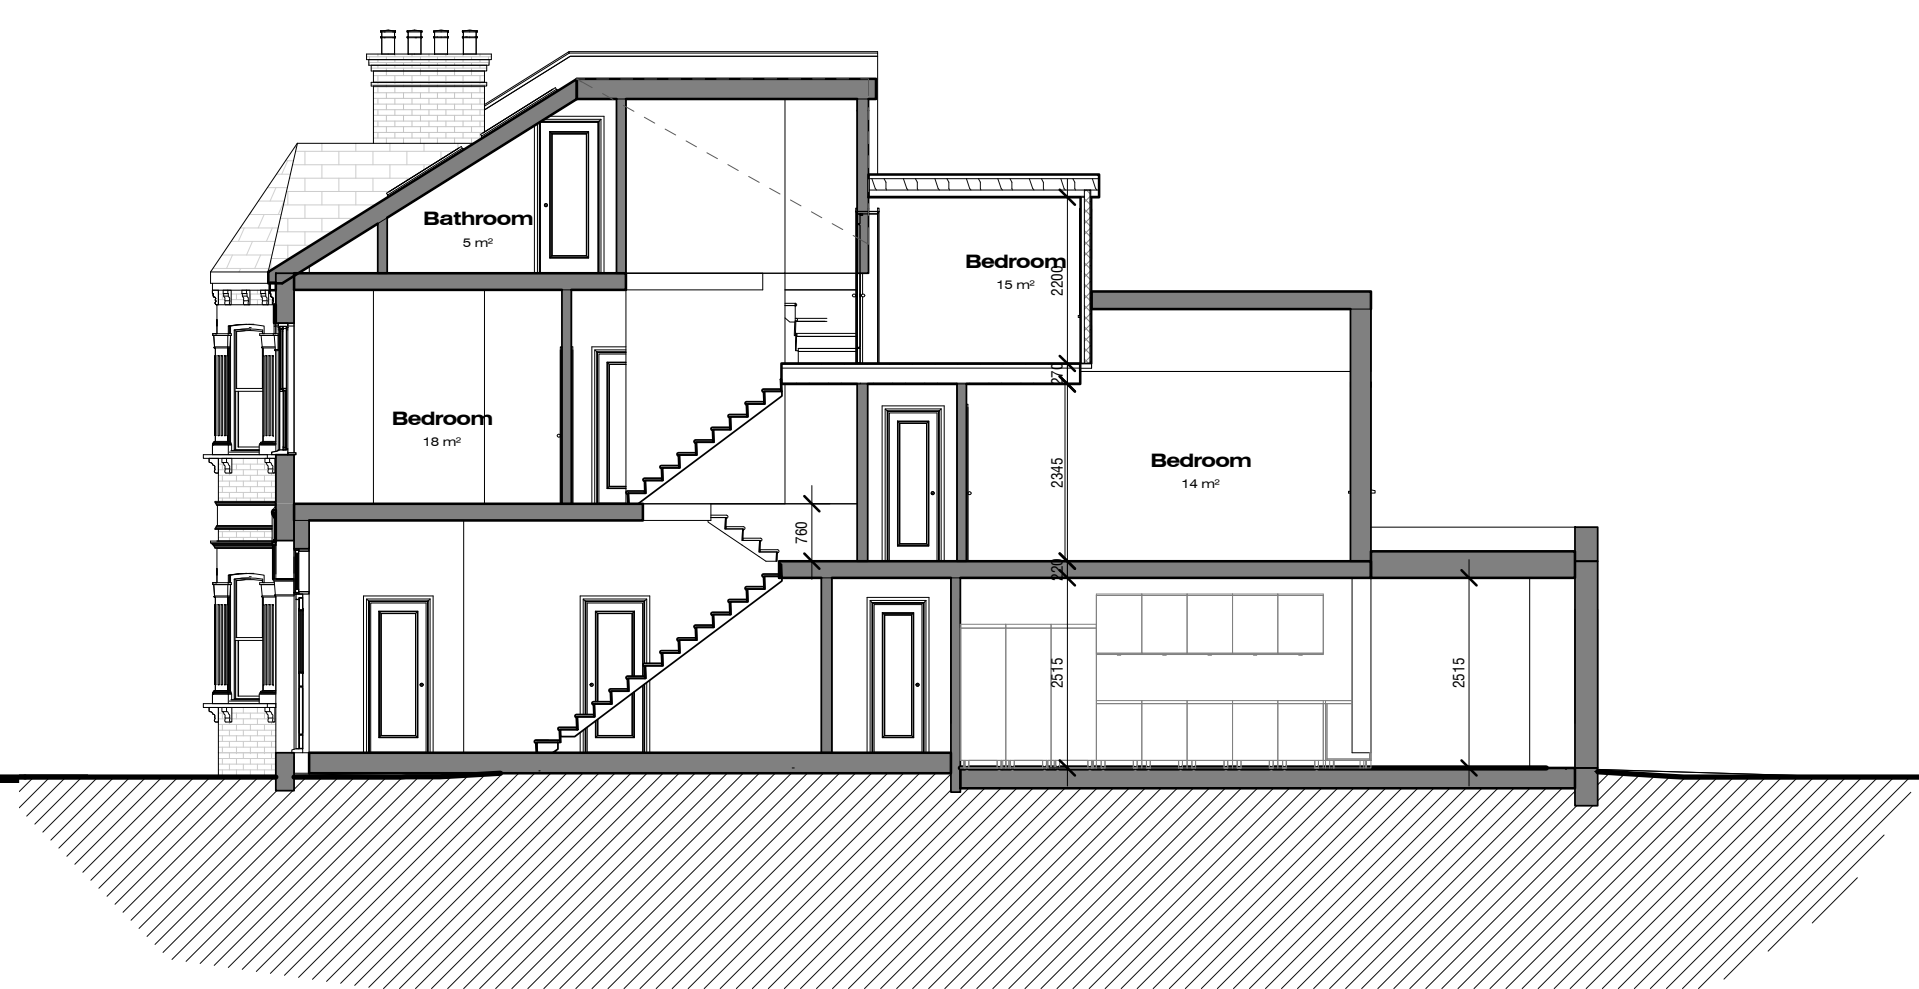

5 Section Proposed
1 : 100

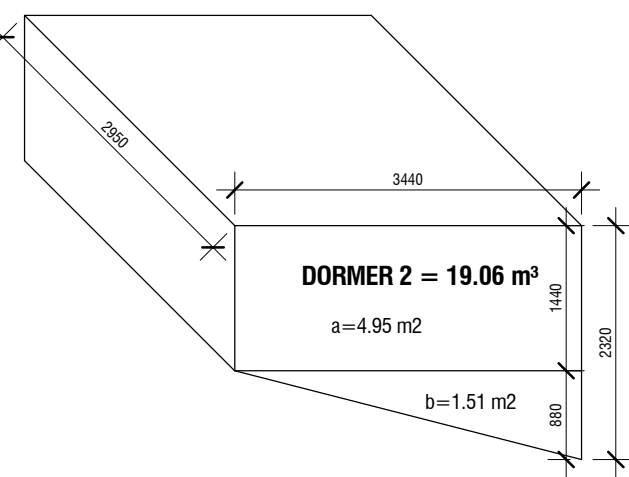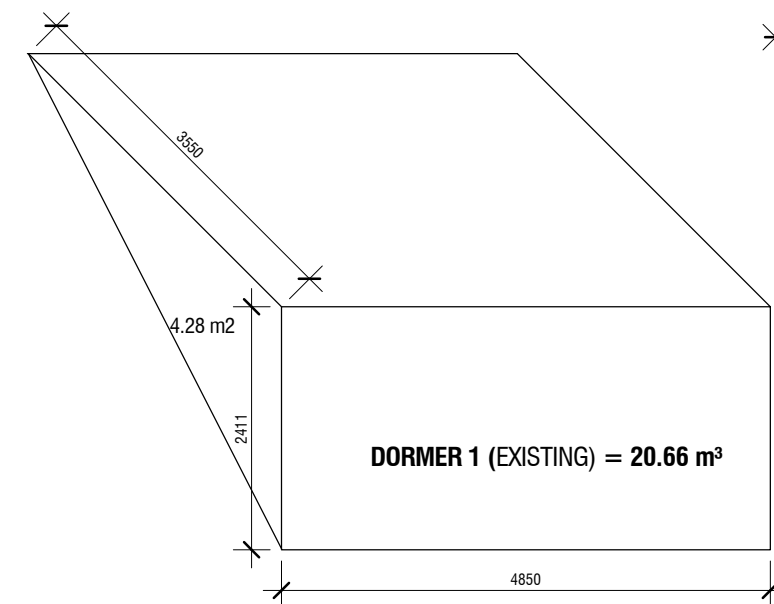


DORMER 2
a = 1.44 m (height) x 3.44 m (depth) = 4.95 m²
b = 0.88 m (height) x 3.44 m (depth) / 2 = 1.51 m²

4.95 m² + 1.51 m² (a+b) = 6.46 m²
6.46 m² x 2.95 m (Dormer Length) = 19.06 m³


DORMER TOTAL VOLUME: 39.82 m³

DORMER 1 (Existing)
2.411 m (Dormer Height) x 3.55 m (Dormer Depth) / 2 = 4.28 m²
4.28 m² x 4.85 m (Dormer Length) = 20.76 m³

6 Roof Volume
1 : 75

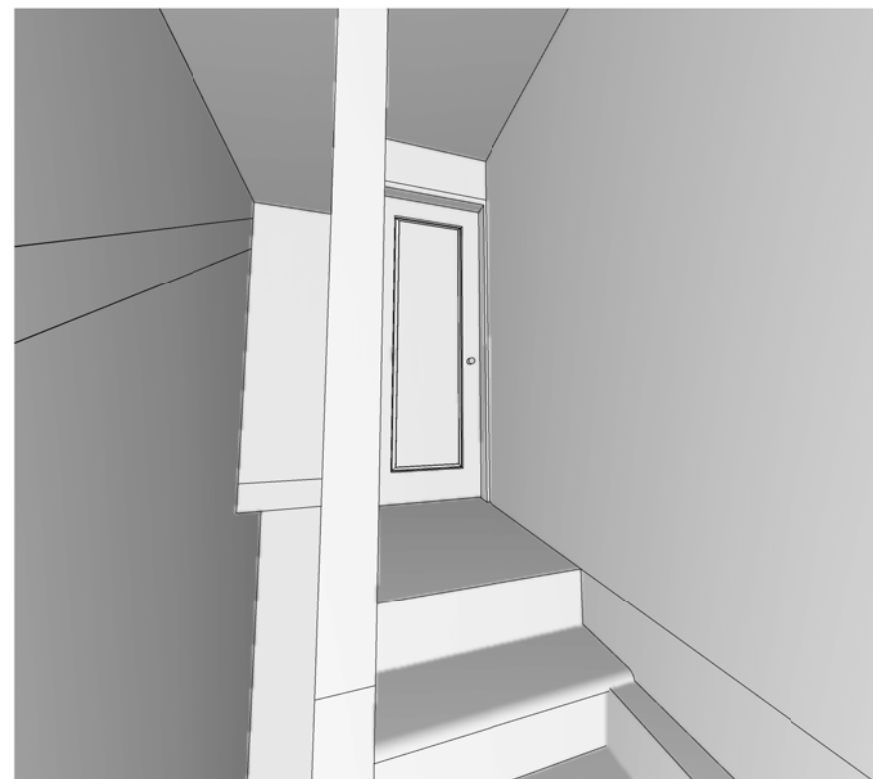

VIEW TO NEW LOFT ENTRY

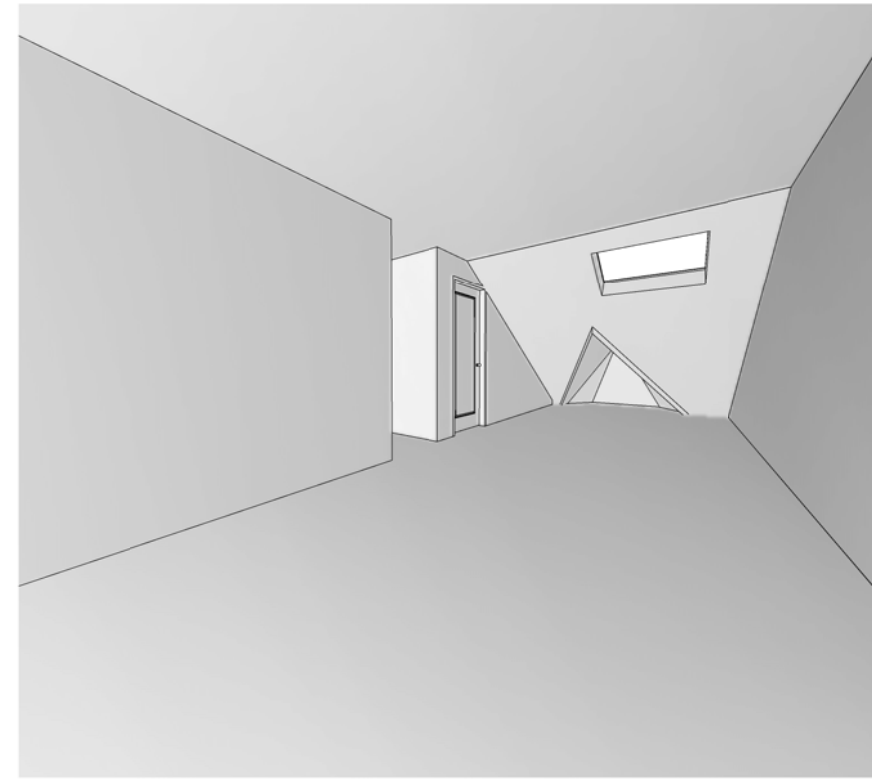

VIEW TO MAIN LOFT

No.:	Revision:	Date:
BISCHELL THE DESIGN & BUILD COMPANY		
Bischell - Design & Build - Suite 114 80 Cumberland House, Scrubs Lane Hammersmith & Fulham, NW106RF www.bischell.co.uk		
Client: David Jones 72 Solent Road, West Hampstead NW6 1TX		
Drawing Title: Proposed Elevations		
Status: BR		
Scale: As indicated @A2	Date: 22-03-2020	Drawn By: S.VEN
Drawing No.: PN-008		Rev: