



DETAIL A  
1:20

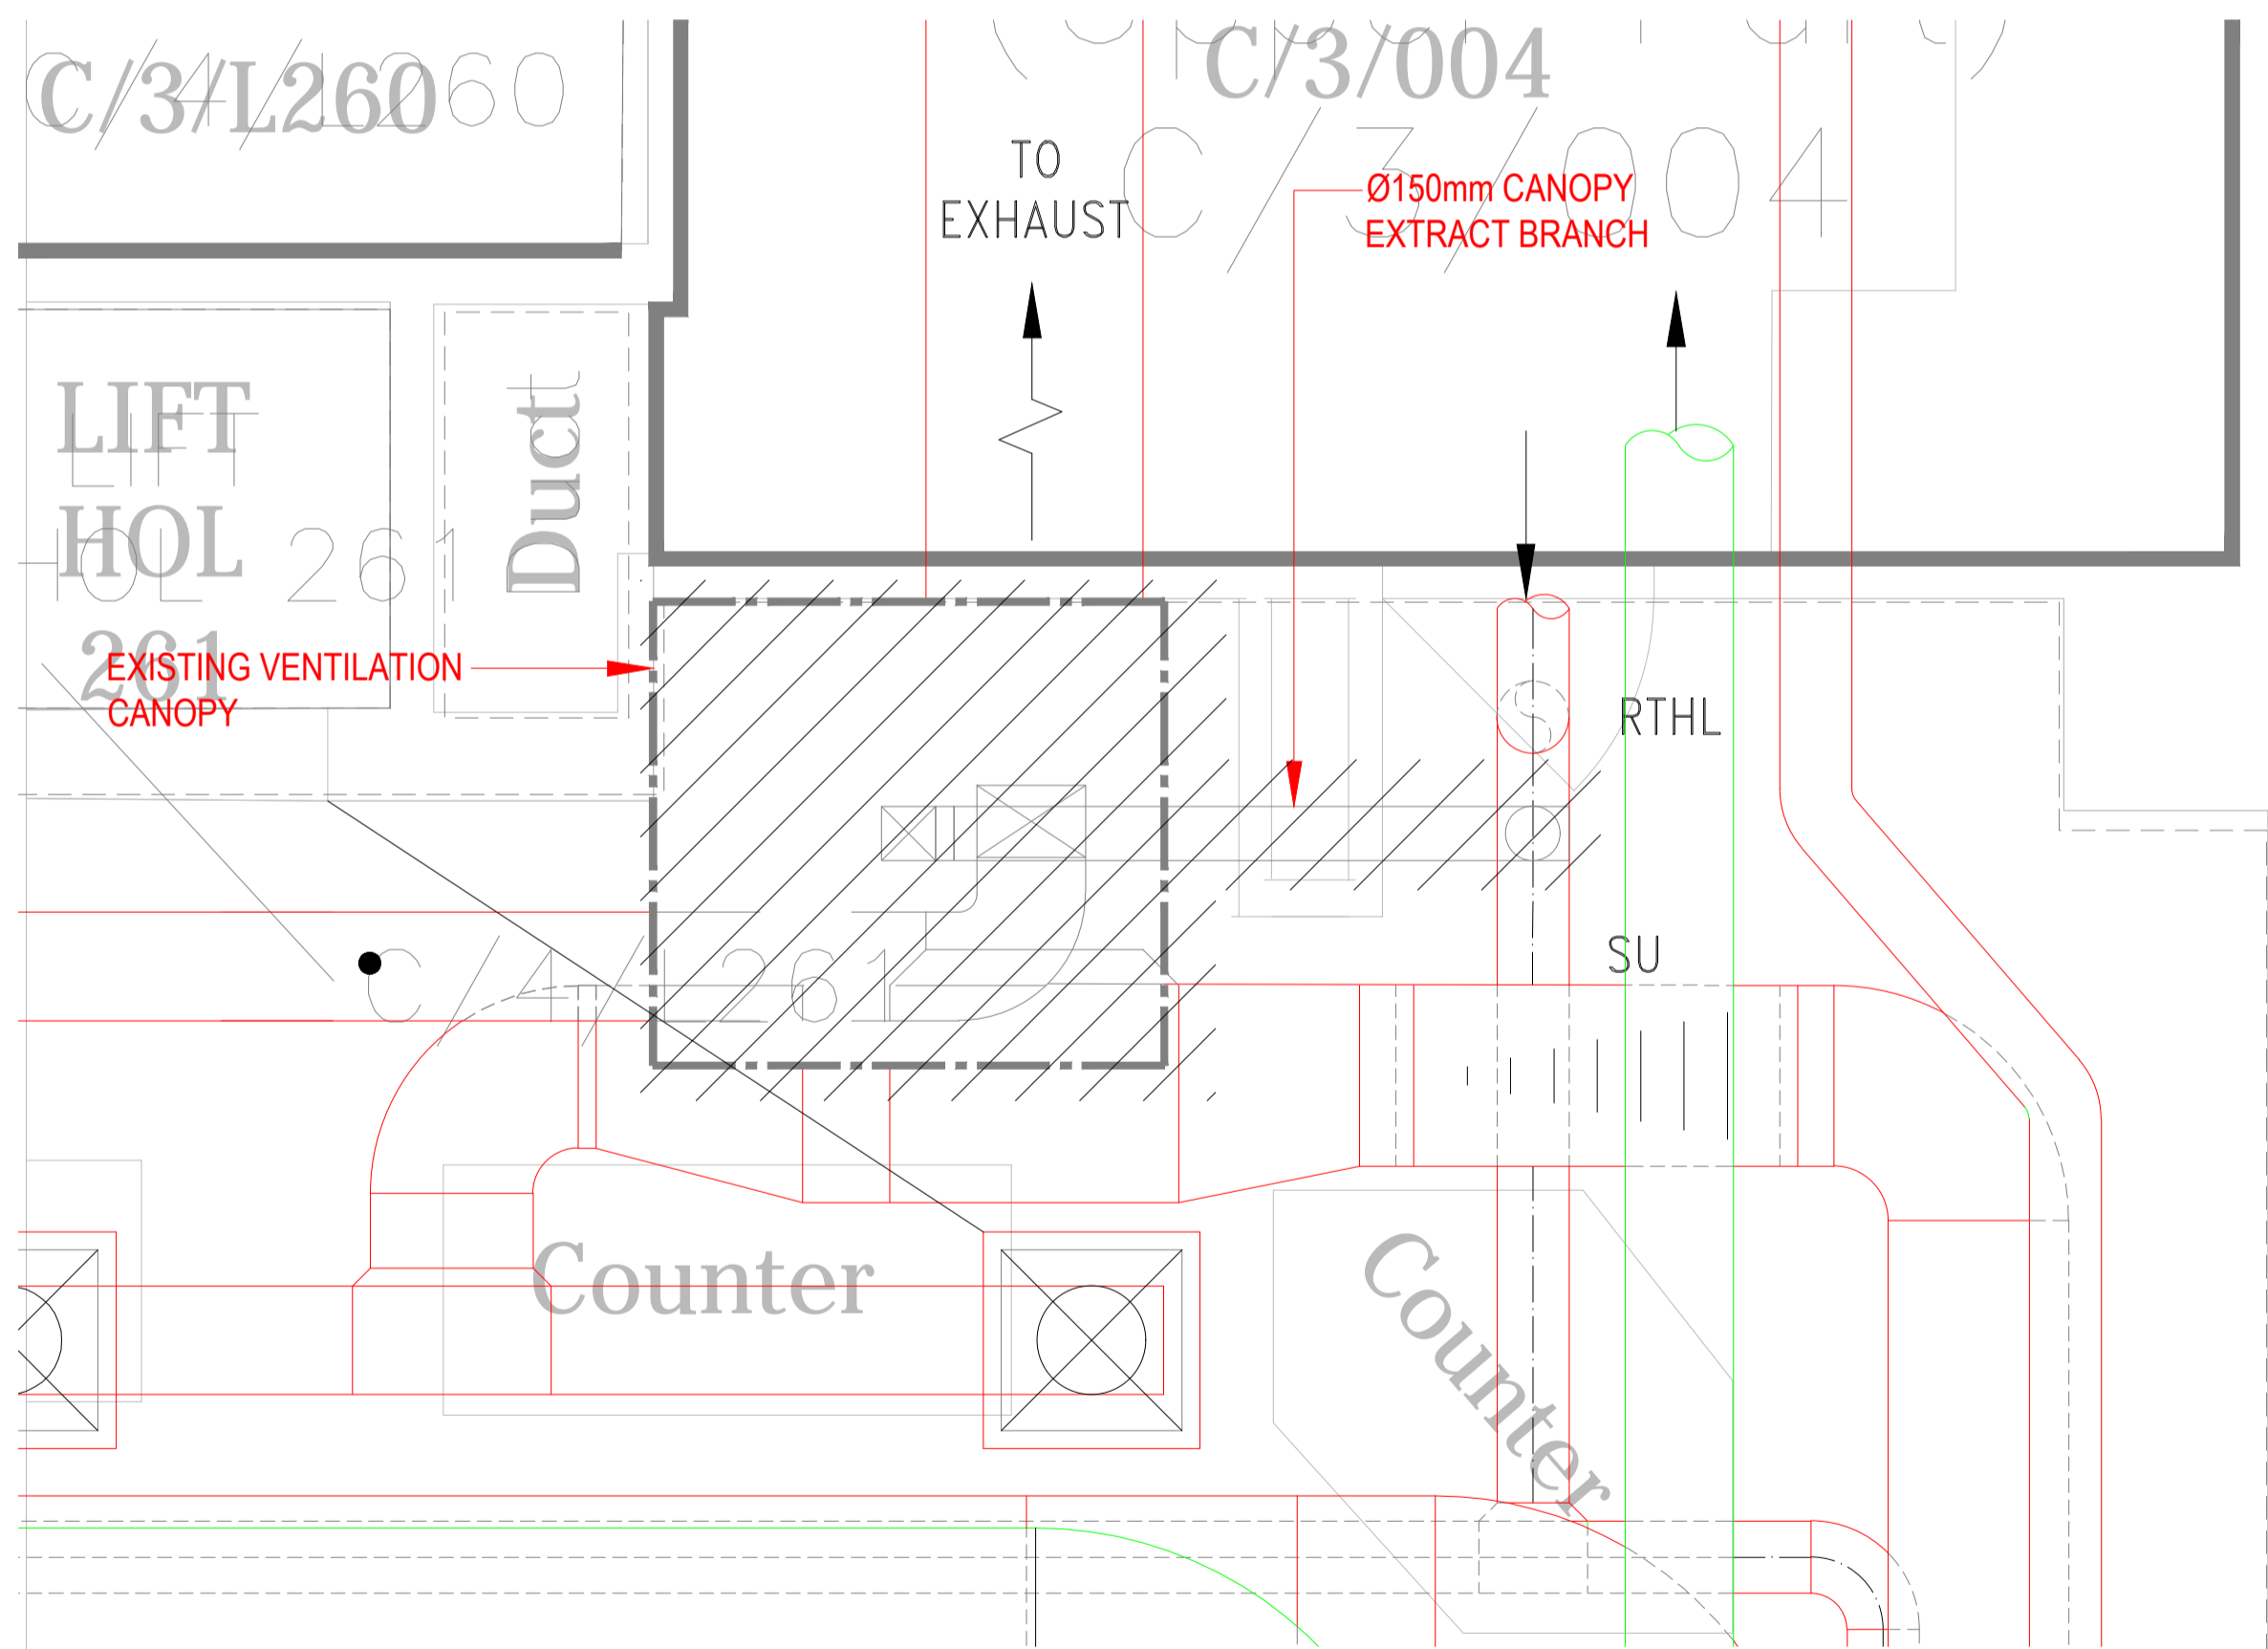

DETAIL B: Existing Hood and Extract / Strip Out Works  
1:20

NOTES. EXISTING OVEN CANOPY AND CONNECTING Ø150MM EXTRACT DUCT TO BE STRIPPED OUT. EXTRACT SYSTEM SERVING THE PREP ROOM AND POT WASH TO REMAIN. CANOPY BRANCH CONNECTION TO MAIN EXTRACT DUCT TO BE REPAIRED AND SEALED ENSURING THE INTEGRITY OF THE AIRLINE IS IN TACT

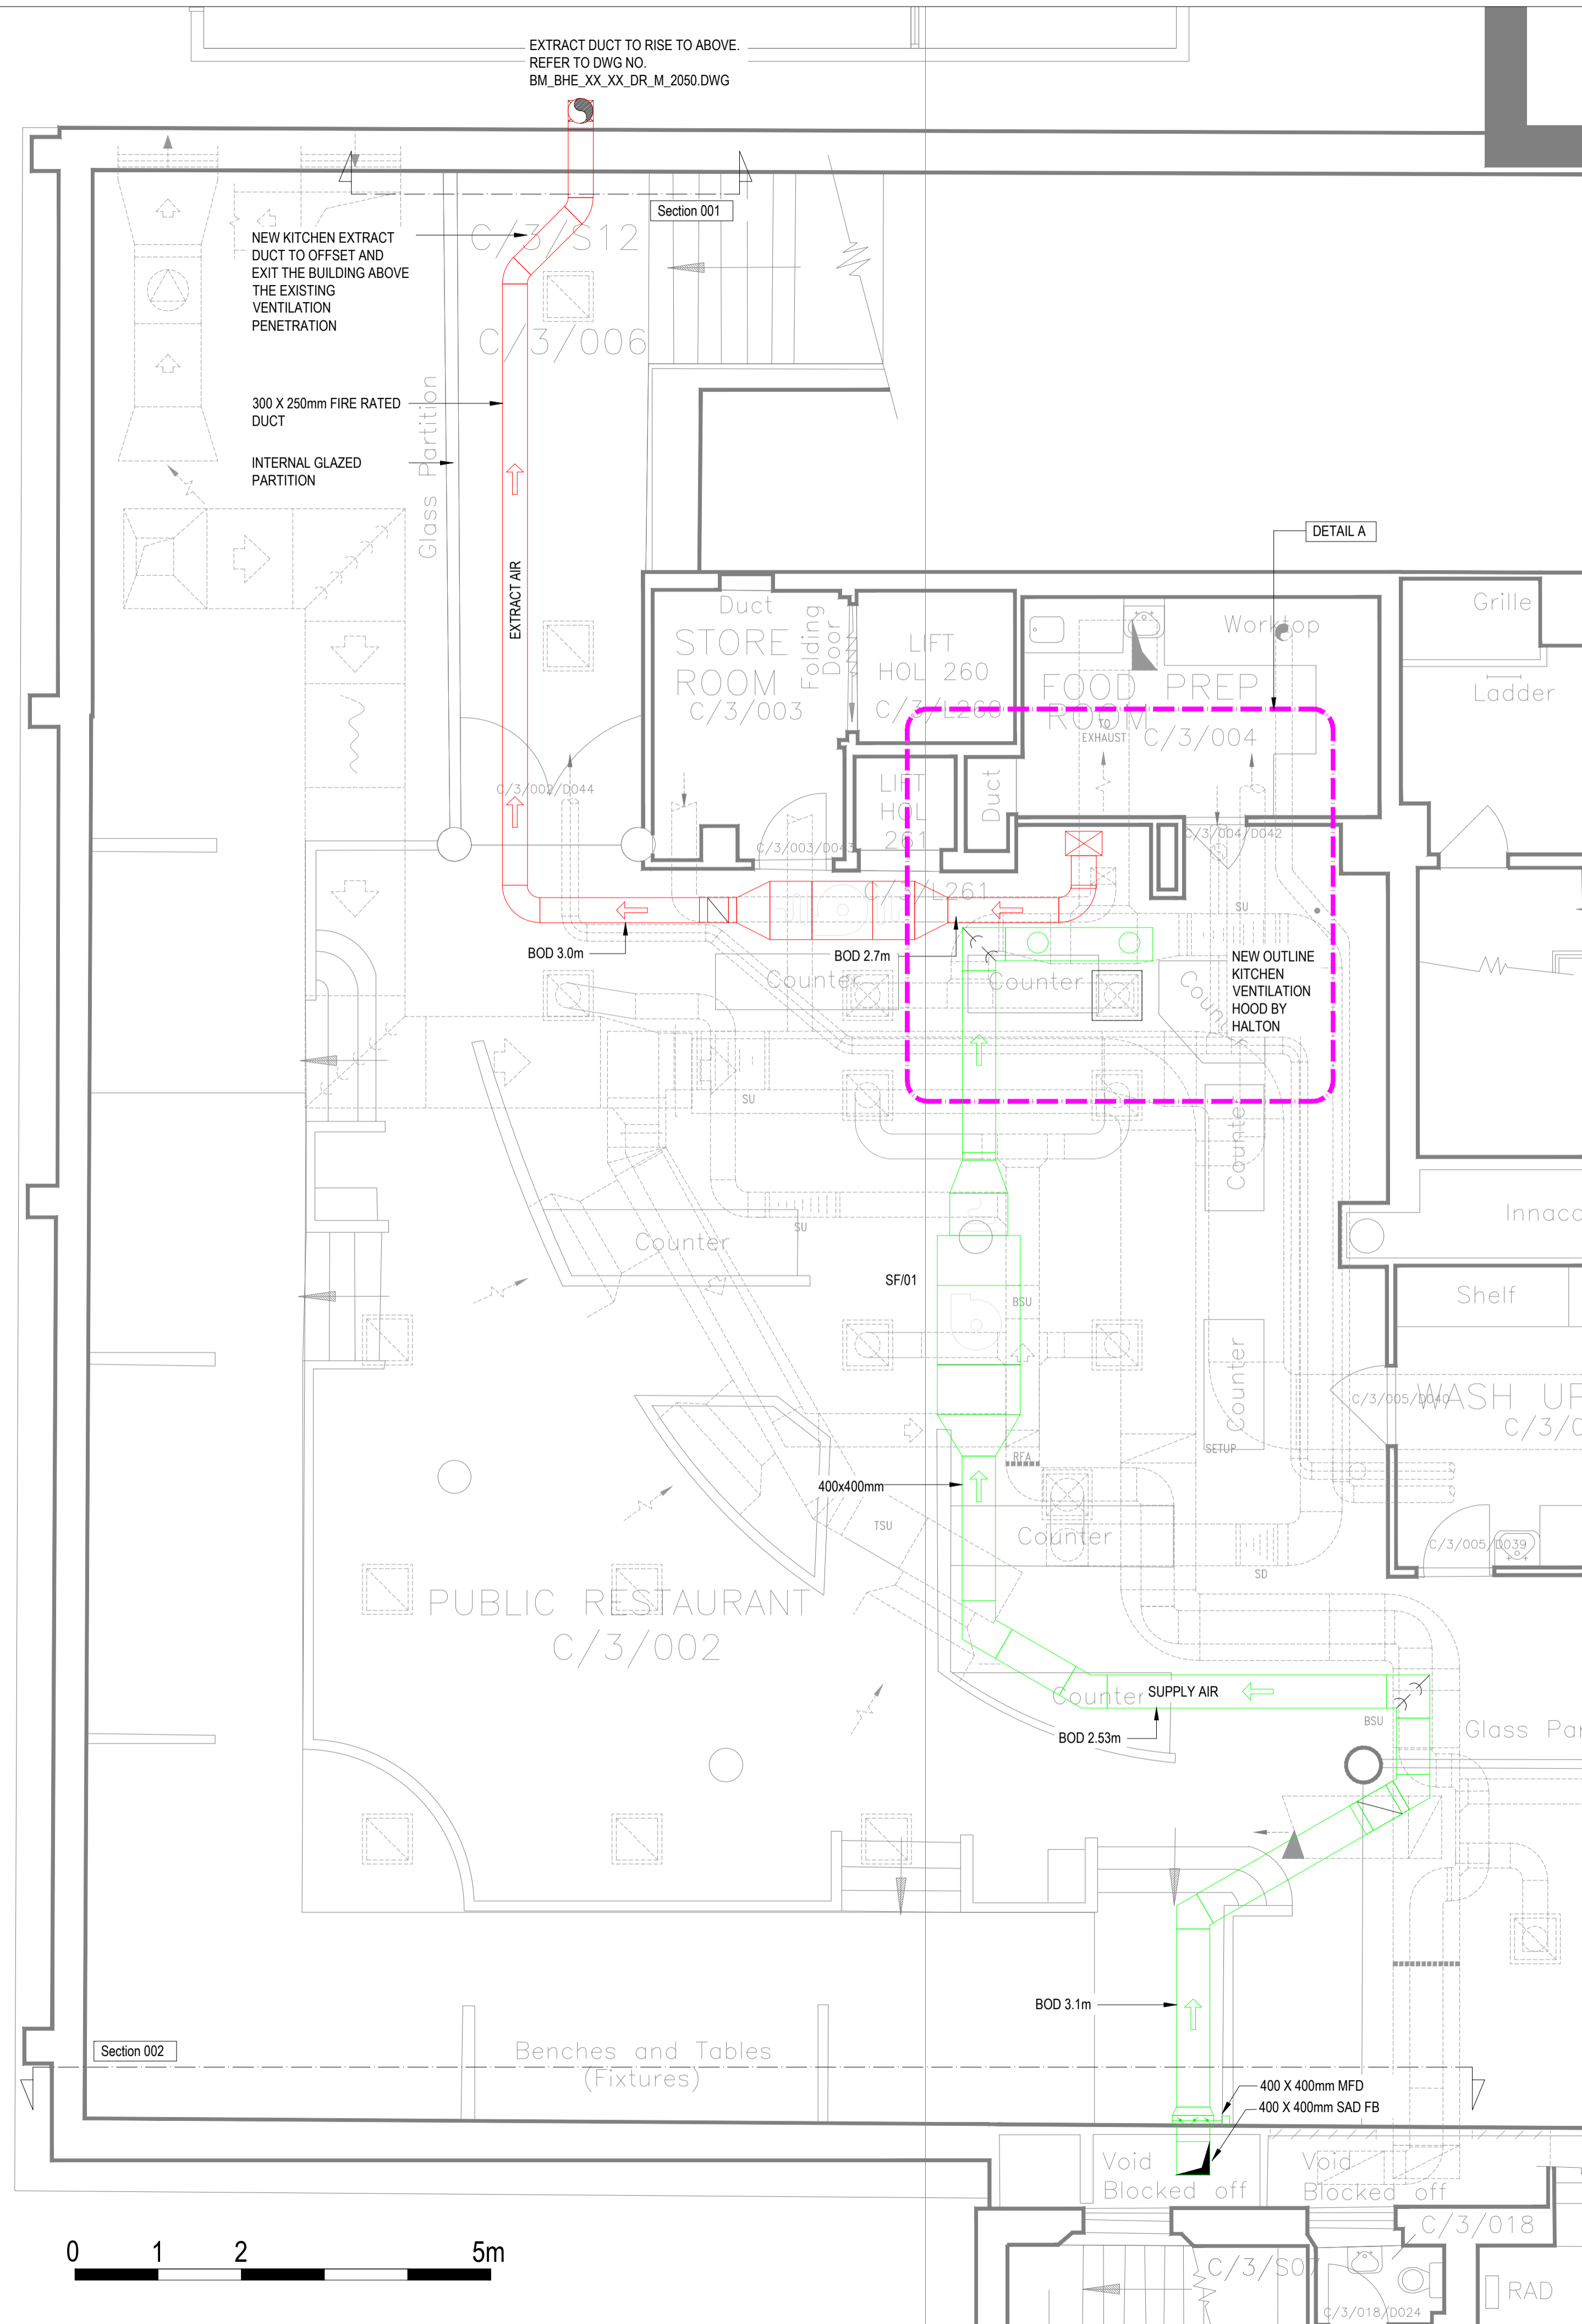

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DO NOT SCALE THIS DRAWING.

**SAFETY HEALTH AND ENVIRONMENTAL INFORMATION**

IN ADDITION TO THE HAZARDOUS RISKS NORMALLY ASSOCIATED WITH THE TYPES OF WORK DETAILED ON THIS DRAWING, NOTE THE FOLLOWING CONSTRUCTION:

INSTALLATION WILL REQUIRE WORKING AT HEIGHT AND IN SMALL VOIDS


**MAINTENANCE/CLEANING/OPERATION**

MAINTENANCE WILL REQUIRE WORKING AT HEIGHT AND IN SMALL VOIDS

**DECOMMISSIONING/DEMOLITION**

EXISTING STANDS ARE LIKELY TO CONTAIN ASBESTOS. REFER TO ASBESTOS REGISTER. GROUND CONTAMINATION SURVEY HAS BEEN UNDERTAKEN. REFER TO SURVEY FOR FURTHER INFORMATION.

- Notes
1. THIS DRAWING IS TO BE READ IN CONJUNCTION WITH ALL OTHER DISCIPLINES, DRAWINGS, SCHEDULES AND SPECIFICATIONS, LEGENDS AND STANDARD DETAILS.
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  6. DIMENSIONS TO BE CHECKED ON SITE BEFORE ANY WORK IS PUT IN HAND OR PREFABRICATED.
  7. THIS DRAWING SHOULD ONLY BE USED FOR THE SPECIFIC SERVICES INTENDED.
  8. THIS DRAWING SHOWS THE DESIGN INTENT ONLY. THE CONTRACTOR SHALL BE RESPONSIBLE FOR THE FULL CO-ORDINATION OF THE SERVICES INDICATED ON THIS AND ALL OTHER SERVICES DRAWINGS.
  9. THE PROJECT NOTES ARE TO BE READ IN CONJUNCTION WITH ALL RELEVANT TECHNICAL SPECIFICATIONS.
  10. WHERE MECHANICAL SERVICES PASS THROUGH FIRE COMPARTMENTATION CEILING VOIDS, FLOOR VOIDS AND STRUCTURAL WALLS THE CONTRACTOR SHALL SLEEVE/SEAL THE OPENING WITH AN ACOUSTIC AND FIRE SEALANT APPROVED BY THE BRITISH MUSEUM'S FRAMEWORK FIRE CONSULTANT.
  11. THE CONTRACTOR SHALL REFER TO THE BRITISH MUSEUM'S UP TO DATE FIRE COMPARTMENTATION DRAWINGS.

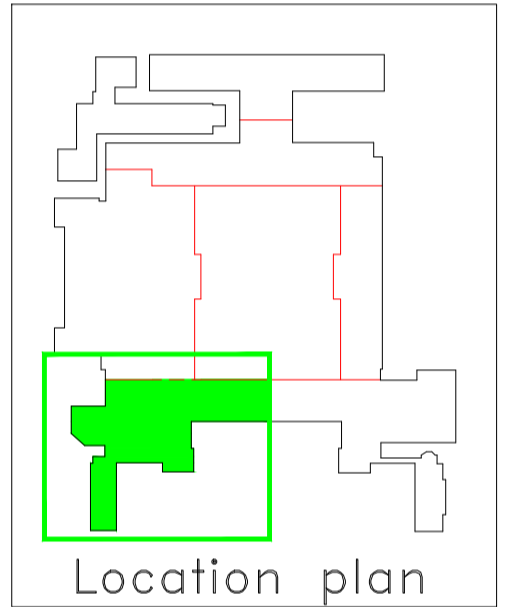

01 FOR PLANNING	13.01.21	CC	SC
00 FOR COMMENTS	18.11.20	CC	SC
Rev	Description	Date	Drm Ch'd

**PLANNING**

Status of drawing

**BUROHAPPOLD ENGINEERING**

Architect N/A

Project British Museum - Pizzeria Ventilation

Dwg Title **SECOND FLOOR VENTILATION LAYOUT**

Scales@A1 1:50

Drawn by CC

Checked by SC

Date 13.01.2021

Job No. 0045387

Drawing No. BM\_BHE\_00\_03\_DR\_M\_2001

Rev 01

Project: British Museum - Pizzeria Ventilation  
 Drawing: BM\_BHE\_00\_03\_DR\_M\_2001  
 Date: 13.01.2021  
 Rev: 01  
 Status: Planning  
 Scale: 1:50  
 Drawn by: CC  
 Checked by: SC  
 Job No: 0045387  
 Drawing No: BM\_BHE\_00\_03\_DR\_M\_2001  
 Rev: 01