

PROPOSED CTIL (TEF) 2No. L08/L09 AHPMDA RRU's I.D. No. 451893, 2No. U09 FHDB RRU's I.D. No. 451894, 2No. L18/L21 AHEGB RRU's I.D. No. 451895, 2No. T23 AZNC RRU's I.D. No. 451896 (1No. OF EACH PER SECTOR) MOUNTED TO REAR STUB POLE OF NEW TRIPOD/QUADPOD ON RRU BRACKETS

PROPOSED CTIL (TEF) 3No. BOB UNITS POLE MOUNTED WITH RRU'S (1No. PER SECTOR)

PROPOSED CTIL (TEF) 3No. C2 (L08/L09) HIGH LEVEL COMBINERS INSTALLED ON REAR OF ANTENNA SUPPORT POLES (1No. PER SECTOR)

PROPOSED CTIL (TEF) GPS MODULE POLE MOUNTED AT 26.5m MEAN ID No. 451887

PROPOSED CTIL (TEF) 1No. MULTICORE FIBRE AND 2No. DC CABLES INSTALLED ON NEW/EXISTING 300 WIDE CABLE TRAY ON FREESTANDING SUPPORTS 300 ARL TO ANTENNA LOCATIONS

CTIL (RESERVED) 2No. COMMSCOPE ANTENNAS AT 31.5m MEAN HEIGHT BEARING 40°, 220° E.T.N I.D. No. 384994, 384995 TO BE REMOVED

EE ANTENNA BEARING 30° E.T.N. ID No 112327 MOUNTED ON 'LADDER' SUPPORT POLE TO BE RELOCATED

PROPOSED CTIL (TEF) RRZT4S4-65B-R6 ANTENNA AT 30.4m MEAN HEIGHT BEARING 30° E.T.N ID No. 451884 INSTALLED ON NEW NON-CLIMBABLE WALL MOUNTED POLE WITH YOKE BRACKETS. NEW BRACE AND PLINTH REQUIRED

PROPOSED CTIL (TEF) 1No. L08/L09 AHPMDA RRU I.D. No. 451889, 1No. U09 FHDB RRU I.D. No. 451890, 1No. L18/L21 AHEGB RRU I.D. No. 451891, 1No. T23 AZNC RRU I.D. No. 451892 MOUNTED TO NEW STUB POLE ON RRU BRACKETS

RELOCATED EE ANTENNA BEARING 30° E.T.N. ID No 112327 MOUNTED ON NEW YOKE BRACKET

PROPOSED CTIL (TEF) RRZT4S4-65B-R6 ANTENNA AT 25.9m MEAN HEIGHT BEARING 150° E.T.N ID No. 451885 INSTALLED ON NEW CLIMBABLE QUADPOD. EXISTING EE ANTENNA TO BE RELOCATED TO OPPOSITE POLE (BEHIND)

PROPOSED CTIL (TEF) AC DISTRIBUTION BOARD IN IP65 RATED ENCLOSURE MOUNTED TO HANDRAIL VIA UNISTRUT (BEHIND)

PROPOSED CTIL (TEF) ELTEK 4TH GEN OUTDOOR PSU FED VIA ROTARY ISOLATOR AND 2No. NSN FLAT PACK RACKS INSTALLED ON EXISTING STEEL GRILLAGE, NEW TRIMMING STEEL REQUIRED (BEHIND)

PROPOSED CTIL (TEF) COMMSCOPE RRZT4S4-65B-R6 ANTENNA AT 25.9m MEAN HEIGHT BEARING 270° E.T.N ID No. 451886 INSTALLED ON NEW CLIMBABLE TRIPOD FIXED TO EXISTING GRILLAGE, NEW GRATED FLOORING AND HANDRAIL EXTENSION REQUIRED (BEHIND)

NOTES

THIS DESIGN IS ICNIRP COMPLIANT BASED ON T&T PROX5 REPORT

PROJECT No. 212171

CSID 15069522

CSR 73171

VFID N/A

CELL No. 7317102

BT SKYLINE No. NW0001

21.A	PROJ No	212171		DAL	
	PLANNING				
21	PROJ No	212171			
	EMA		20/01/21	DAL	DAL
20	PROJ No	212171			
	Planning Amend		12/08/20	DAL	DAL
19	PROJ No	188885			
	PLANNING		15/05/18	DAL	JY
18	PROJ No	188885			
	PLANNING		31/10/17	DAL	BG
ISS	REVISION	DATE	DRN	APP	



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SITE No 166642
HAMPSTEAD TE
FINCHLEY ROAD
CAMDEN
GREATER LONDON 3
NW3 6EX

NGR TQ 25930 85170

OS GRID 525930 185170

TITLE
ELEVATION
PROPOSED
CTIL (TEF)


SCALE 1:200

DRAWN IM 01/06/11

APPROVED DAL 20/01/21

DRG No. Sheet 2 of 2 Rev

166642-22-150-MD02121.A

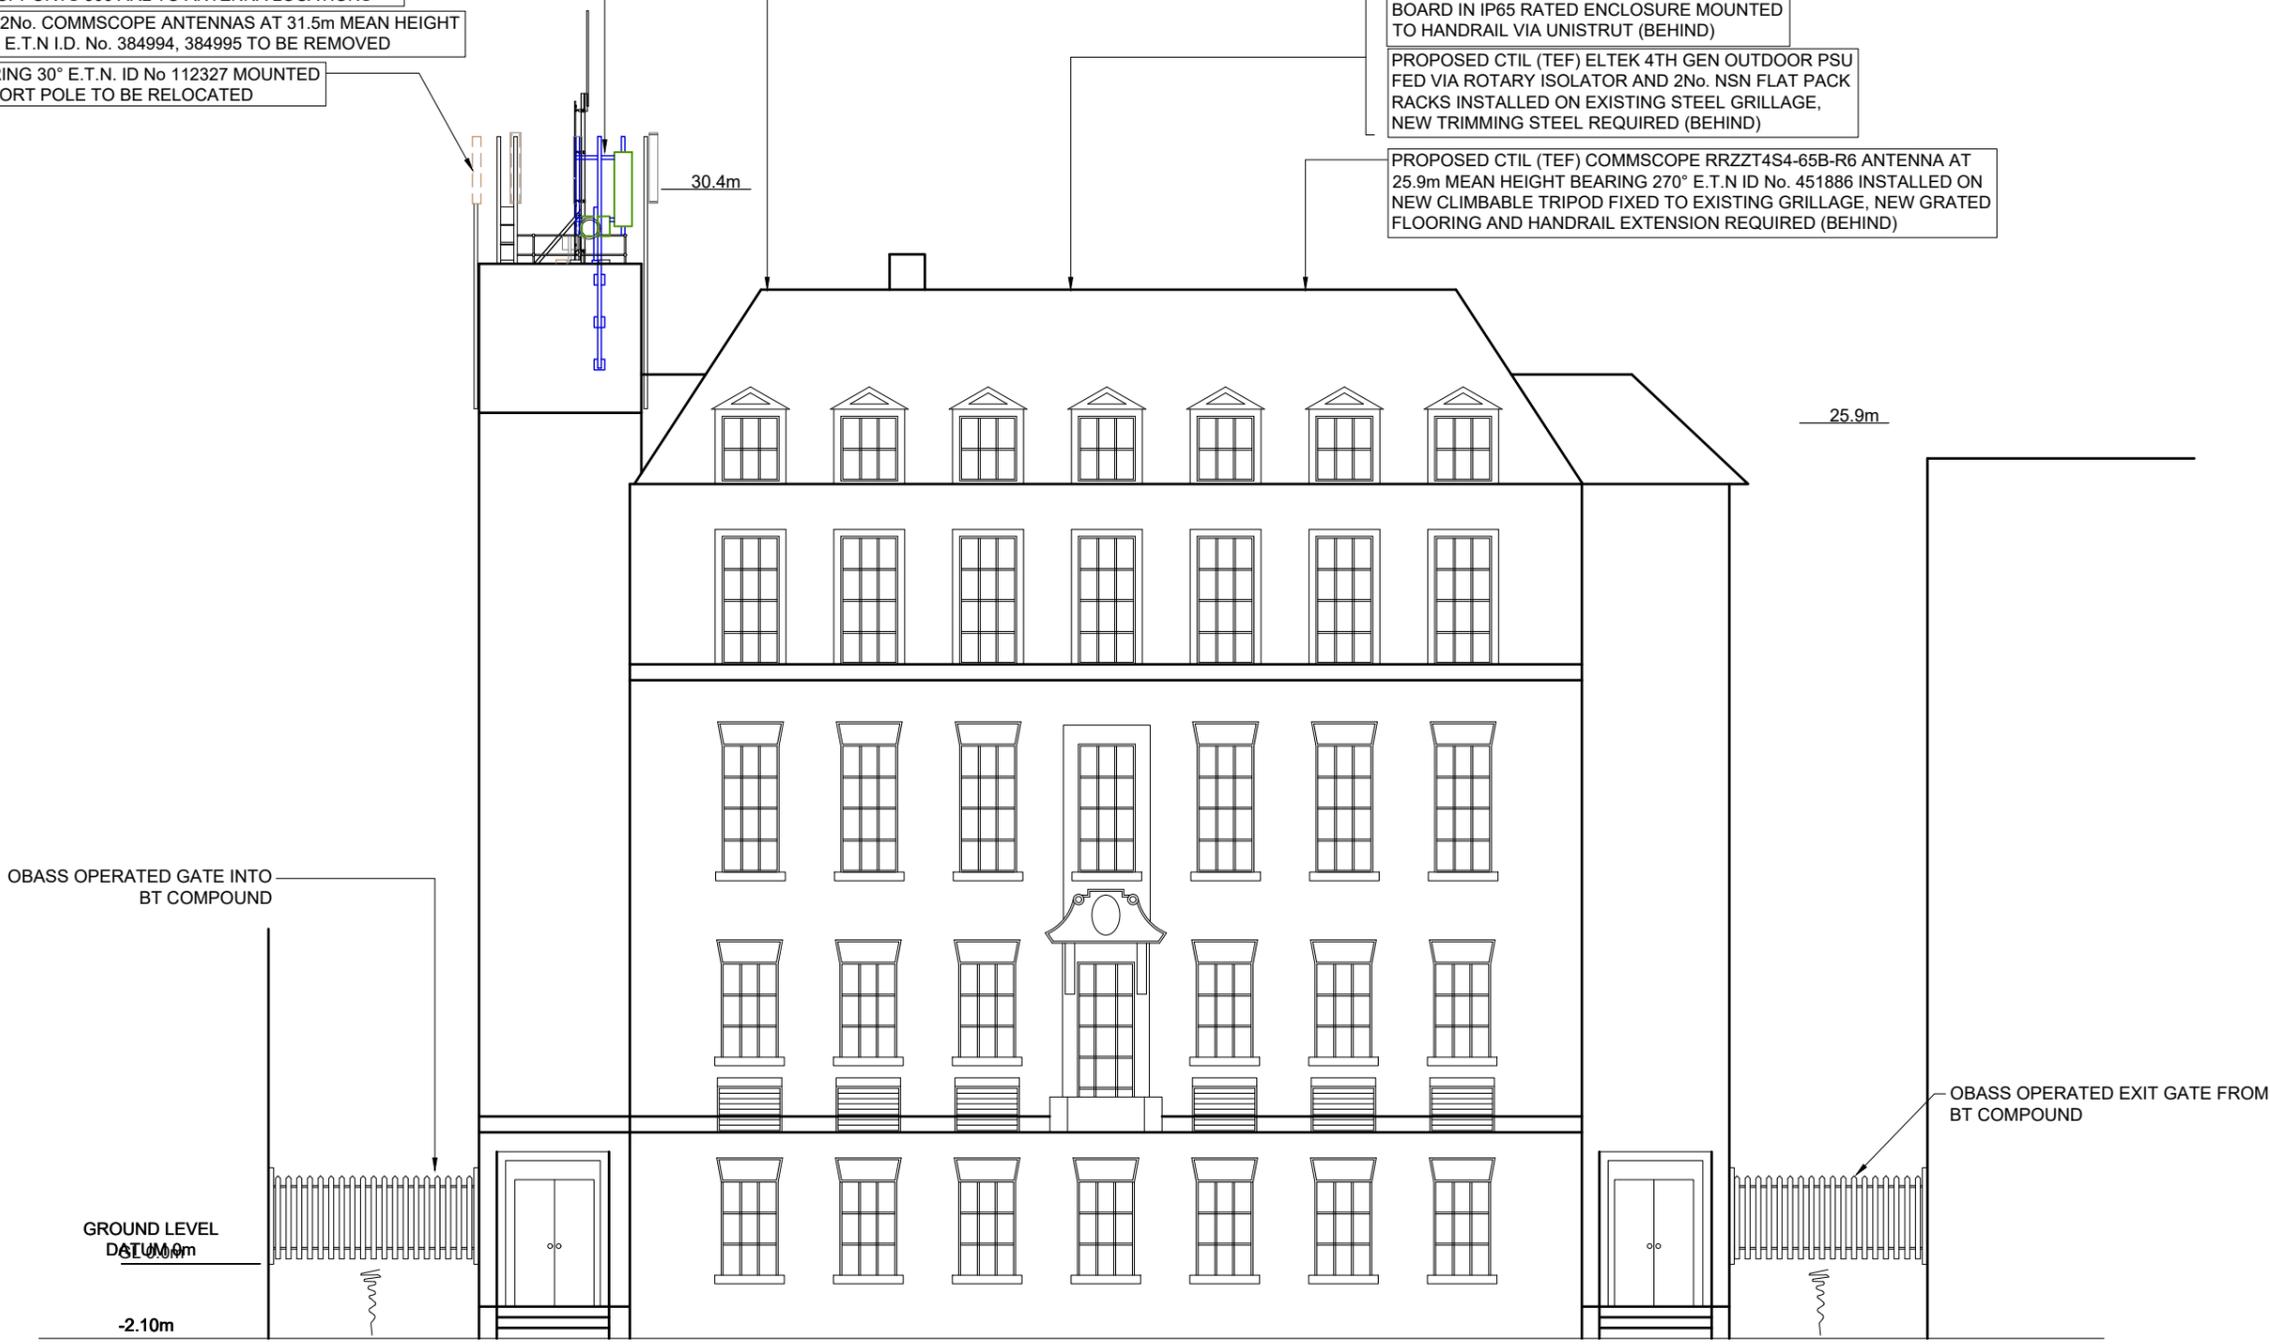

NORTH-EAST ELEVATION

FEINT DETAILS INDICATE LOCATIONS RESERVED FOR OTHER PROPOSALS WHICH MAY BE THE SUBJECT OF SEPARATE APPLICATIONS