

All work must be carried out in accordance with the Building Regulations and to the satisfaction of the Local Authority.

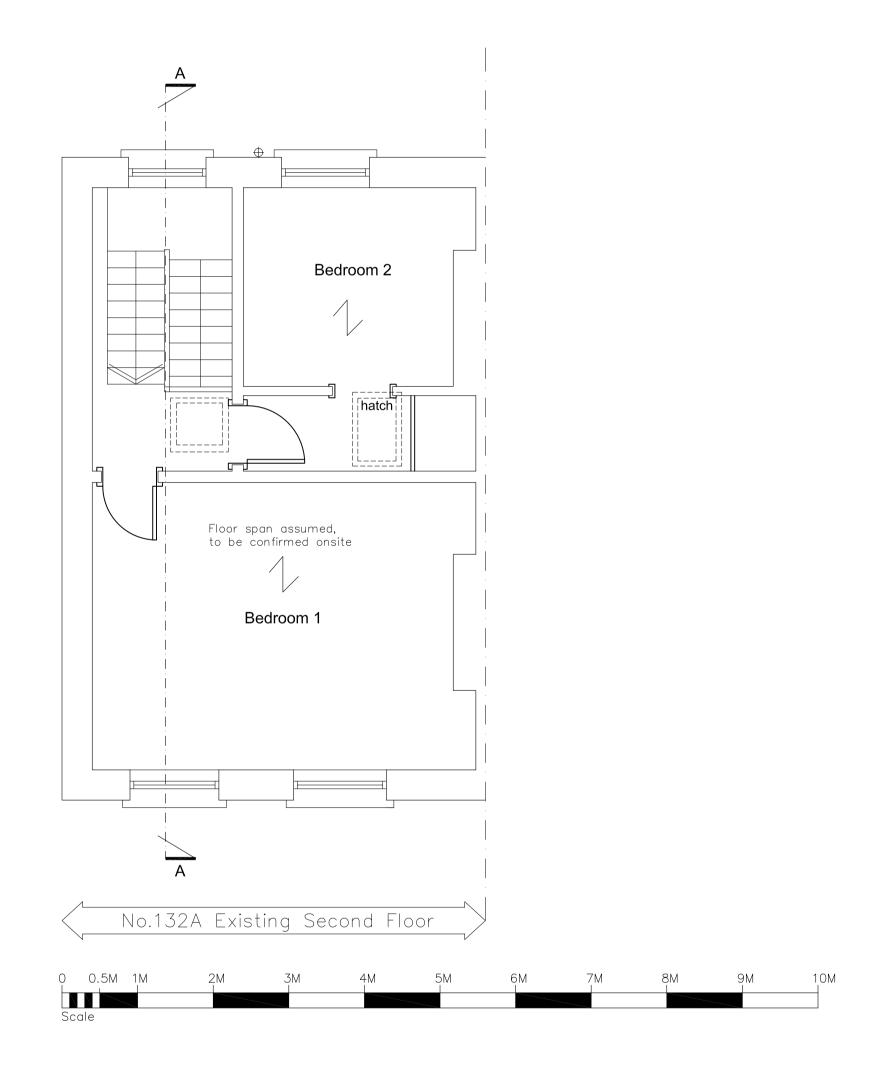

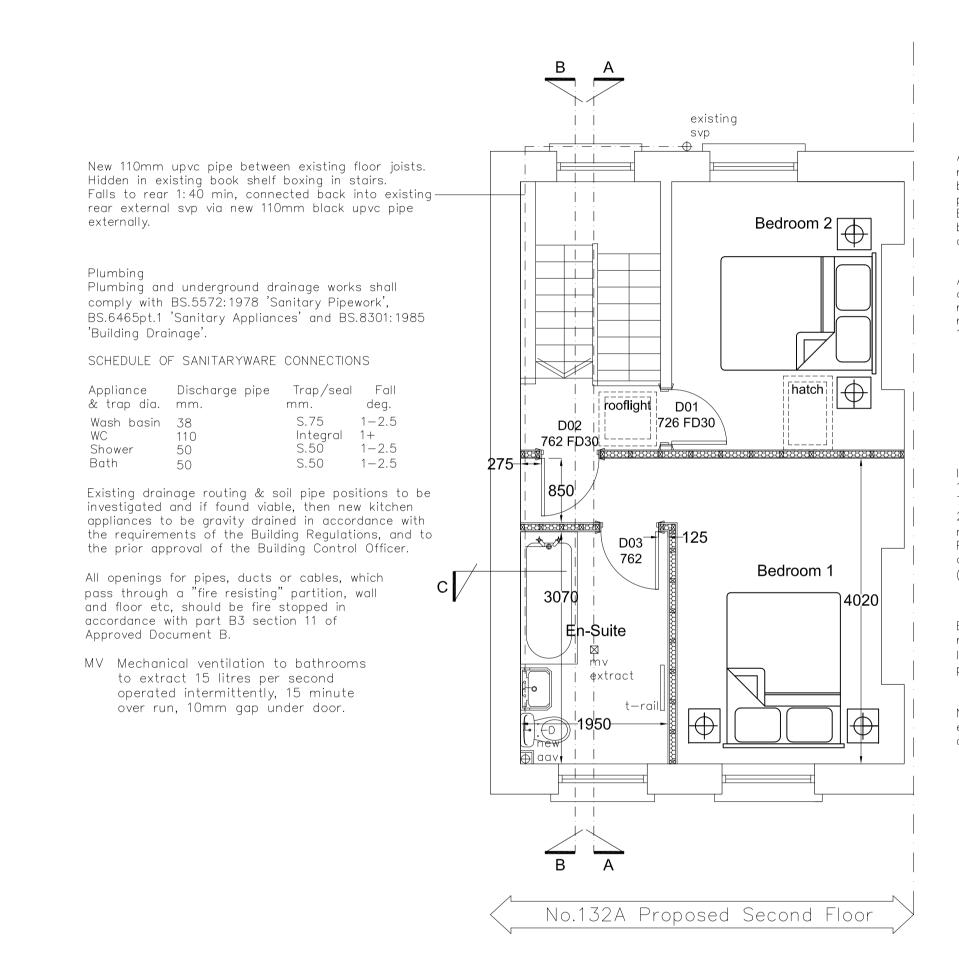

All electrical work required to meet the requirements of 'Part P' (Electrical Safety) must be designed, installed, inspected and tested by a person competent to do so. An appropriate BS7671:2008 electrical installation certificate to be issued for the work by a person competent to do not.

Any new electric switches and sockets and socket outlets to comply with Part M2 current building regulations. Switches and sockets in habitable rooms at appropriate heights between 450mm and 1200mm above finished floor level.

Internal partitions to comprise;
1 layer of 12.5mm plasterboard each side of
75x50mm timber studs. An absorbant layer of
25mm min. thickness mineral wool (10kg/m3
minimum density) to be suspended in the cavity.
Partition provides 30 minutes fire protection and
complies with Part E of the Building Regulations
(sound insulation).

En—Suite to be mechanically extract vented to roof outlet to achieve vent rate of 15 litres/second. 10mm gap under door to be provided to allow for replacement air.

New en—suite drainage connected back into existing svp to rear by new AAV, to be boxed and accessable for maintenence.

Client:

-Project Title: 132a St Pancras Way London NW1 9NB

Drawing Title:
Existing and Proposed Floor Plans
Sections

Drawn: Date: 24.09.2020
Scale: 1:50 @ A1
Dwg.No.: BPR.01.01

HARTLEYS PROJECTS LTD PO BOX 43391, LONDON N5 1SZ 020 73549268