
Phoenix Place, Mount Pleasant – Phase 1 (Block A) Condition 12 – Materials

BroadwayMalyan[™]

Submission to LB Camden - October 2020 Rev 02

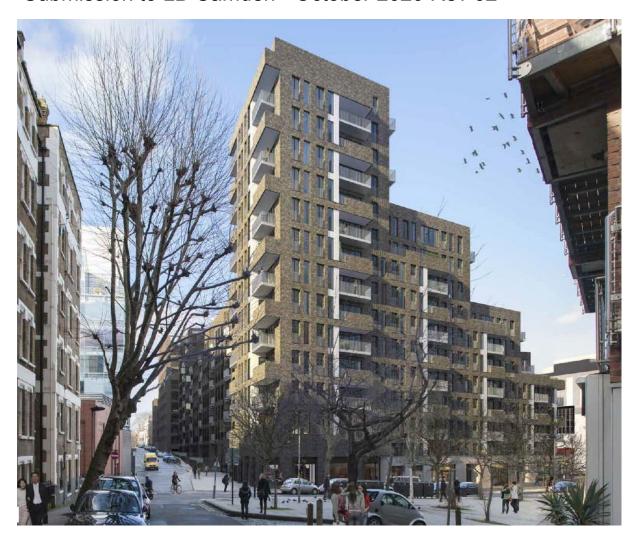



BroadwayMalyan[™]

Condition 12 - Materials

Purpose of Document

This document has been prepared by Broadway Malyan on behalf of Taylor Wimpey Central London / Bouygues to illustrate the proposed facing materials. This document is to be considered alongside the submitted hand samples and site mock-ups presented to LB Camden officers.

Contents

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Planning Condition 12 - Part (a) - Entrances	Page 4
Entrance Elevations	Page 5
Typical Entrance Door Details	Page 11

Condition 12 - Materials

BroadwayMalyan[™]

Introduction

This document has been prepared by Broadway Malyan on behalf of Taylor Wimpey Central London/Bouygues to illustrate the proposed facing materials listed below. This document should be considered alongside the previously submitted hand samples and site mock-ups and finishes submissions presented to LB Camden Officers and is submitted for approval under Condition 12 to discharge (a) Entrances.

The materials submitted for approval are:

Condition 12(a)

Mount Pleasant frontage - Entrances

Condition 12 - Materials

BroadwayMalyan[™]

Planning Condition 12 - Materials

The wording of the LB Camden planning condition is as follows:

Details of facing materials including samples shall be submitted to and approved in writing by the Local Planning Authority on a Section by Section basis prior to any super structure works commencing on that Section. The details and samples shall include:

- a) 1:50 elevations of all entrances (residential, office, flexible use) to include doors, sections, elevational and threshold treatments, all to be shown in context and to a scale of 1:50
- b) brickwork including buff, red and brown coloured with varied mortar colours (including brick panels and mortar courses);
- c) cladding panels;
- d) window treatment (including sections and reveals);
- e) roofing materials;
- f) louvered treatment to substations;
- g) glazing;
- h) balustrading treatment (including sections);
- i) any other materials to be used (Louvres & Signage Strategy)


An elevational mock-up of external materials to be used in blocks A, B, C and D shall be erected on site and shall be approved in writing by the Local Planning Authority prior to any works commencing on blocks A, B, C or D.*

Notes

This document provides details of the materials / elements highlighted in red (see left). The materials highlighted in blue have already been submitted and discharged by LB Camden. Part (i) is highlighted in green as a partial discharge is pending for the signage strategy.

The elevational mock-up erected on site by Bouygues UK is for Phase 1 (Block A) only. A separate mock-up for Blocks B, C and D will be commissioned at a later date by Taylor Wimpey Central London.

All roof finishes are covered in the Condition 16 submission.

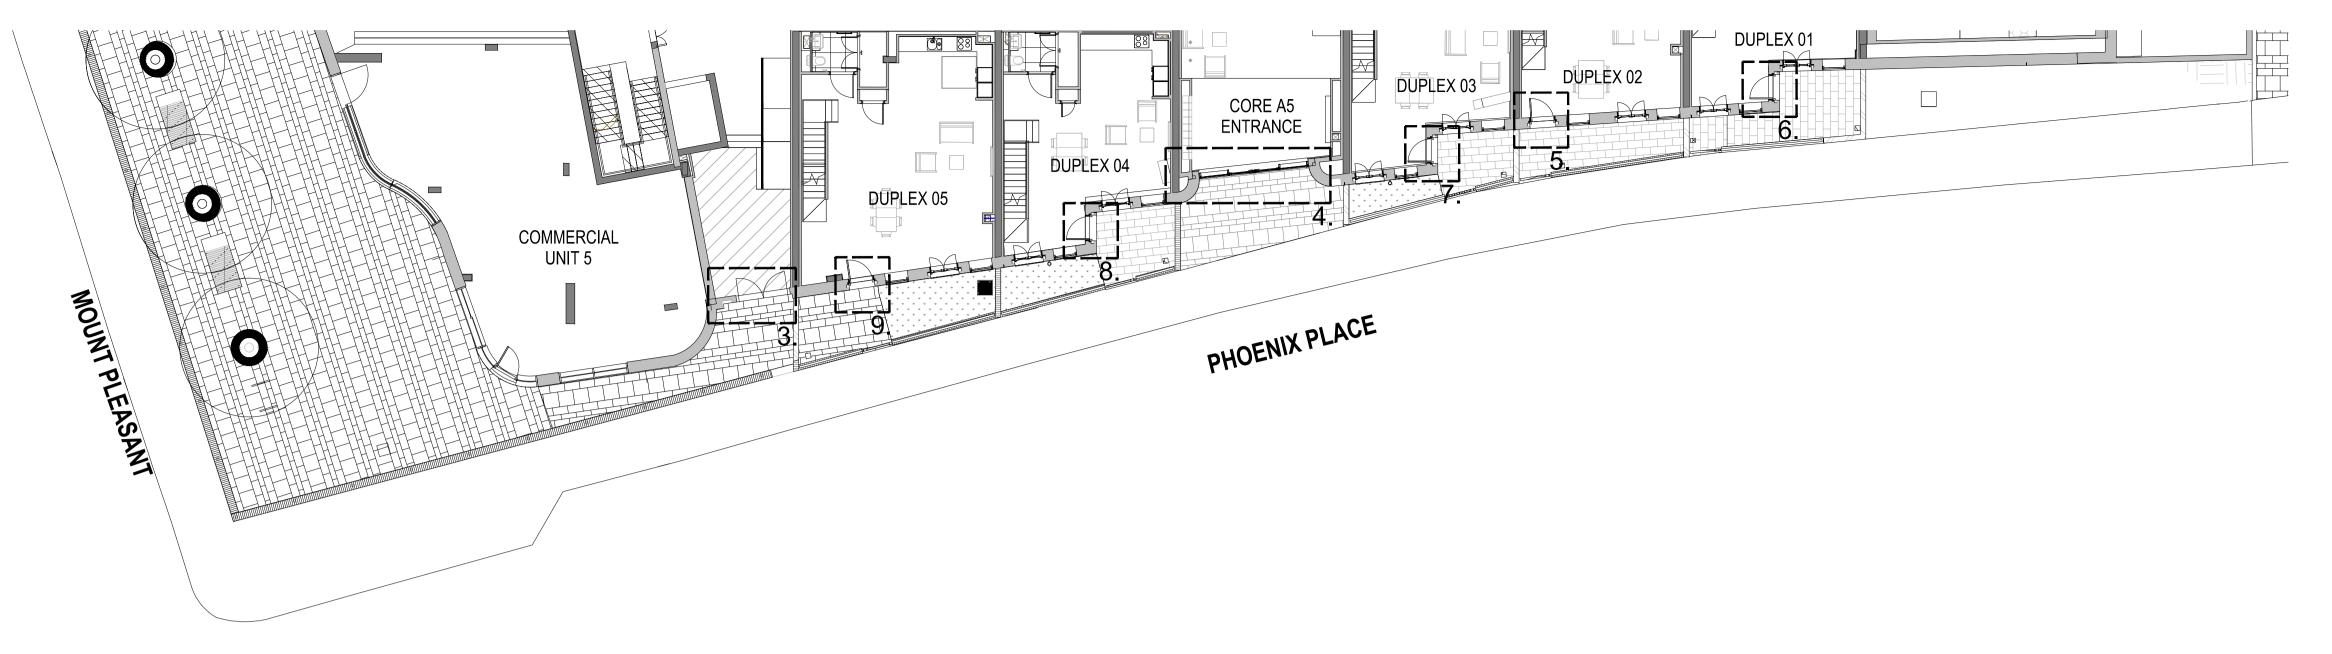


00 Lower Ground Level - Phoenix Place - Door Locations
Scale 1: 150



Phoenix Place (West) Elevation - Planning

Scale 1: 150

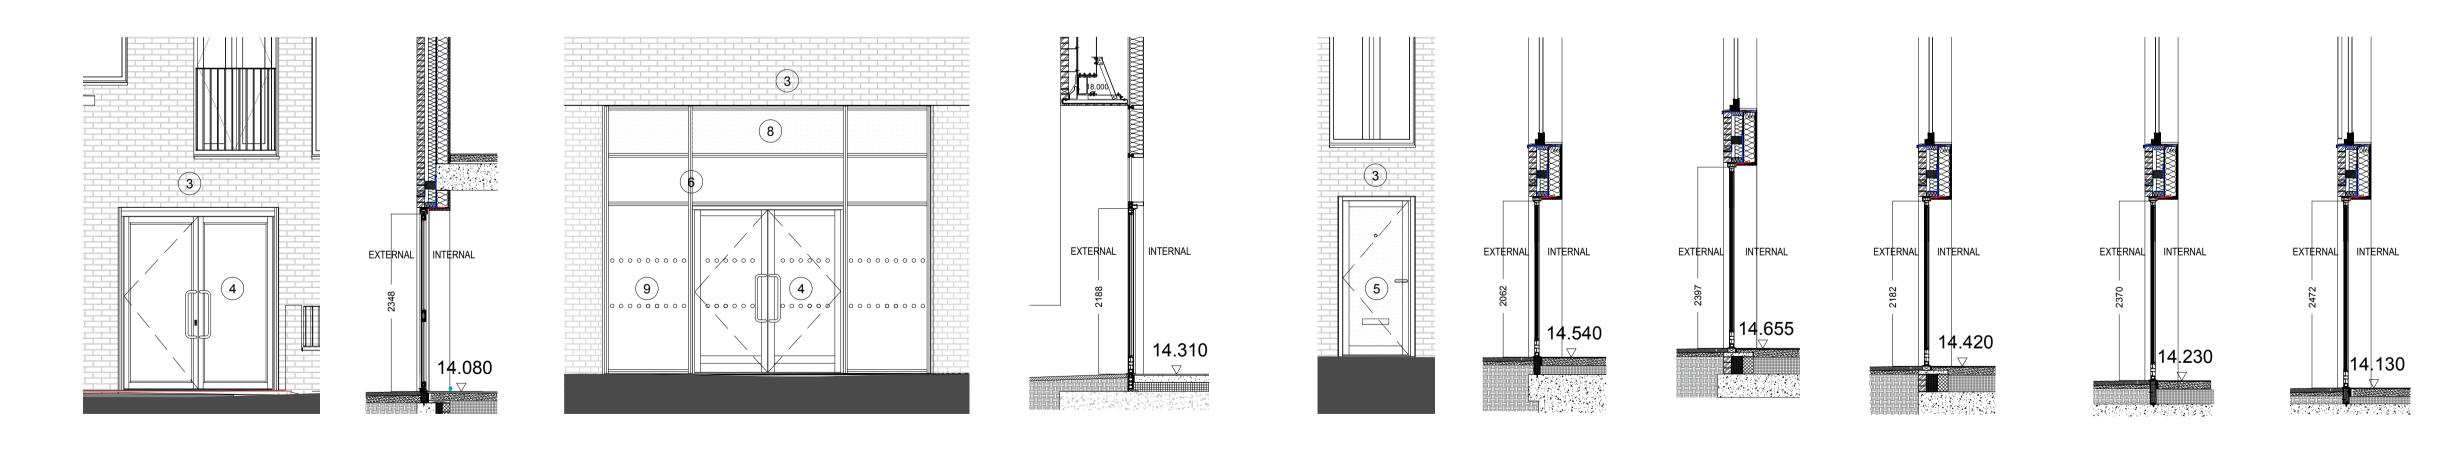

RMG Entrance Elevation & Section
Scale 1:50

A5 Entrance Elevation & Section Scale 1:50

Duplex 02 Entrance Elevation & Section

Scale 1:50 Duplex 01 Entrance Section Scale 1:50

Duplex 03 Entrance Section Scale 1:50

Duplex 04 Entrance Section


Duplex 05 Entrance 9 Section
Scale 1:50

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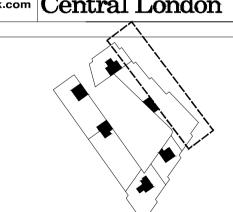
Reference list:

- Moleanos Limestone Cladding
 Macieira Flamed Granite plinth

- Pagus Grey Brick
 KAWNEER AA190TB Door System within 451TB framing system. Finish - Anodised Aluminium, Anolok 545, Dark umber
- 5. Solid Door Panel. Finish Anodised Aluminium, Anolok
- 545, Dark umber.
- KAWNEER AA100 Curtain Wall. Finish Anodised
- Aluminium, Anolok 545, Dark umber
- Vertical fin covered weather louvres. Finish Anodised Aluminium, Anolok 545, Dark umber
- 8. Spandrel panels. Finish 3mm Aluminium Spandrel
- sheets Anodised Anolok 545 medium bronze
- Clear toughened heat soaked tested glass
- 10. Aluminium Coping. Finish PPC Interpon Y2217F Steel
- Bronze 2 11. Karma White Brick



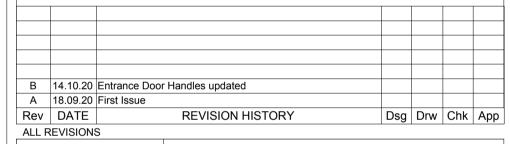





ORIGINATOR

KEY PLAN

BroadwayMalyan em

2 Castle Street, Castlefield, Manchester. M3 4LZ. 0161 819 2277

DRAWING TITLE

Mount Pleasant Phase 1 Phoenix Place Entrances


Name	Signature	Date
BMA	Broadway Malyan	14.10.20

Designed by	BMA	Broadway Malyan	14.10.20
Drawn by	CG	C. Grey	14.10.20
Checked	SMA	S. McAllen	14.10.20
Approved	SMA	S. McAllen	14.10.20

As indicated @ A1	BIM FILE NAME
FIRST ISSUE DATE 18.09.20	PROPOSED STATUS FOR PLANNING

MP1 BMA ALL SL ELV A31 905500 B

PROJECT ISSUER AREA LEVEL TYPE

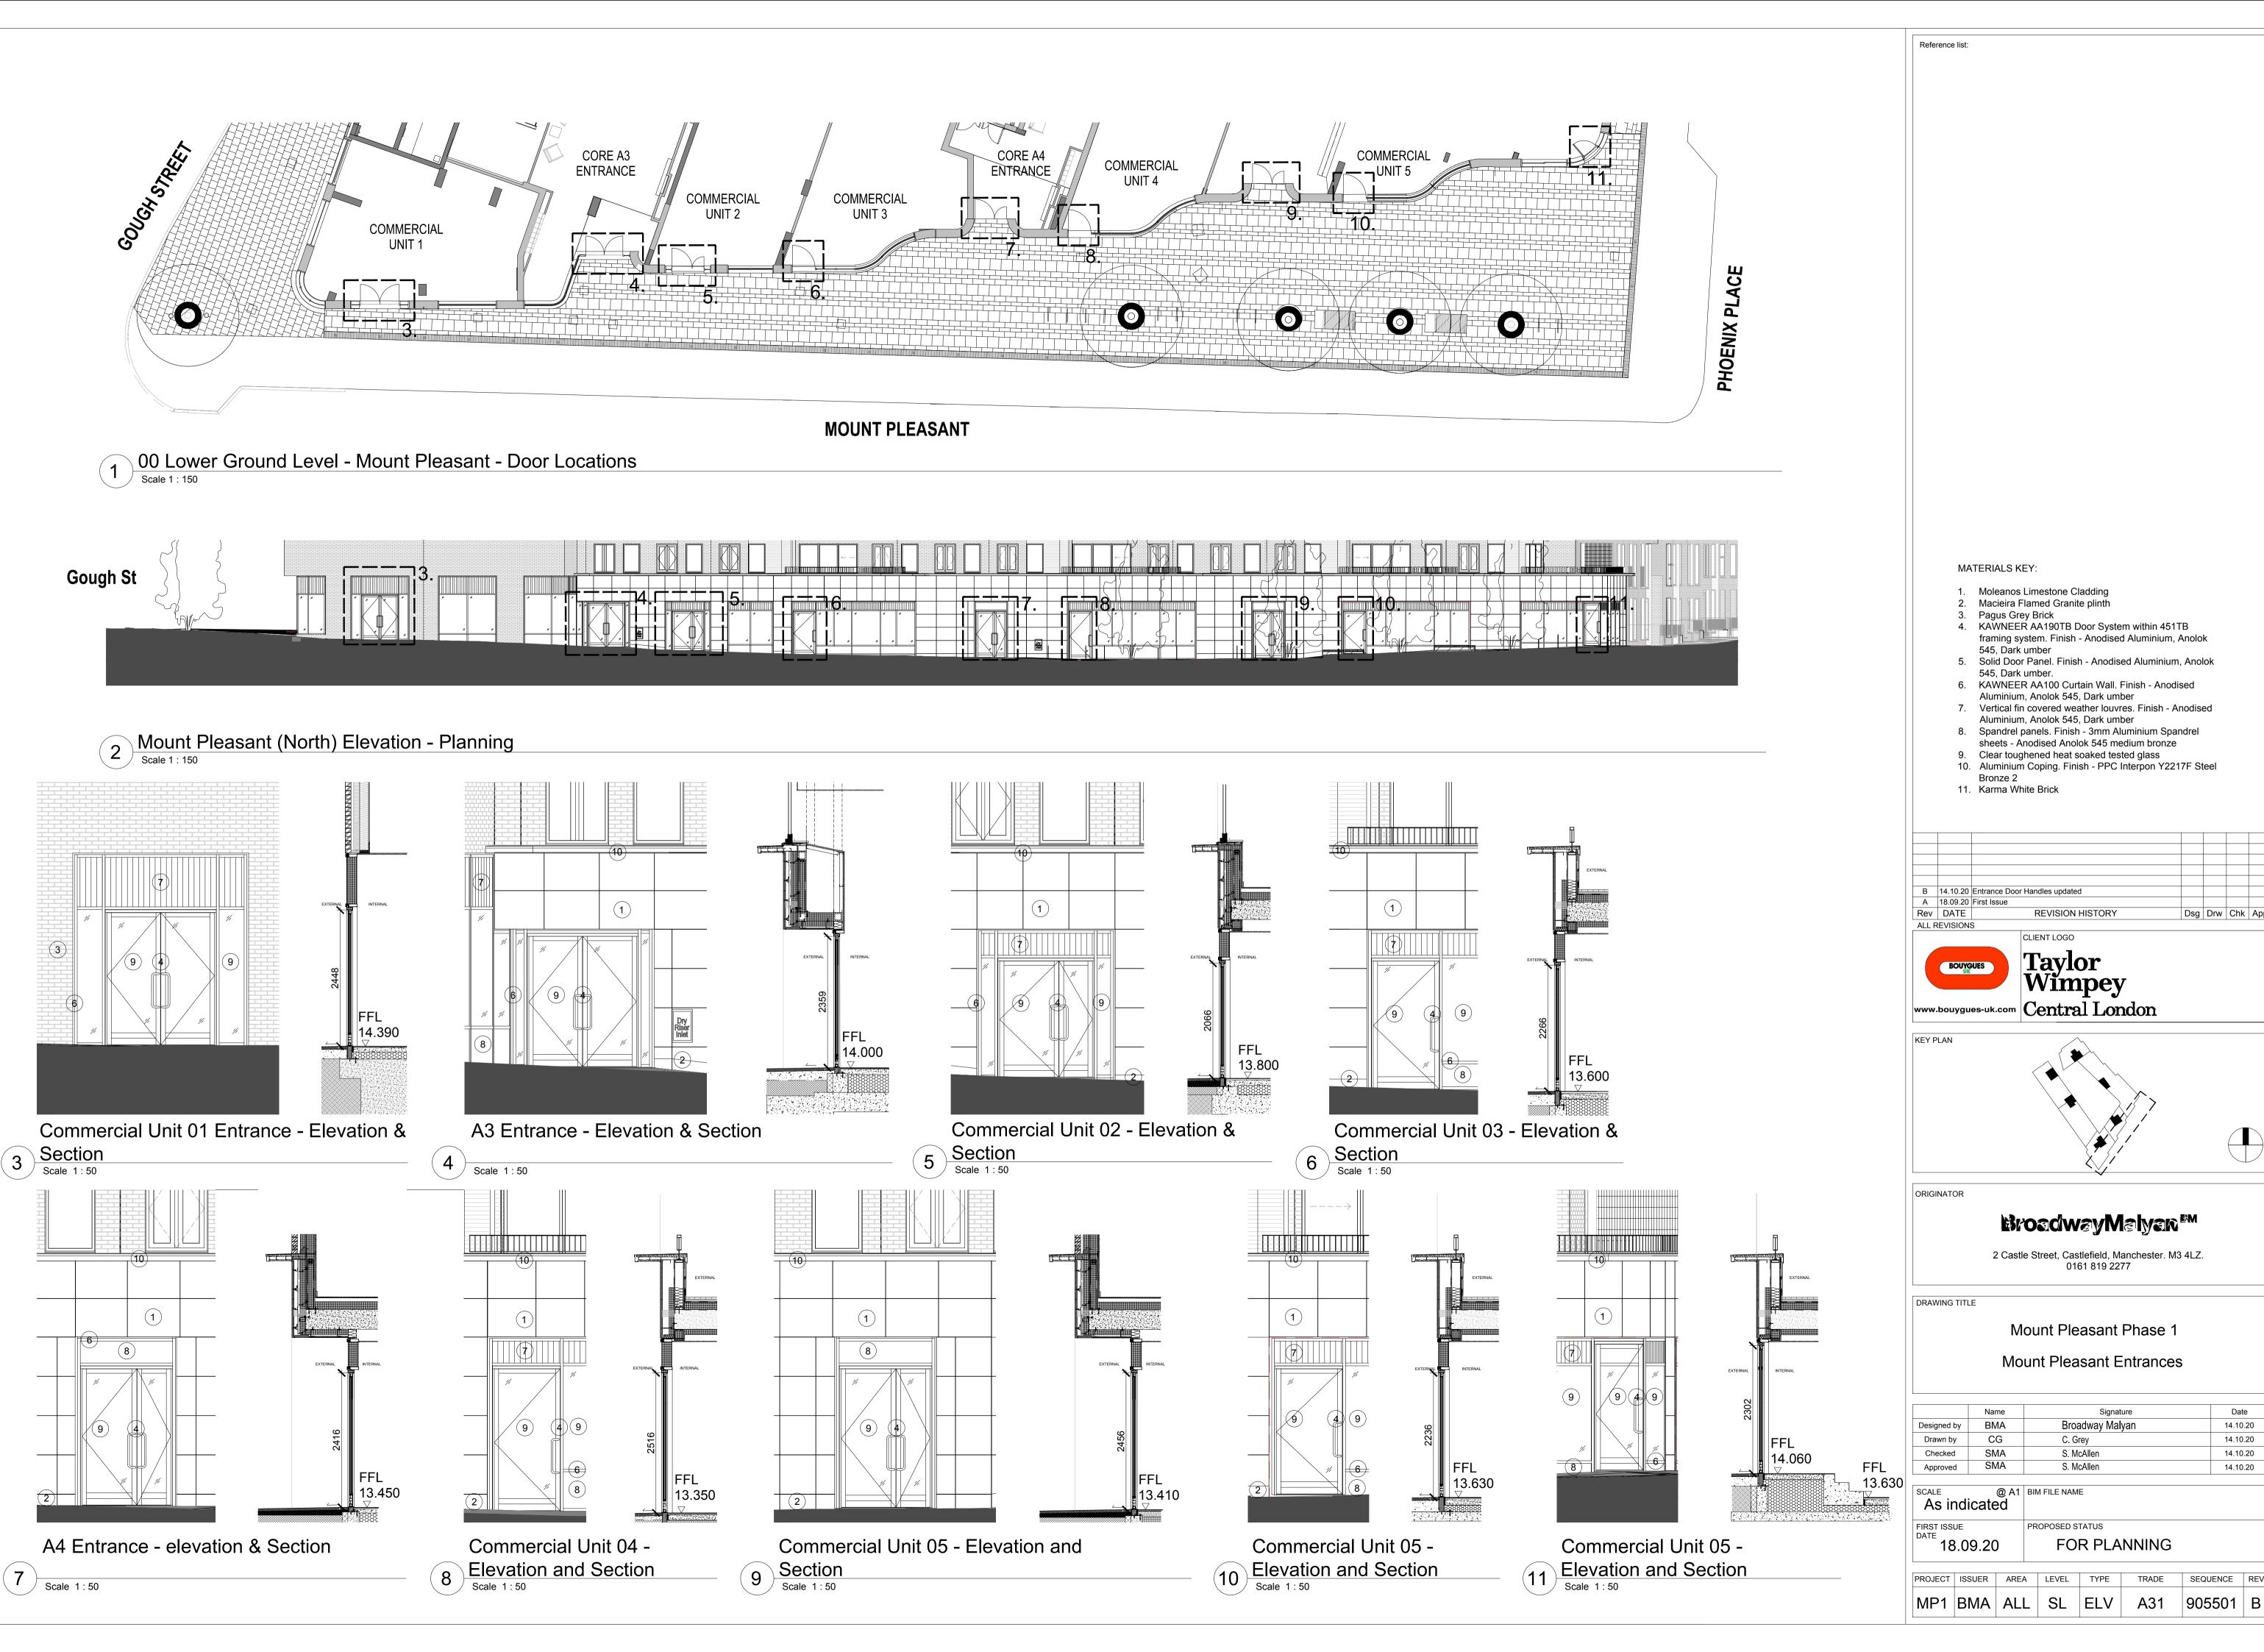

Dsg Drw Chk App

Date

14.10.20 14.10.20

14.10.20


14.10.20

Broadway Malyan

FOR PLANNING

C. Grey S. McAllen


S. McAllen

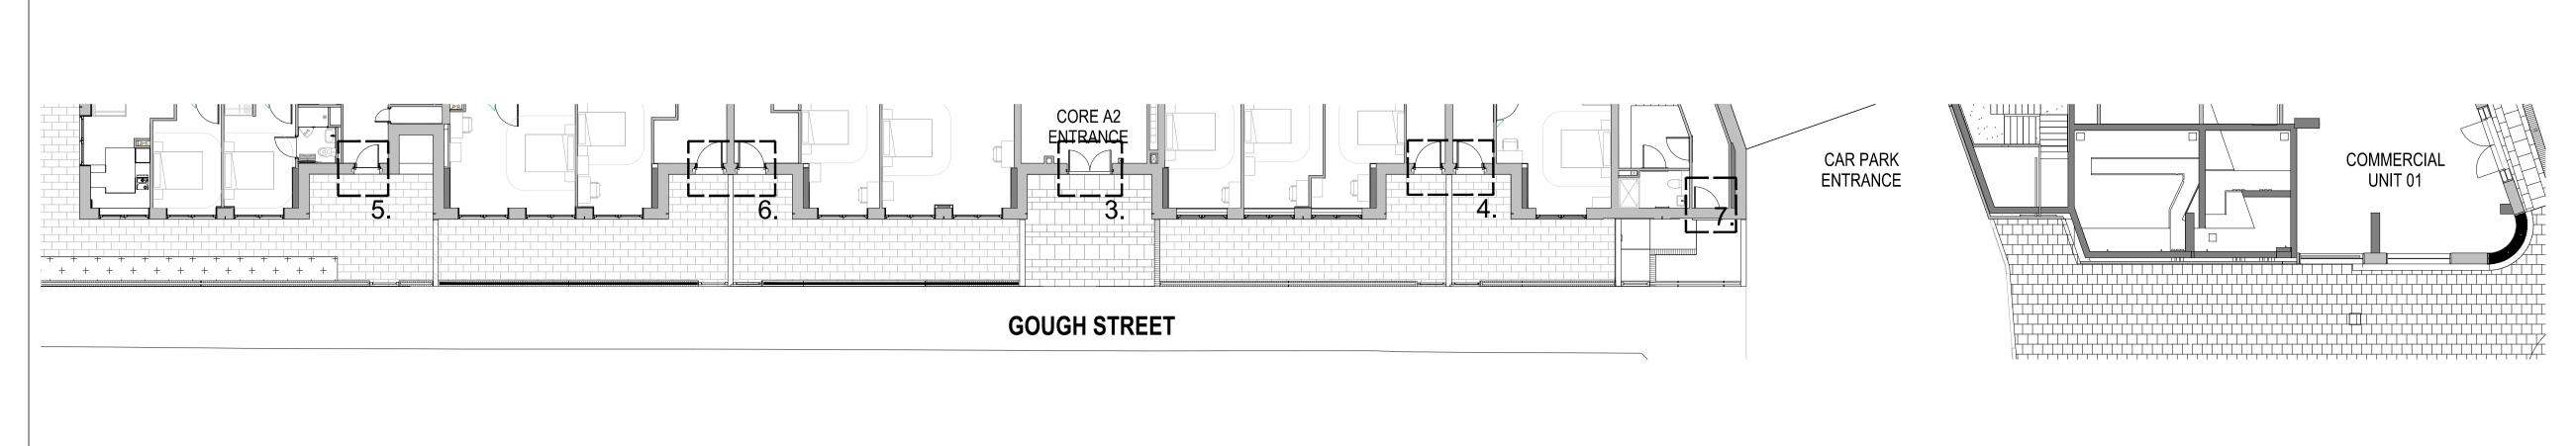


1 00 Upper Ground Level - Gough Street - Door Locations
Scale 1: 150




2 Gough Street (East) Elevation - Planning
Scale 1: 150

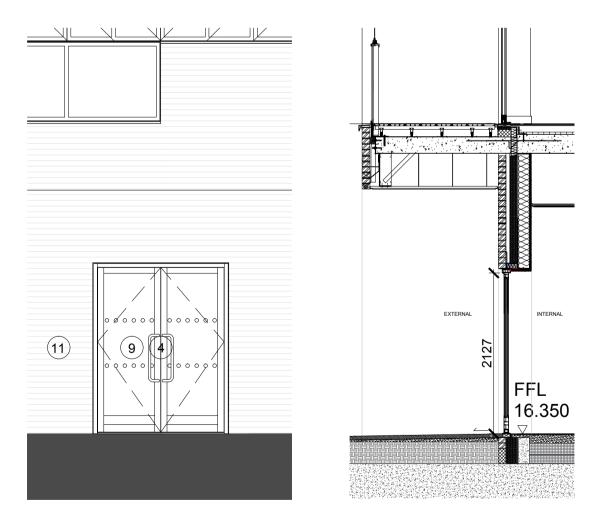




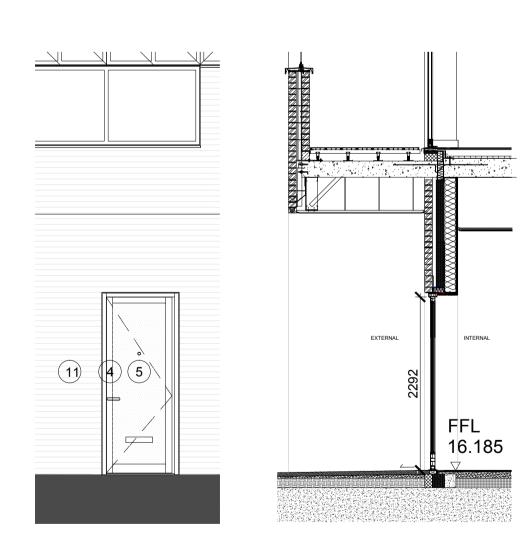


Apartment Entrance - Elevation 4 & Section
Scale 1:50

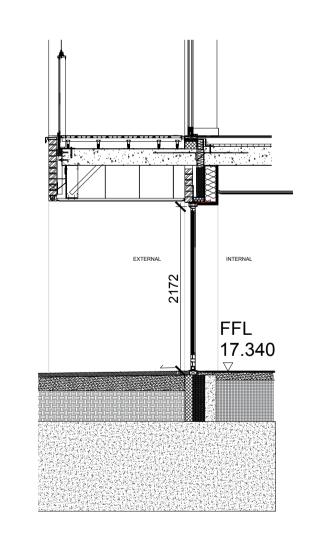

Apartment Entrance -Scale 1:50

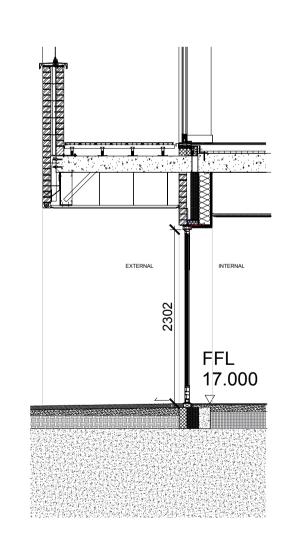

Apartment Entrance -Scale 1:50

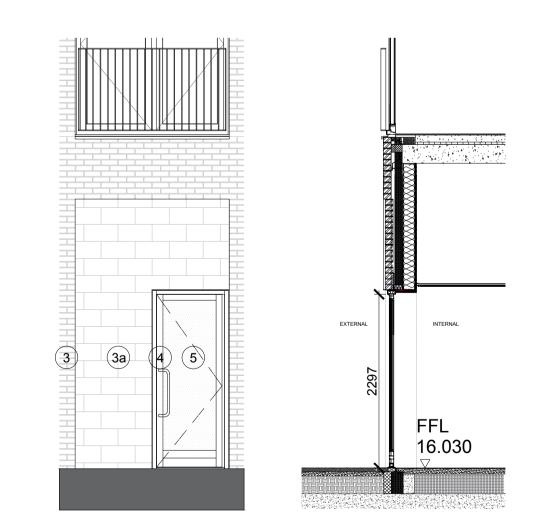


A2 Entrance (Changing Facilities) Elevation & Section Scale 1:50


MATERIALS KEY:

Reference list:

- Moleanos Limestone Cladding
- Macieira Flamed Granite plinth
- Pagus Grey Brick (3a Recessed) 4. KAWNEER AA190TB Door System within 451TB framing system. Finish - Anodised Aluminium, Anolok
- 545, Dark umber 5. Solid Door Panel. Finish - Anodised Aluminium, Anolok
- 545, Dark umber.
- 6. KAWNEER AA100 Curtain Wall. Finish Anodised
- Aluminium, Anolok 545, Dark umber 7. Vertical fin covered weather louvres. Finish - Anodised
- Aluminium, Anolok 545, Dark umber
- 8. Spandrel panels. Finish 3mm Aluminium Spandrel
- sheets Anodised Anolok 545 medium bronze 9. Clear toughened heat soaked tested glass
- 10. Aluminium Coping. Finish PPC Interpon Y2217F Steel
- Bronze 2 11. Karma White Brick

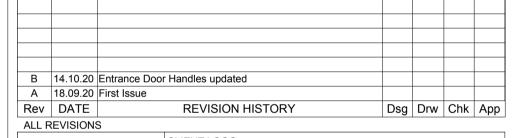



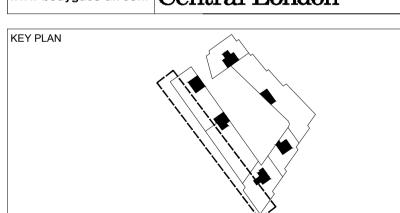

ORIGINATOR

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2 Castle Street, Castlefield, Manchester. M3 4LZ. 0161 819 2277

DRAWING TITLE


Mount Pleasant Phase 1

Gough Street Entrances

	Name	Signature	Date
Designed by	BMA	Broadway Malyan	14.10.20
Drawn by	CG	C. Grey	14.10.20
Checked	SMA	S. McAllen	14.10.20
Approved	SMA	S. McAllen	14.10.20

Approved	SIVIA	S. McAllen	14
20415		SM 50 5 MANS	
SCALE	@ A1	BIM FILE NAME	
As indi	icated		
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DATE		FROFOSED STATOS	
	9.20	FOR PLANNING	
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PROJECT	ISSUER	AREA	LEVEL	TYPE	TRADE	SEQUENCE	REV	
MP1	вма	ALL	SL	ELV	A31	905502	В	

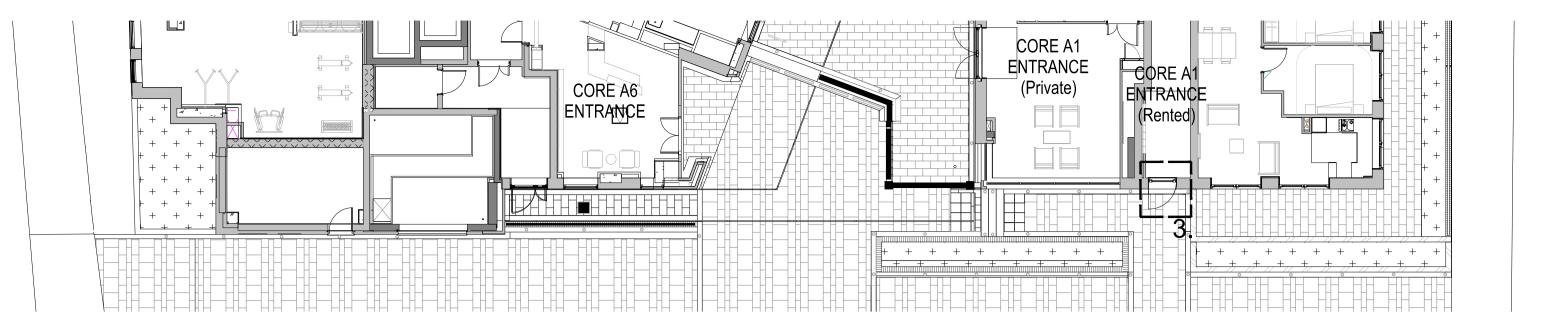


THE WALK

00 Upper Ground Level - The Walk - Door Locations
Scale 1: 150




2 The Walk (South) Elevation - Planning
Scale 1: 150

PHOENIX PLACE

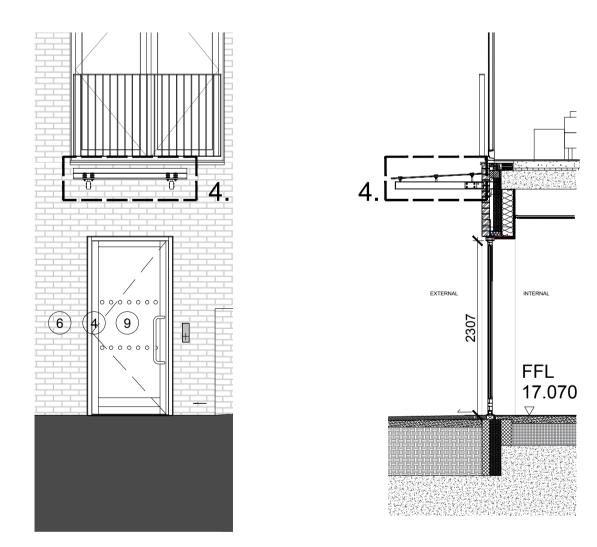

3 A1 Entrance (Affordable) - Elevation & Section

Scale 1:50

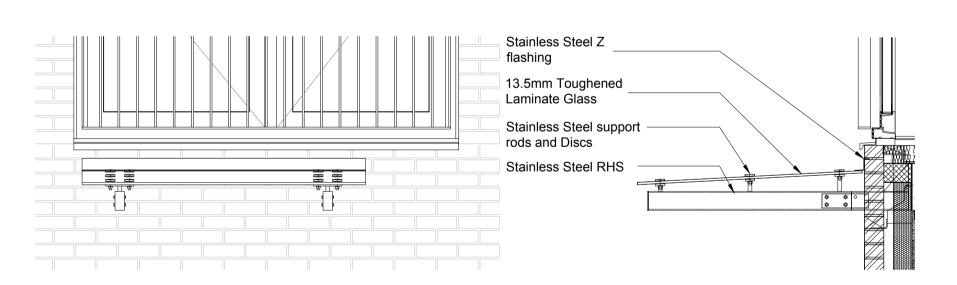

GOUGHSTREET

4 Entrance Canopy - Elevation & Section

Scale 1:20

MATERIALS KEY:

Reference list:

- Moleanos Limestone Cladding
 Macieira Flamed Granite plinth


- Pagus Grey Brick
 KAWNEER AA190TB Door System within 451TB framing system. Finish - Anodised Aluminium, Anolok 545, Dark umber
- 5. Solid Door Panel. Finish Anodised Aluminium, Anolok
- 545, Dark umber.
- 6. KAWNEER AA100 Curtain Wall. Finish Anodised Aluminium, Anolok 545, Dark umber
- 7. Vertical fin covered weather louvres. Finish Anodised
- Aluminium, Anolok 545, Dark umber 8. Spandrel panels. Finish - 3mm Aluminium Spandrel
- sheets Anodised Anolok 545 medium bronze
- 9. Clear toughened heat soaked tested glass
- 10. Aluminium Coping. Finish PPC Interpon Y2217F Steel Bronze 2

11. Karma White Brick

B 14.10.20 Entrance Door Handles updated
A 18.09.20 First Issue
Rev DATE REVISION HI Dsg Drw Chk App REVISION HISTORY ALL REVISIONS



KEY PLAN

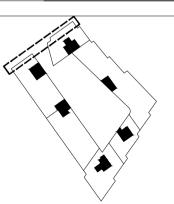



BroadwayMalyan ^{em}

2 Castle Street, Castlefield, Manchester. M3 4LZ. 0161 819 2277

DRAWING TITLE

ORIGINATOR


Mount Pleasant Phase 1

The Walk Entrances

	Name	Signature	Date
Designed by	BMA	Broadway Malyan	14.10.20
Drawn by	CG	C. Grey	14.10.20
Checked	SMA	S. McAllen	14.10.20
Annroyed	SMA	S McAllen	14 10 20

As indicated	BIM FILE NAME
	PROPOSED STATUS
18.09.20	FOR PLANNING


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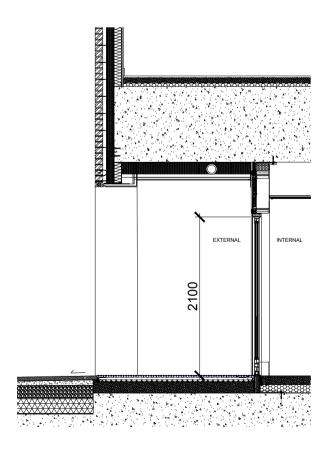


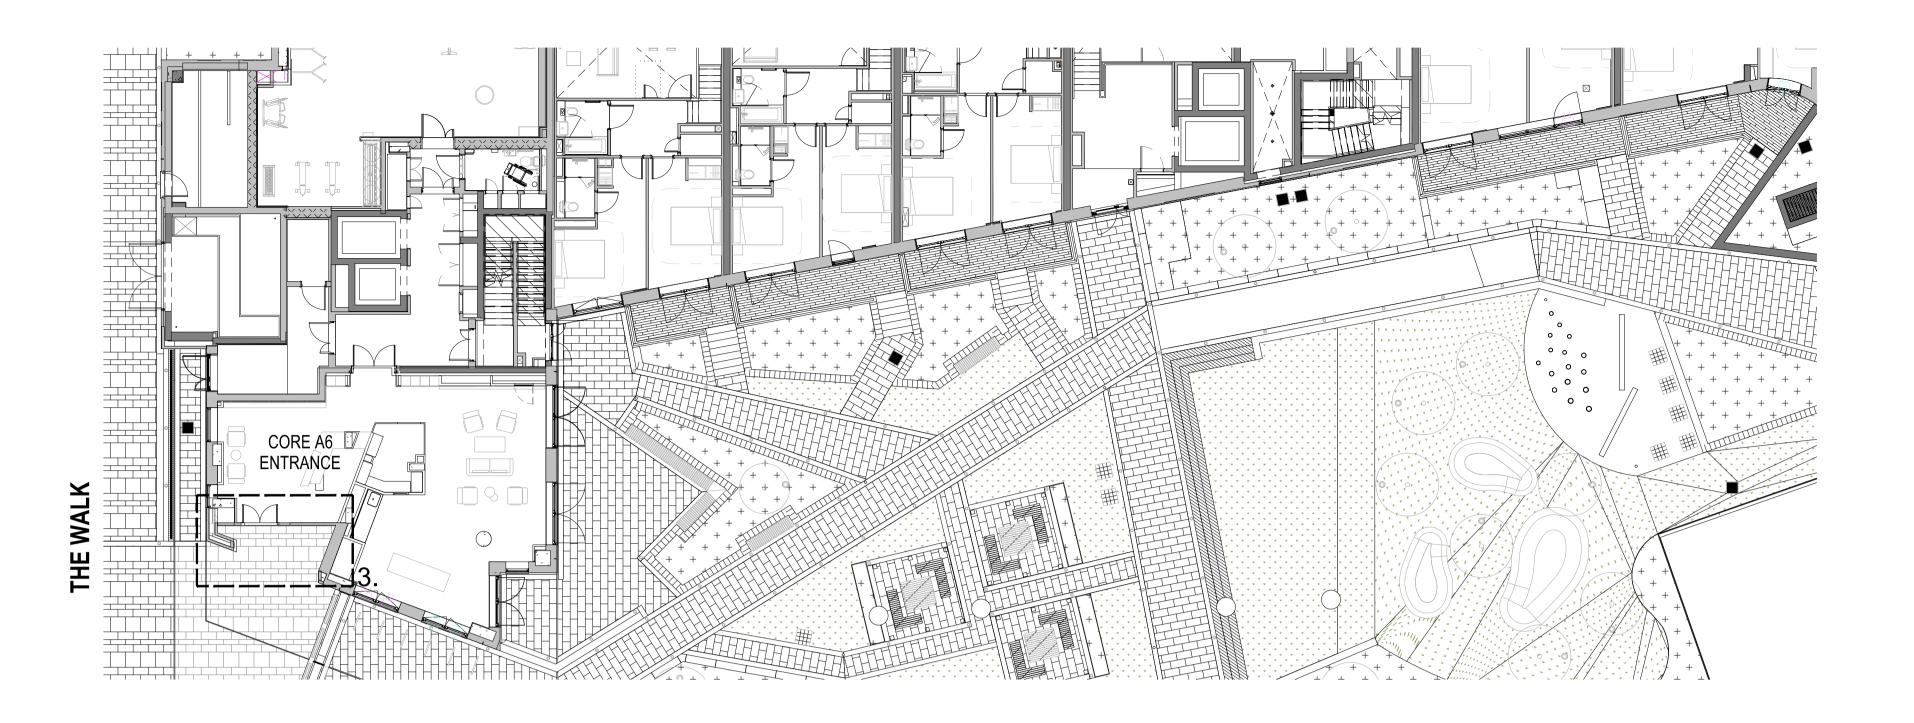00 Upper Ground Level - Courtyard East - Door Locations
Scale 1: 150



2 Courtyard East Elevation - Planning
Scale 1: 150



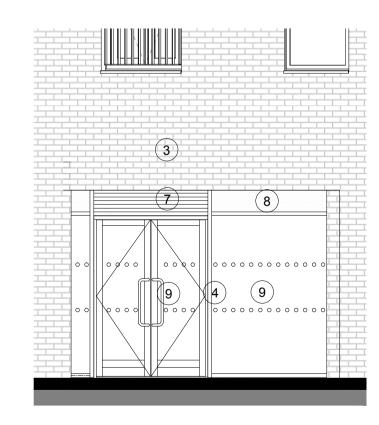

3 A6 Entrance - Elevation & Section
Scale 1:50

MATERIALS KEY:


Reference list:

- Moleanos Limestone Cladding
 Macieira Flamed Granite plinth
 Pagus Grey Brick
 KAWNEER AA190TB Door System within 451TB
- framing system. Finish Anodised Aluminium, Anolok 545, Dark umber
- 5. Solid Door Panel. Finish Anodised Aluminium, Anolok
- 545, Dark umber.
- KAWNEER AA100 Curtain Wall. Finish Anodised Aluminium, Anolok 545, Dark umber
- Vertical fin covered weather louvres. Finish Anodised Aluminium, Anolok 545, Dark umber
- 8. Spandrel panels. Finish 3mm Aluminium Spandrel sheets Anodised Anolok 545 medium bronze
- Clear toughened heat soaked tested glass
 Aluminium Coping. Finish PPC Interpon Y2217F Steel
- Bronze 2 11. Karma White Brick

B 14.10.20 Entrance Door Handles updated
A 18.09.20 First Issue
Rev DATE REVISION HI Dsg Drw Chk App REVISION HISTORY



KEY PLAN

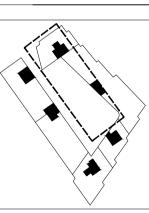

ORIGINATOR

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2 Castle Street, Castlefield, Manchester. M3 4LZ. 0161 819 2277


DRAWING TITLE

Mount Pleasant Phase 1 Courtyard East Entrances

	Name	Signature	Date
Designed by	BMA	Broadway Malyan	14.10.20
Drawn by	CG	C. Grey	14.10.20
Checked	SMA	S. McAllen	14.10.20
Approved	SMA	S. McAllen	14.10.20

As indicated @ A	1 BIM FILE NAME
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FIRST ISSUE DATE	TROI GOLD GIATOG


PROJECT	ISSUER	AREA	LEVEL	TYPE	TRADE	SEQUENCE	REV
MP1	ВМА	ALL	SL	ELV	A31	905504	В

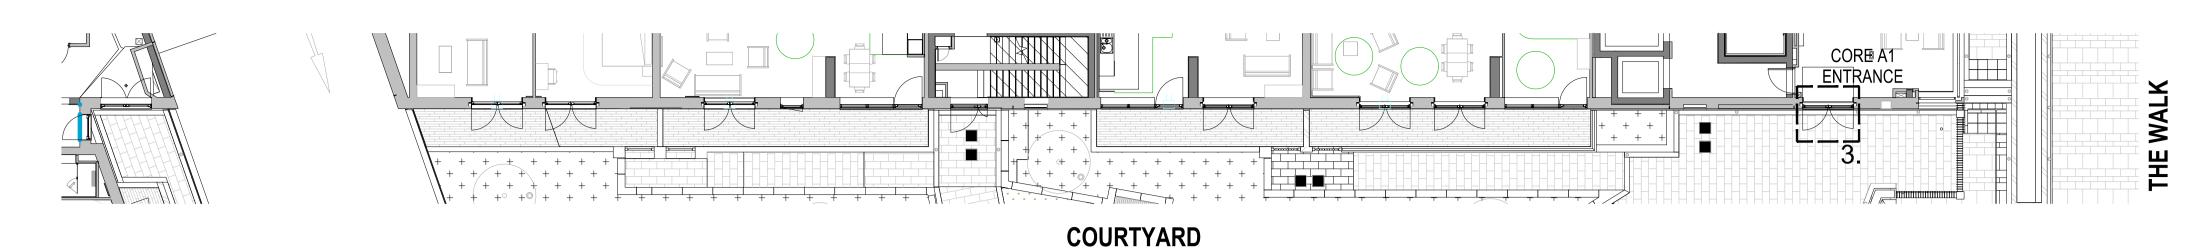

1 00 Upper Ground Level - Courtyard West - Door Locations
Scale 1: 150




2 Courtyard West Elevation - Planning
Scale 1: 150

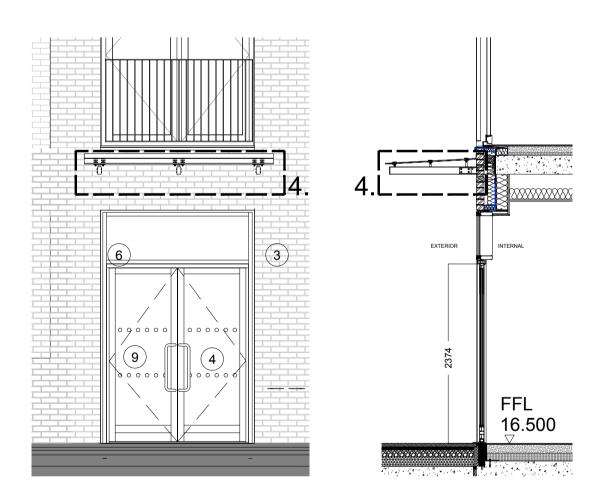

A1 Entrance (Private) - Elevation & Section

3 Scale 1:50

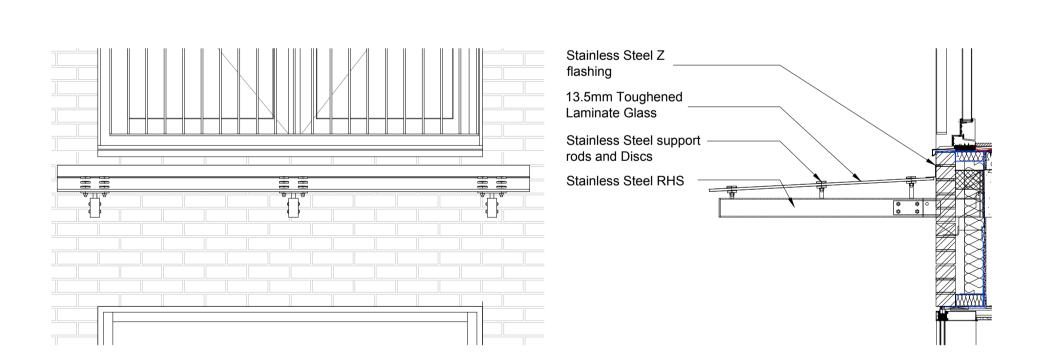

4 Entrance Canopy - Elevation & Section

Scale 1:20

MATERIALS KEY:


Reference list:

- Moleanos Limestone Cladding
 Macieira Flamed Granite plinth
- 3. Pagus Grey Brick
- 4. KAWNEER AA190TB Door System within 451TB framing system. Finish - Anodised Aluminium, Anolok 545, Dark umber
- 5. Solid Door Panel. Finish Anodised Aluminium, Anolok
- 545, Dark umber.
- 6. KAWNEER AA100 Curtain Wall. Finish Anodised Aluminium, Anolok 545, Dark umber
- 7. Vertical fin covered weather louvres. Finish Anodised
- Aluminium, Anolok 545, Dark umber 8. Spandrel panels. Finish - 3mm Aluminium Spandrel
- sheets Anodised Anolok 545 medium bronze
- 9. Clear toughened heat soaked tested glass
- 10. Aluminium Coping. Finish PPC Interpon Y2217F Steel
- Bronze 2 11. Karma White Brick

В	14.10.20	Entrance Door Handles updated					
Α	18.09.20	First Issue					
Rev	DATE	REVISION HISTORY	Dsg	Drw	Chk	App	
ALL R	ALL REVISIONS						



KEY PLAN

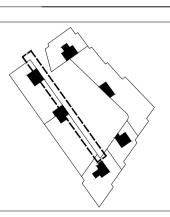



BroadwayMalyan em

2 Castle Street, Castlefield, Manchester. M3 4LZ. 0161 819 2277

DRAWING TITLE

Mount Pleasant Phase 1

Courtyard West Entrances

	Name	Signature	Date
Designed by	BMA	Broadway Malyan	14.10.20
Drawn by	CG	C. Grey	14.10.20
Checked	SMA	S. McAllen	14.10.20
Approved	SMA	S. McAllen	14.10.20

As indicated @ A1	BIM FILE NAME
FIRST ISSUE	PROPOSED STATUS
18.09.20	FOR PLANNING

PROJECT	ISSUER	AREA	LEVEL	TYPE	TRADE	SEQUENCE	REV	
MP1	вма	ALL	SL	ELV	A31	905505	В	

Condition 12 - Materials

BroadwayMalyan[™]


Typical Entrance Door Details

The following page (12) contains typical details and materiality of the three main types of entrance doors found in the scheme.

- 1 Typical Solid Entrance Door Head and Threshold Details
- 2 Typical Glazed Entrance door with Solid Spandrel Head and Threshold Details
- 3 Typical Glazed Entrance Door Head and Threshold Details

Typical Entrance Door Elevation


Page 13 contains a typical entrance door elevation and horizontal section. Further detail is provided on the specification of Door Handles to all main entrance doors, both Communal and Commercial.

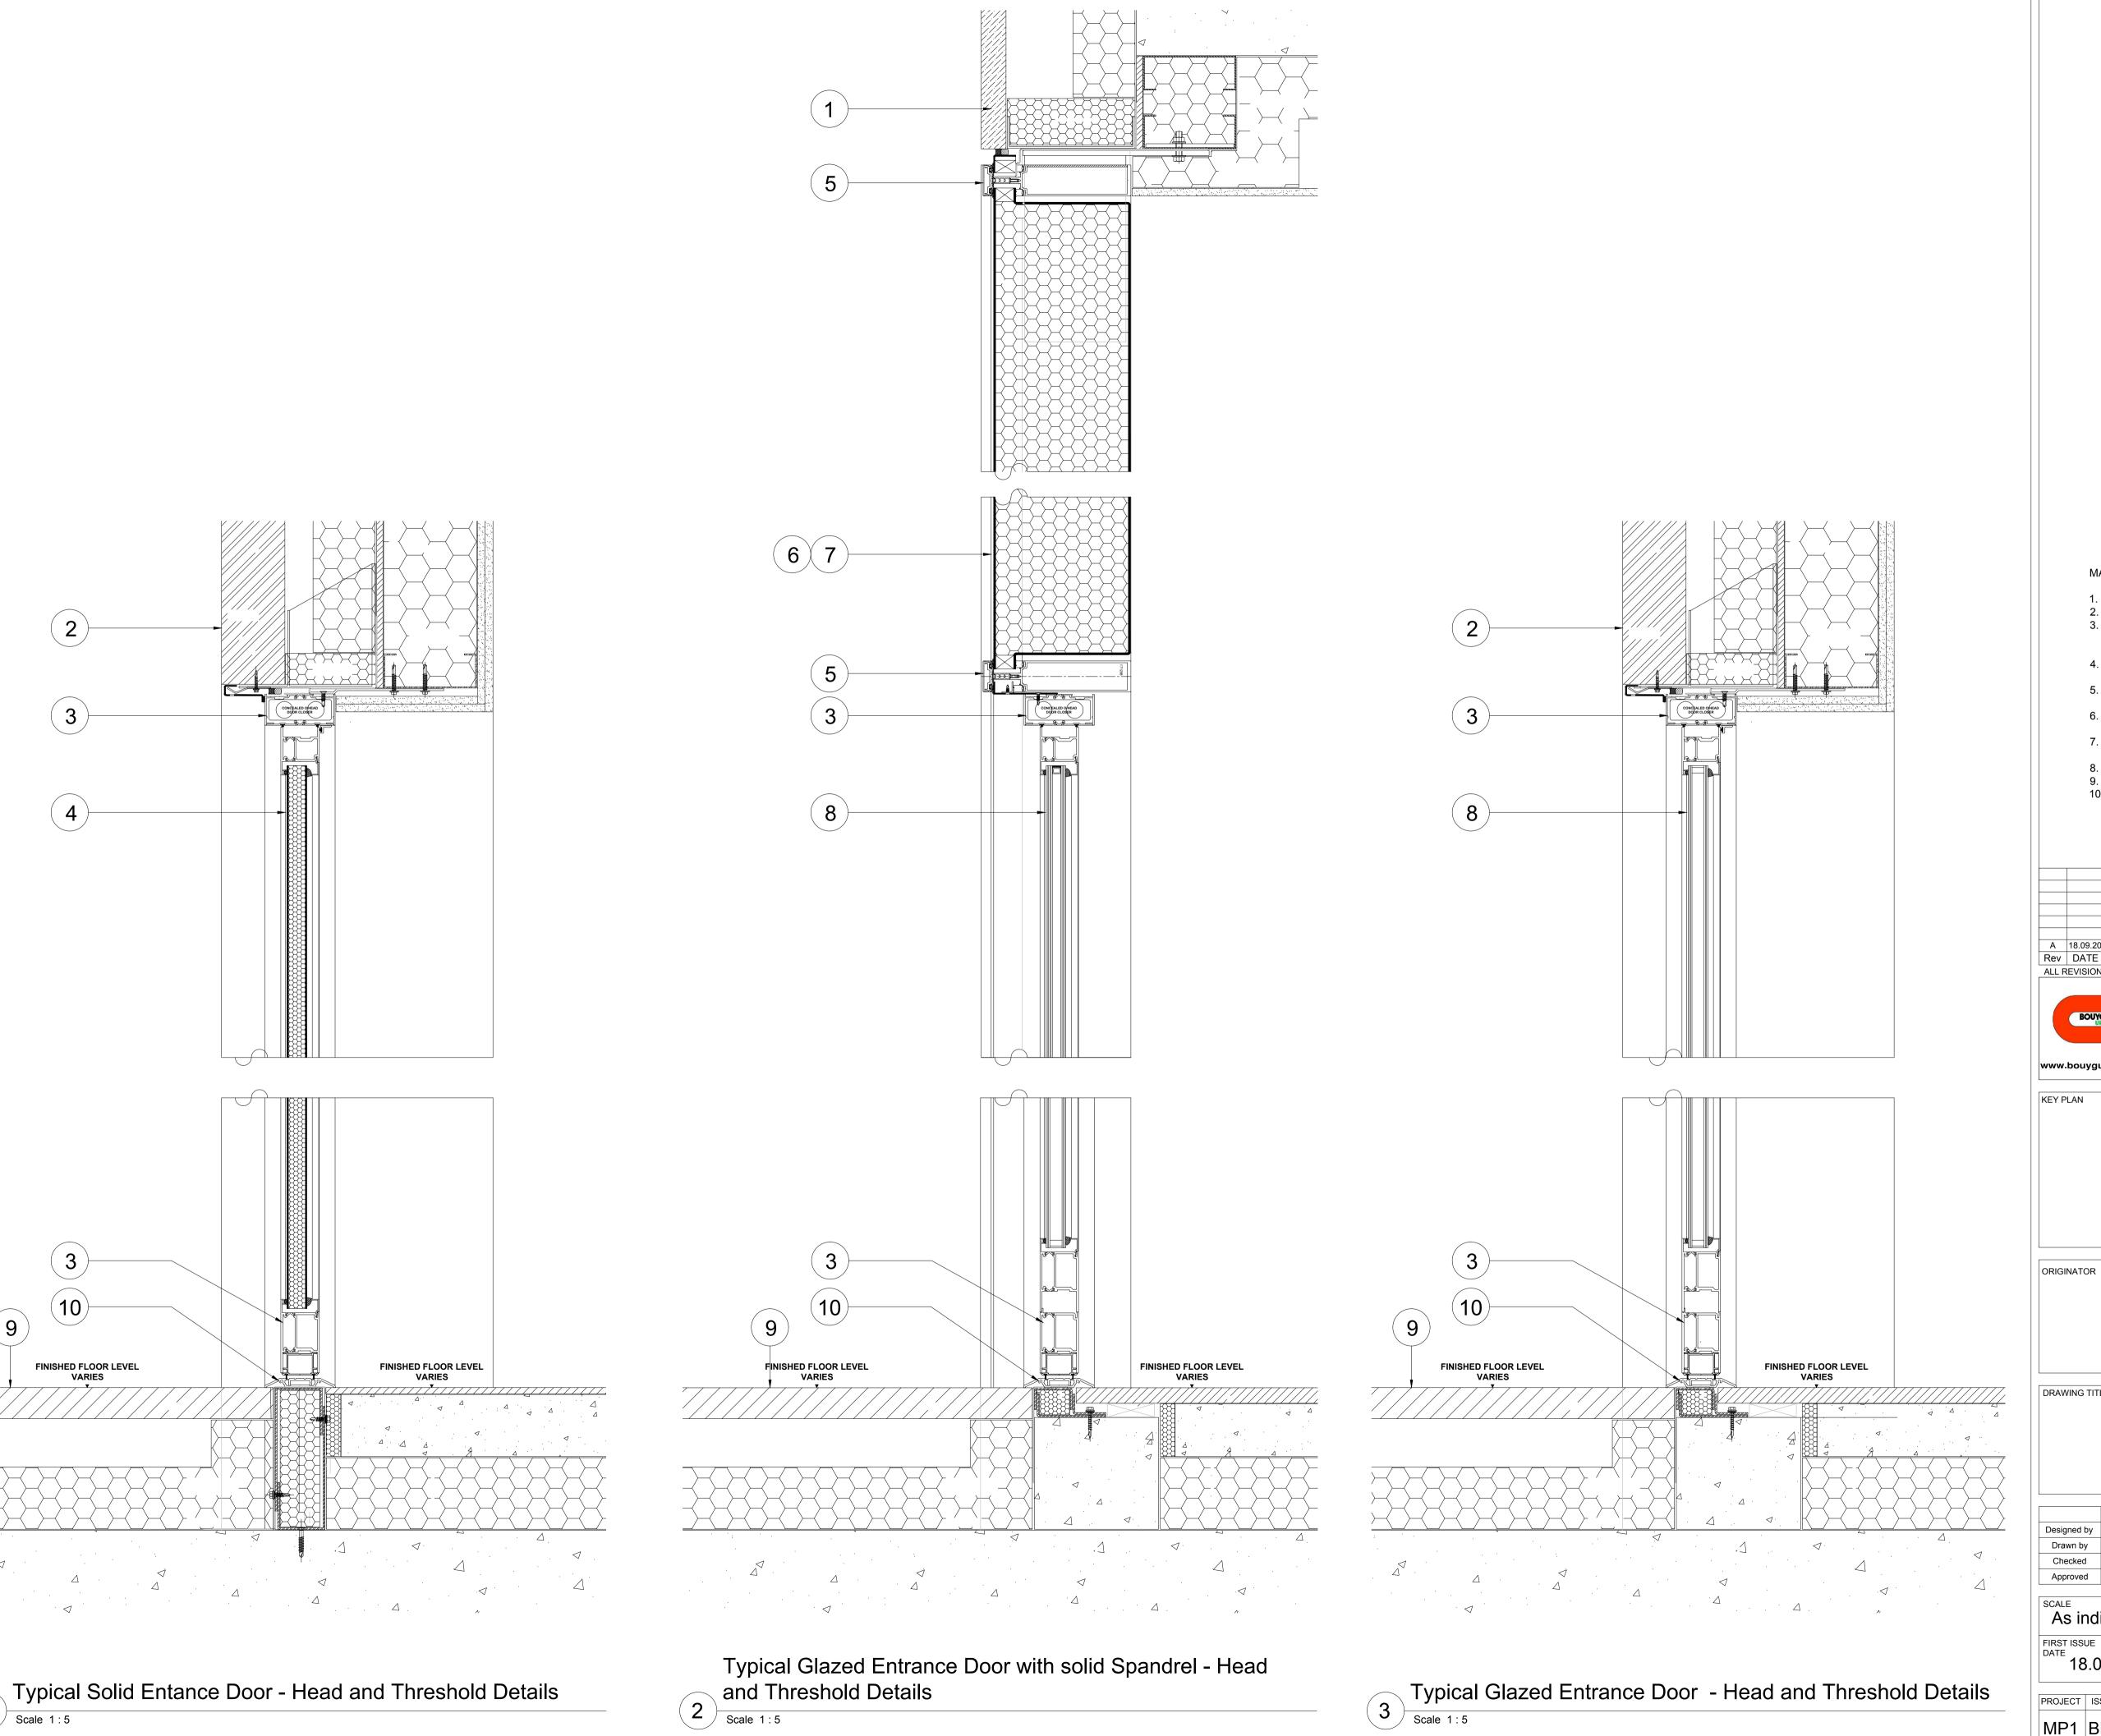

MATERIALS KEY:

Reference list:

- Moleanos Limestone Cladding
- Pagus Grey Brick
 KAWNEER AA190TB Door System within 451TB framing system. Finish - Anodised Aluminium, Anolok 545, Dark umber
- 4. Solid Door Panel. Finish Anodised Aluminium, C33
- Bronze Anodised
- 5. KAWNEER AA100 Curtain Wall. Finish Anodised Aluminium, Anolok 545, Dark umber
- 6. Vertical fin covered weather louvres. Finish Anodised Aluminium, Anolok 545, Dark umber
- Spandrel panels. Finish 3mm Aluminium Spandrel sheets - Anodised Anolok 545 medium bronze
- 8. Clear toughened heat soaked tested glass9. 50mm Granite Magma Paver
- 10. KAWNEER Threshold Section Finish Silver Anodised

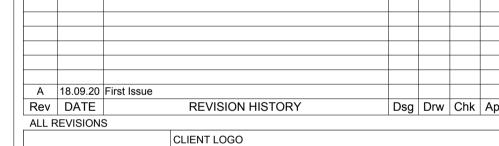

Taylor Wimpey
www.bouygues-uk.com
Central London



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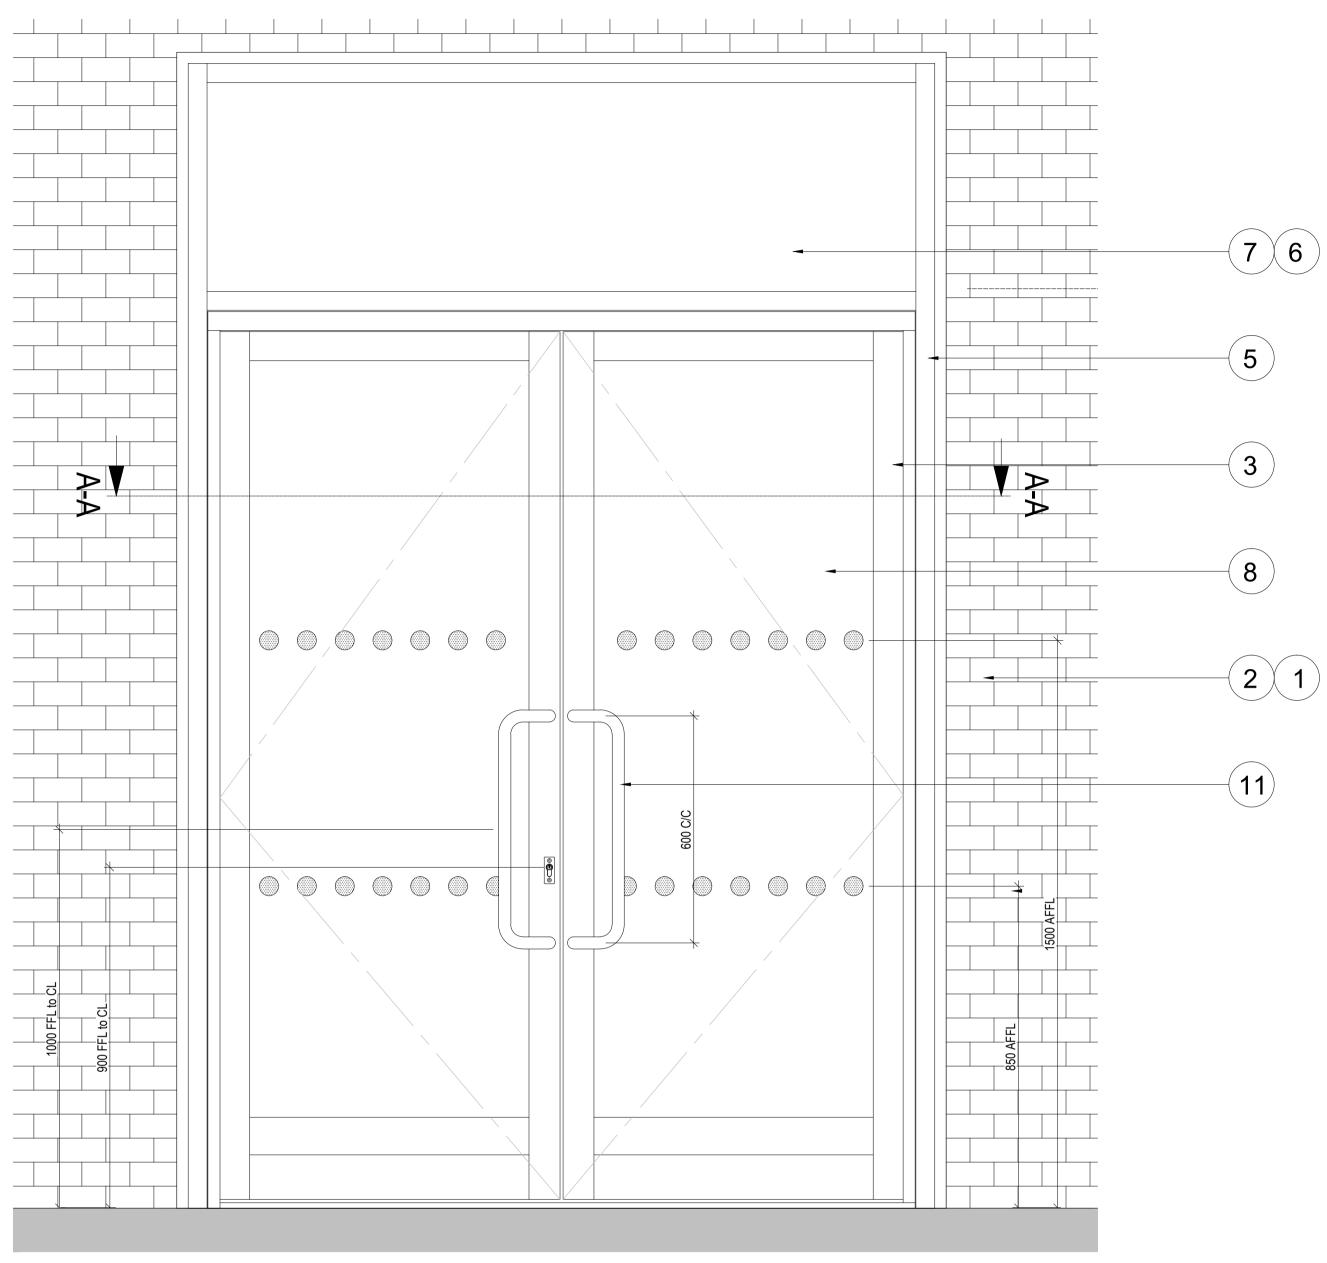
DRAWING TITLE

Mount Pleasant Phase 1 Typical Entrance Door Details


	Name	Signature	Date
Designed by	BMA	Broadway Malyan	18.09.20
Drawn by	CG	C. Grey	18.09.20
Checked	SMA	S. McAllen	18.09.20
Approved	SMA	S. McAllen	18.09.20

As indicated @ A1	BIM FILE NAME
FIRST ISSUE	PROPOSED STATUS
18.09.20	FOR PLANNING
10.00.20	

MP1 BMA ALL SL ELV A31 932500 A



Typical Main Entance Door Elevation Scale 1:10

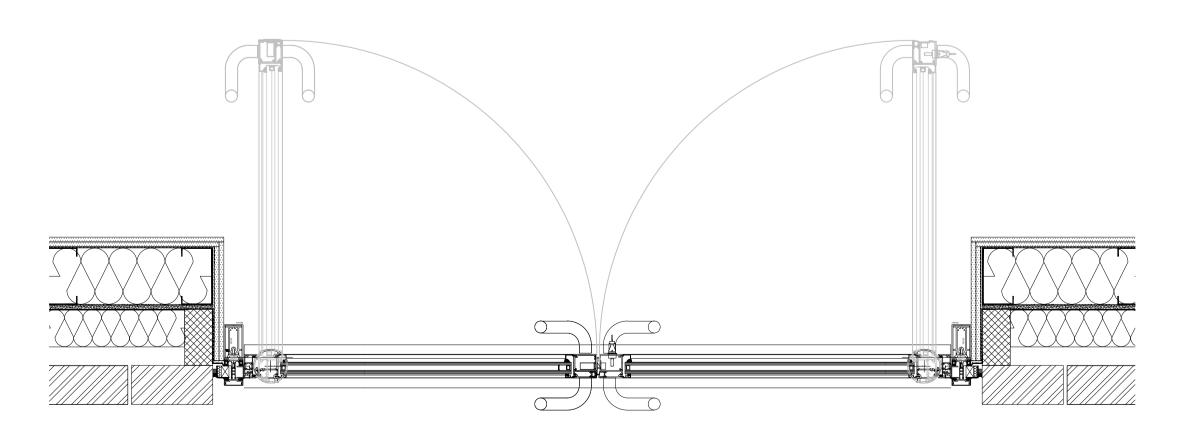

All Door handles to Main Entrances (Communal & Commercial) to be ASH 103 32Ø Satin Stainless Steel cranked pull handles (D handles) both Externally and Internally. Vertical set out principles of Iron Mongery can be seen opposite.

Stainless Steel D Handles were chosen for their high contrast with the background materials used for the main entrance doors.


Stainless Steel D Handle

3 Scale 1:10

MATERIALS KEY:


Reference list:

- Moleanos Limestone Cladding
 Pagus Grey Brick
 KAWNEER AA190TB Door System within 451TB framing system. Finish Anodised Aluminium, Anolok
- 545, Dark umber
- 4. Solid Door Panel. Finish Anodised Aluminium, C33 **Bronze Anodised**
- 5. KAWNEER AA100 Curtain Wall. Finish Anodised
- Aluminium, Anolok 545, Dark umber 6. Vertical fin covered weather louvres. Finish - Anodised
- Aluminium, Anolok 545, Dark umber
- 7. Spandrel panels. Finish 3mm Aluminium Spandrel
- sheets Anodised Anolok 545 medium bronze
- 8. Clear toughened heat soaked tested glass9. 50mm Granite Magma Paver
- 10. KAWNEER Threshold Section Finish Silver Anodised
- 11. ASH 103 32Ø satin stainless steel cranked pull handles both Externally and Internally

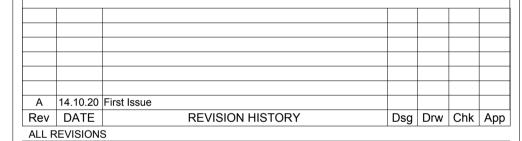

CLIENT LOGO Taylor Wimpey
www.bouygues-uk.com
Central London

KEY PLAN

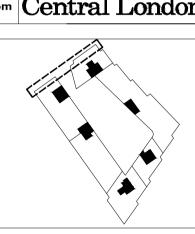

ORIGINATOR

BroadwayMalyan em

2 Castle Street, Castlefield, Manchester. M3 4LZ. 0161 819 2277

DRAWING TITLE

Typical Entrance Door Elevation

Mount Pleasant Phase 1

	Name	Signature	Date
Designed by	BMA	Broadway Malyan	14.10.20
Drawn by	CG	C. Grey	14.10.20
Checked	SMA	S. McAllen	14.10.20
Approved	SMA	S. McAllen	14.10.20

As indicated	A1	BIM FILE NAME
FIRST ISSUE		PROPOSED STATUS
14.10.20		FOR PLANNING

MP1 BMA ALL SL ELV A31 932501 A

Typical Main Entance Door Horizontal Section A-A