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27 John Street

Application: 2020/2685/L

Discharge of Conditions Condition 4a



Condition 4c

SERVICE ROUTE STRATEGY

Vertical Route:

Two existing risers are already in place. These run the entire height of the building. The riser on the party wall with No.26 will be used predominantly to serve bathrooms. Additionally there is an existing SVP on the rear elevation of the house.

Basement:

Existing 650 wide x 175 deep service trench. To be re-used to take all piped and electrical services.

Ground floor:

All services run in the direction of the joists towards service risers. No joists will need to be cut.


1st 2nd and 3rd Floors.

The floor structure is comprised of a double system of 100 x 70 joists running perpendicular to 220 x 100 primary joists. The majority of services will run in the 100x70 zone. The deeper joist zone below allows for any crossovers below the 100x70 joists. Services never need to cross the 290x215 timber beams. No joists will need to be cut. Vertical routes will be shared between the existing internal riser and external SVP on the rear elevation.

4th Floor:

Where services cross joists they will run at high level on the 3rd floor below a dropped ceiling in the 3rd floor bathrooms. Services will then connect to the existing internal riser. No joists will need to be cut.


REFER TO PAGE 8 FOR DETAILS OF ALL FLOORS.

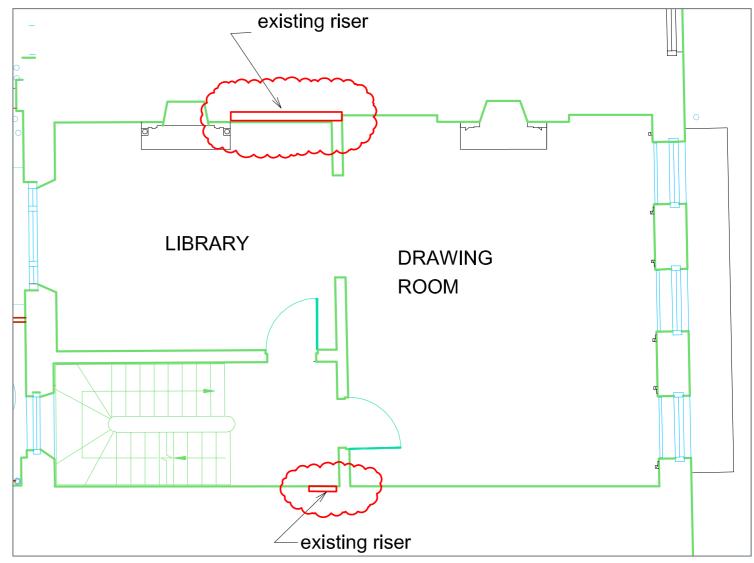


Internal Riser Locations

Condition 4c

BASEMENT

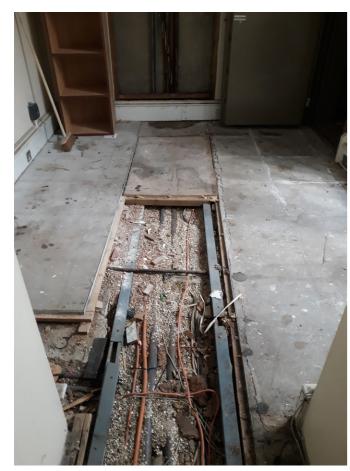


Photograph of the existing service trench in the basement slab

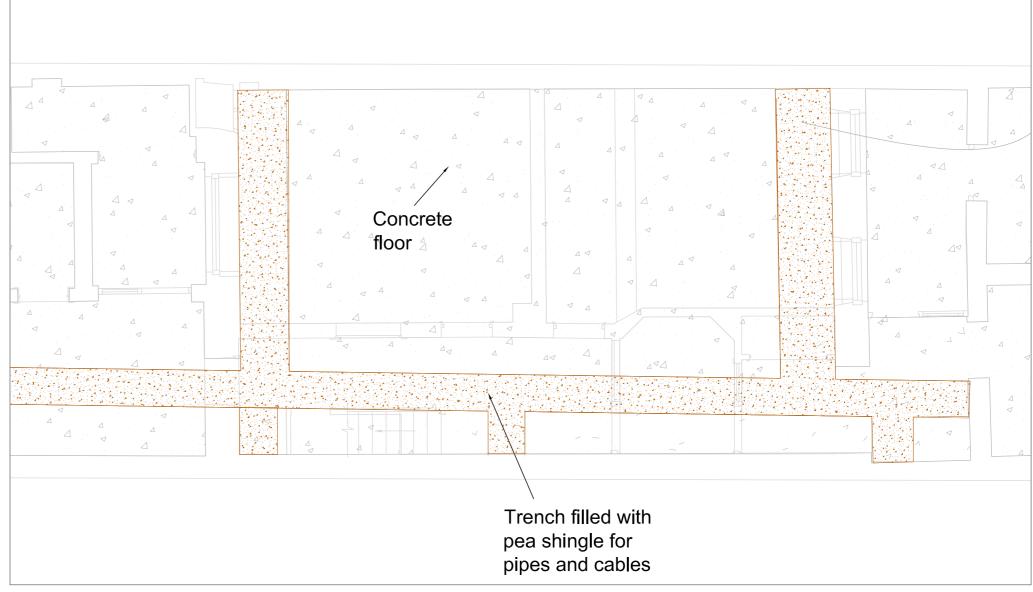

Basement floor

Condition 4c

1st, 2nd & 3rd FLOOR TYPICAL JOIST ARRANGEMENT

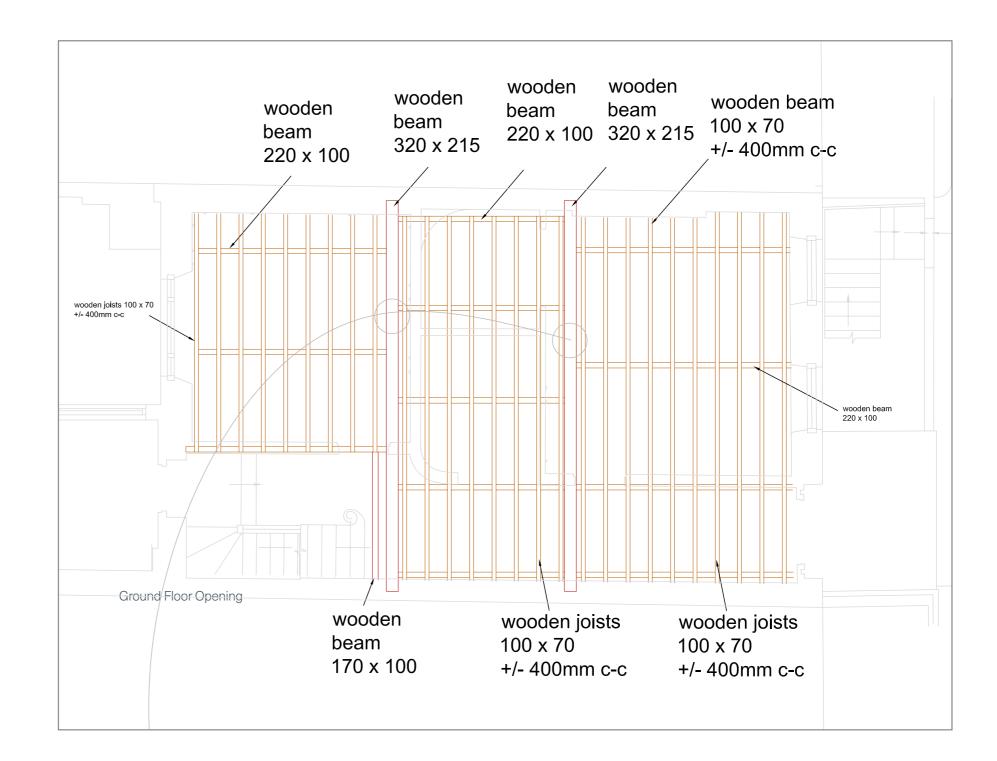



Note:

Final, accurate dimensions are to be confirm on site and setting out. Do not scale from drawing.

SCALE 1:10



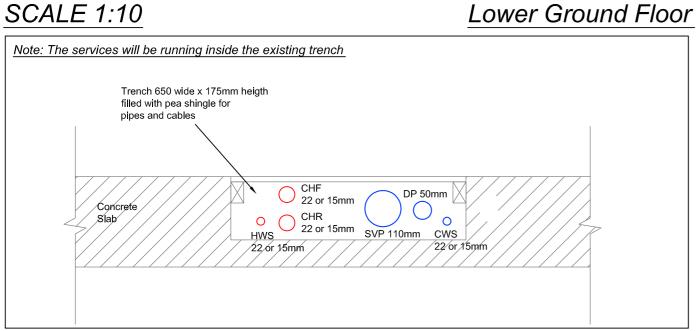

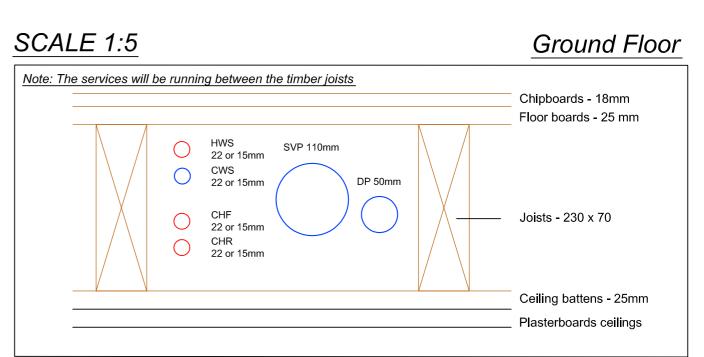



SCALE 1:5

PROPOSED

1st / 2nd / 3rd Floors

SCALE 1:5

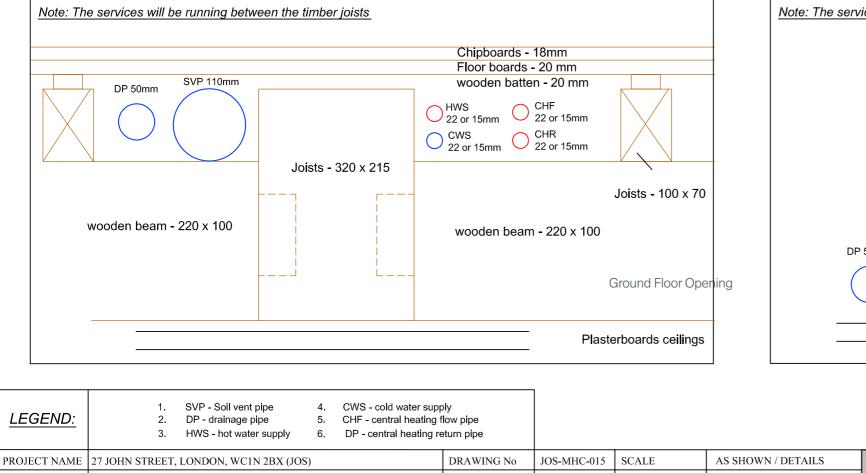

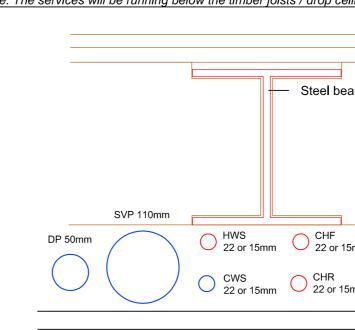

he services will be running between the timber joists	Note: The services will be running below the timber joists / drop ceilings
wooden beam - 220 x 100 wooden beam - 220 x 100	Chipboards - 18mm Floor boards - 20 mm Steel beam - 205 x 205 Joists - 220 x 50 DP 50mm DP 50mm HWS 22 or 15mm CHF 22 or 15mm CHR Steel beam - 205 x 205 CHF 22 or 15mm CHF 22 or 15mm CHR Steel beam - 205 x 205 CHF 22 or 15mm CHR Steel beam - 205 x 205 CHF 22 or 15mm CHR Steel beam - 205 x 205 CHF 22 or 15mm CHR Steel beam - 205 x 205 CHF Steel beam - 205 x 205 CHR Steel beam - 205 x 2
Plasterboards	rds ceilings
1.SVP - Soil vent pipe4.CWS - cold water supply2.DP - drainage pipe5.CHF - central heating flow pipe3.HWS - hot water supply6.DP - central heating return pipe	
E 27 JOHN STREET, LONDON, WC1N 2BX (JOS) DRAWING No JOS-MHC-015 SCALE	
DETAILS - DRAINAGE/HEATING/GOLD AND HOT WATER SUPPLY DATE OF ISSUE 05.06.2020 REVIEW	IEWED BY: A/S F +44 (0)20 8452 6314

4th Floor