
Stage 3 Drawing

Rev	Date	Description	Drawn	Checked
P1	06.08.18	For Comment	RS	CG
P2	29.10.18	For Comment	RS	CG
Р3	07.03.19	For Comment	ES	CG
P4	05.04.19	Updated	ES	CG

This scheme is based on limited opening up works of the existing structure. All assumptions subject to confirmation during next stage

Proposed Beam Schedule		
Ref.	Serial Size	
B1	203x133x25 UKB	
B2	356x171x45 UKB	
В3	457x191x74 UKB	
B4	533x210x92 UKB	
B5	203x203x46 UKC	
B6	254x254x89 UKC	
B7	305x305x118 UKC	
B8	356x368x177 UKC	
B9	356x406x467 UKC	
B10	152x152x30 UKC	
B11	200x90x30 PFC	

Key: --- Indicates line of structure under Indicates approximate position of crank in steelwork ESB Indicates an Existing Steel Beam 381x127 (BSB 25) ETB Indicates an Existing Timber Beam 300x100 centre, 225 x 100 otherwise Unless noted otherwise, allow for 450x215x215mm deep mass concrete padstones under all beams M&E Allow for new steelwork to support new mechanical plant on existing roof. Allow 250kg

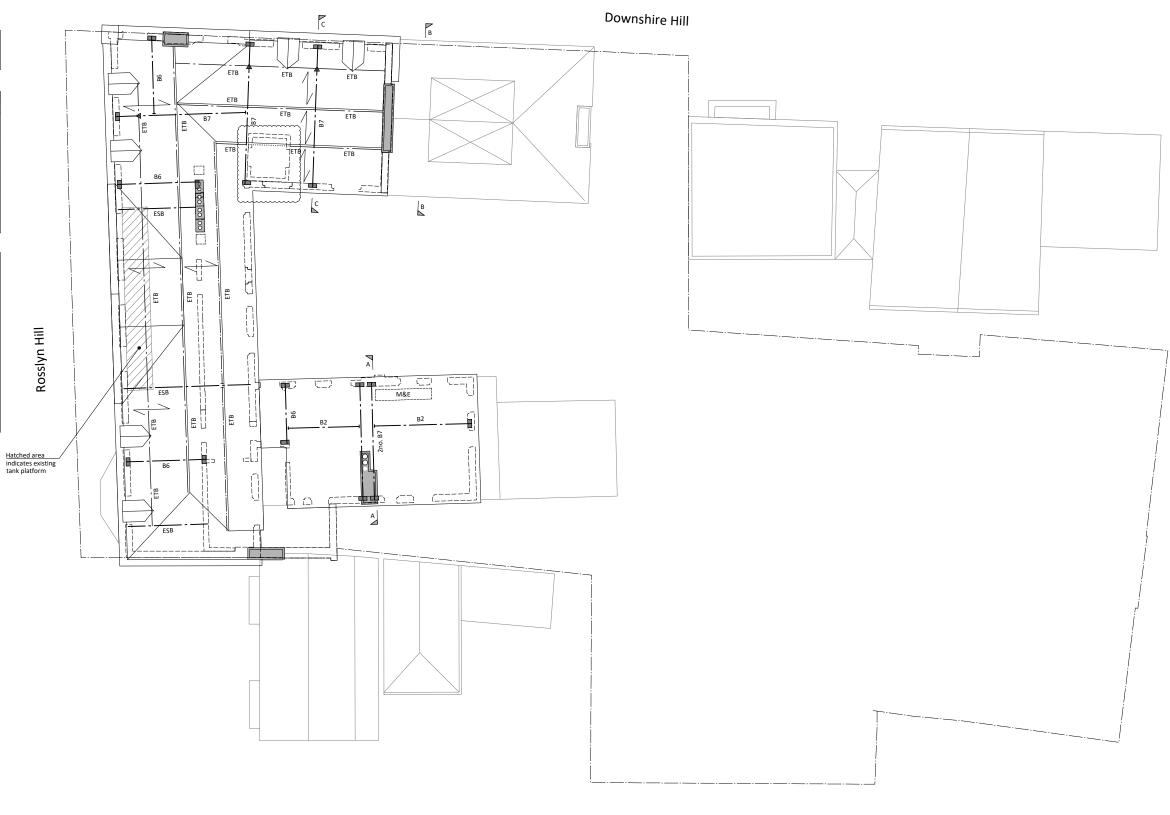

PRELIMINARY NOT FOR CONSTRUCTION

Roof Structual Engineering Plan

Abacus Belsize Primary School, NW3

Client ESFA Job No. 4343 Drawing No.

1:100 at A1

SCALE 1:100 0 5