

### **APPENDIX F**

## **Ground Investigation Results**

Figure GI-01 Borehole & Trial Pit Location Plan

### Oakland Site Investigation Ltd

- Windowless Sample Log Borehole BH1
- Trial Pit Sketches TP1 & TP2

### Geolabs Ltd

Laboratory Test Results - (Ref: GEO/30889):

- Summary of Liquid & Plastic Limit Tests
- Summary of Chemical Tests on Soil

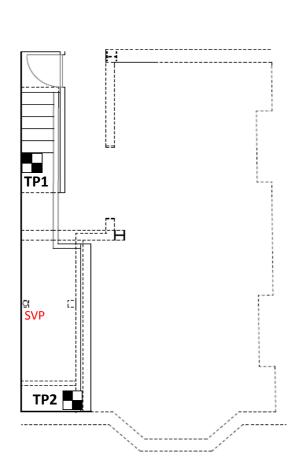
GGC20807/R1 July 2020

### 46 Agamemnon Road, London, NW6 1EN

Ground Floor



GGC20807



# **Cellar Plan**

### Notes:

1. BH1 installation is concealled under a paving slab.



Borehole location & number



TP1 Trial pit location & number

Agamennon Road

**BH1** 

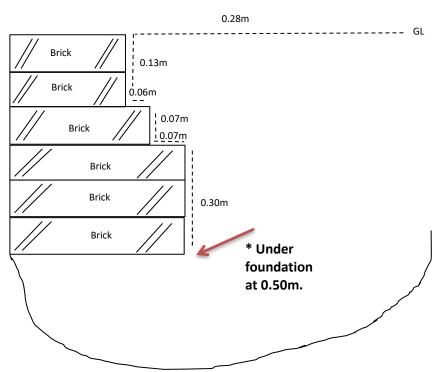
**Ground Floor Plan** 

Bin store (removable)

**Borehole and Trial Pit Location Plan** GI-01 Title: Figure:

Date: March 2020 Checked: KRG Approved: KRG Scale: NTS

ASA	OAKL	AND								_			Location No		
	site invest	tigation					Wir	ndov	vless	San	BH1				
Project	:		Agam	emnor	า Road								Date		
Project	No:		4907										20/03/2020		
Locatio	n:		BH1										Logged By		
Client:			Josh Rosen							RS					
		ı		u Test					Hand	Pen	D 4 l-				
Depth	Туре	Sea	iting		Main			 "N"	D 11	1 (1 /	Depth (m)	Stratum Descr	iption		
(m)	Турс	1	2	1	2	3	4		Depth (m)		(111)				
1.0	SPT	1	2	2	2	2	3	9	(***)		0				
2.0	SPT	2	1	2	2	3	3	10				Concrete sl	ab		
3.0	SPT	1	2	2	3	4	3	12							
4.0	SPT	2	4	4	5	5	6	20			0.04	CONCRET	E		
5.0	SPT	2	3	3	3	4	5	15			0.04	Fine to course fragments of ar	ngular to subrounde		
6.0	SPT	2	3	3	4	4	5	16				concrete and fine to medium	_		
7.0	SPT	3	3	4	4	5	6	19				to subrounded	brick.		
8.0	SPT	3	4	4	4	4	5	17			0.15	MADE GROUND			
											0.15	Course yellow sand with fine t	o medium fragmen		
												of round to subrou	nded brick.		
			Sa	mpling	5						0.20	MADE GROU	JND		
Dept	oth (m) Type Soil Type					0.20	Soft to firm brown very sand	ly gravelly clay with							
0.3		ĺ								frequent roots (<4mm) and	frequent roots (<4mm) and rootlets. Sand is				
			D MADE GROUND									medium to course. Gravel is			
	0.5											medium fragments of bri	medium fragments of brick and concrete.		
C	0.5 D MAD		DE GRO	DUND				0.40	MADE GROU	JND					
	0		D			CLAY					0.40	Firm to stiff orangish brown			
	5		D CLAY									with occasional blue mottling.			
			D	CLAY							2.70	CLAY			
2.5			D			CLAY					2.70	Stiff orangish brown slightly s	andy slightly gravell		
			_			G. 4.V						CLAY with occasional blue m			
3	3.0		D			CLAY						Gravel is fine to medium ang	gular to subangular.		
3	3.5		D			CLAY					3.05	CLAY			
4	1.0		D			CLAY					3.05	Stiff orangish brown slightl	y sandy CLAY with		
4	l.5		D			CLAY						occasional blue mottling. Sar			
5	5.0		D			CLAY						fine to medium seloni	te fragments.		
5	5.5		D			CLAY					5.00	CLAY			
$\epsilon$	5.0		D			CLAY					5.00	Very stiff orangish brown sligh	ntly candy CLAV San		
$\epsilon$	5.5		D			CLAY	CLAY					Very stiff orangish brown sligh is fine. Orangish yellow sand			
	'.0		D			CLAY							, , , , , , , , , , , , , , , , , , , ,		
	7.5		D			CLAY					7.30	CLAY			
8	3.0		D	No	tes	CLAY				1	7.30	Very stiff bluish grey sandy	CLAY Sand is fine		
Hand d	ug pit to	1.20n	n.	140							8.00	Very sum blaisin grey sallay			
	ed with a			5m. Be	entonit	e seal	betwe	en							
4.5 - 4r	n. Install	at 4m	(1m P	lain / 3	3m Slot	tted pi	pe). H	ole dry				End of bore	nole		



Log

**0.00 - 0.08m:** Concrete (CONCRETE)

**0.08 - 0.50m:** soft to firm brown sandy clay with abundant fine to

medium fragments of brick and concrete. Sand is coarse.

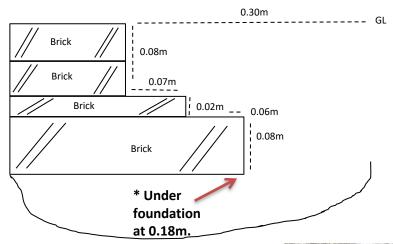
(MADE GROUND)

Sample: Disturbed at 0.50m (MADE GROUND)





Project: Agamemnon Road T					Trial Pit 1 Sketch						
Client:	Josh Rosen				Unit 13,	100 of the					
Ref No:	4907 <b>Revision</b> : 1				Firsland Park Estate, Henfield Road,		OAKLAND				
Drawn: RS Date:		31/03/2020		Albourne,		site investigation					
Figure:	1	Scale:	Not to scale		West Sussex,						



Log

0.00 - 0.08m: Concrete (CONCRETE)

**0.08 - 0.50m:** soft to firm brown sandy clay with abundant fine to

medium fragments of brick and concrete. Sand is coarse.

(MADE GROUND)

Sample: Disturbed at 0.18m (MADE GROUND)







Project:	Agamemnon Road			Title
Client:	Josh Rosen			
Ref No:	4907	Revision:	1	
Drawn:	RS	Date:	31/03/2020	
Figure:	2	Scale:	Not to scale	

Unit 13, Firsland Park Estate, Henfield Road, Albourne, West Sussex, BN6 9.LI

Trial Pit 2 Sketch



OAKLAND site investigation

BS EN ISO 17892-12: 2018

# **SUMMARY OF LIQUID AND PLASTIC LIMIT TESTS**

Location	Depth m	Sample Ref	Sample Type	Description	Water Content	% Liquid Limit	% Plastic Limit	% Plasticity Index	% Percentage Passing 425µm	Atterberg Classification	Test Type	Sample Condition
BH1	1.00		D	Brown mottled orangish brown and dark brown slightly fine sandy silty CLAY.	32.6	~	~	~	~	~	~	~
BH1	1.50		D	Brown mottled orangish brown slightly fine sandy silty CLAY.	29.2	70	27	43	99	СН	1	1
BH1	2.00		D	Brown mottled orangish brown slightly fine sandy silty CLAY.	29.8	1	1	1	~	~	~	~
BH1	2.50		D	Brown mottled orangish brown and grey slightly fine sandy silty CLAY with rare gypsum.	30.2	~	~	~	~	~	~	~
BH1	3.00		D	Brown mottled orangish brown and grey slightly fine sandy silty CLAY with rare gypsum.	29.6	~	~	~	~	~	~	~
BH1	3.50		D	Brown mottled orangish brown and grey slightly fine sandy silty CLAY with rare gypsum.	28.9	~	~	~	~	~	~	~
BH1	4.00		D	Brown mottled orangish brown and grey slightly fine sandy silty CLAY with rare gypsum.	29.5	76	28	48	99	CV	1	1
BH1	4.50		D	Brown mottled orangish brown and grey slightly fine sandy silty CLAY with rare gypsum.	29.7	?	~	?	٧	~	~	~
BH1	5.00		D	Brown slightly fine sandy silty CLAY with rare fine gypsum.	29.0	٧	٧	?	٧	~	?	~
BH1	6.00		D	Brown slightly fine sandy silty CLAY with rare fine gypsum.	29.7	81	30	51	99	CV	1	1
BH1	7.00		D	Brown mottled orangish brown slightly fine sandy silty CLAY with rare fine gypsum.	28.6	?	?	ł	~	~	1	~
BH1	8.00		D	Dark brown slightly fine sandy silty CLAY.	26.2	68	27	41	99	СН	1	1
					ole conditi							

Test Type:

Version 1.67 - 12/03/2020

- 1 1 point 80g / 30° fall cone method.
- 2 4 point 80g / 30° fall cone method.
- 3 Non plastic determination.

Sample condition:

- 1 As Received
- 2 Air Dried
- 3 Washed & Air Dried

Checked and Approved by



S Burke - Senior Technician 06/04/2020 Project Number:

Project Name:

GEO / 30889

46 Agamemnon Road, London NW6 1EN GGC20807



Test Report By GEOLABS Limited

Bucknalls Lane, Garston, Watford, Hertfordshire, WD25 9XX

Page 1 of 1 (Ref 1586179389) 1131 - Chemical Test Summary - 30889.XLSM

# **SUMMARY OF CHEMICAL TESTS ON SOIL**

っ 🗕														
	Location	Depth m	Sample Ref	Sample Type	pH Value	Total Acid Soluble Sulphate as SO4	Water Soluble Sulphate as SO4 2:1 Water:Soil Extract	% Total Sulphur	© Water Soluble Chloride	© Water Soluble Nitrate	ھ ≥ Magnesium	% Organic Content	% Mass Loss on Ignition	% Carbonate Content
ľ	BH1	0.30		D	8.2	-	0.94	-	-	-	-	-	-	-
	BH1	1.00		D	7.8	0.016	< 0.010	0.013	-	-	-	-	-	-
	BH1	3.50		D	8.5	0.16	0.44	0.072	-	-	-	-	-	-
	BH1	5.50		D	7.9	1.1	1.4	0.29	-	-	-	-	-	-
	TP1	0.50		D	9.6	ı	0.36	i	ı	ı	1	i	ı	-

Tested by Chemtest Ltd: MCERTS / UKAS No 2183

Checked and Approved by:

S Burke - Senior Technician 14/04/2020

Project Number:

GEO / 30889

Project Name:

46 Agamemnon Road, London NW6 1EN GGC20807

**GEOLABS** 



# **APPENDIX G**

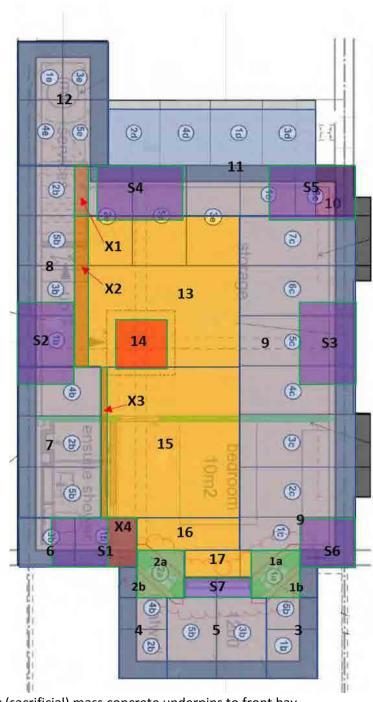
PDISP Heave/Settlement Analysis Figures G1 - G6

GGC20807/R1 July 2020

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#### Key:

Green zones (1a & 2a) = temporary (sacrificial) mass concrete underpins to front bay.

Blue zones (1b, 2b & 3 to 12) = underpins and RC retaining walls.

Orange zones = correction for varying depths of excavation, within a zone or straddling more than one zone. Purple zones (S1 - S7) = Superimposed point loads and load from completed bay on Zone 5.

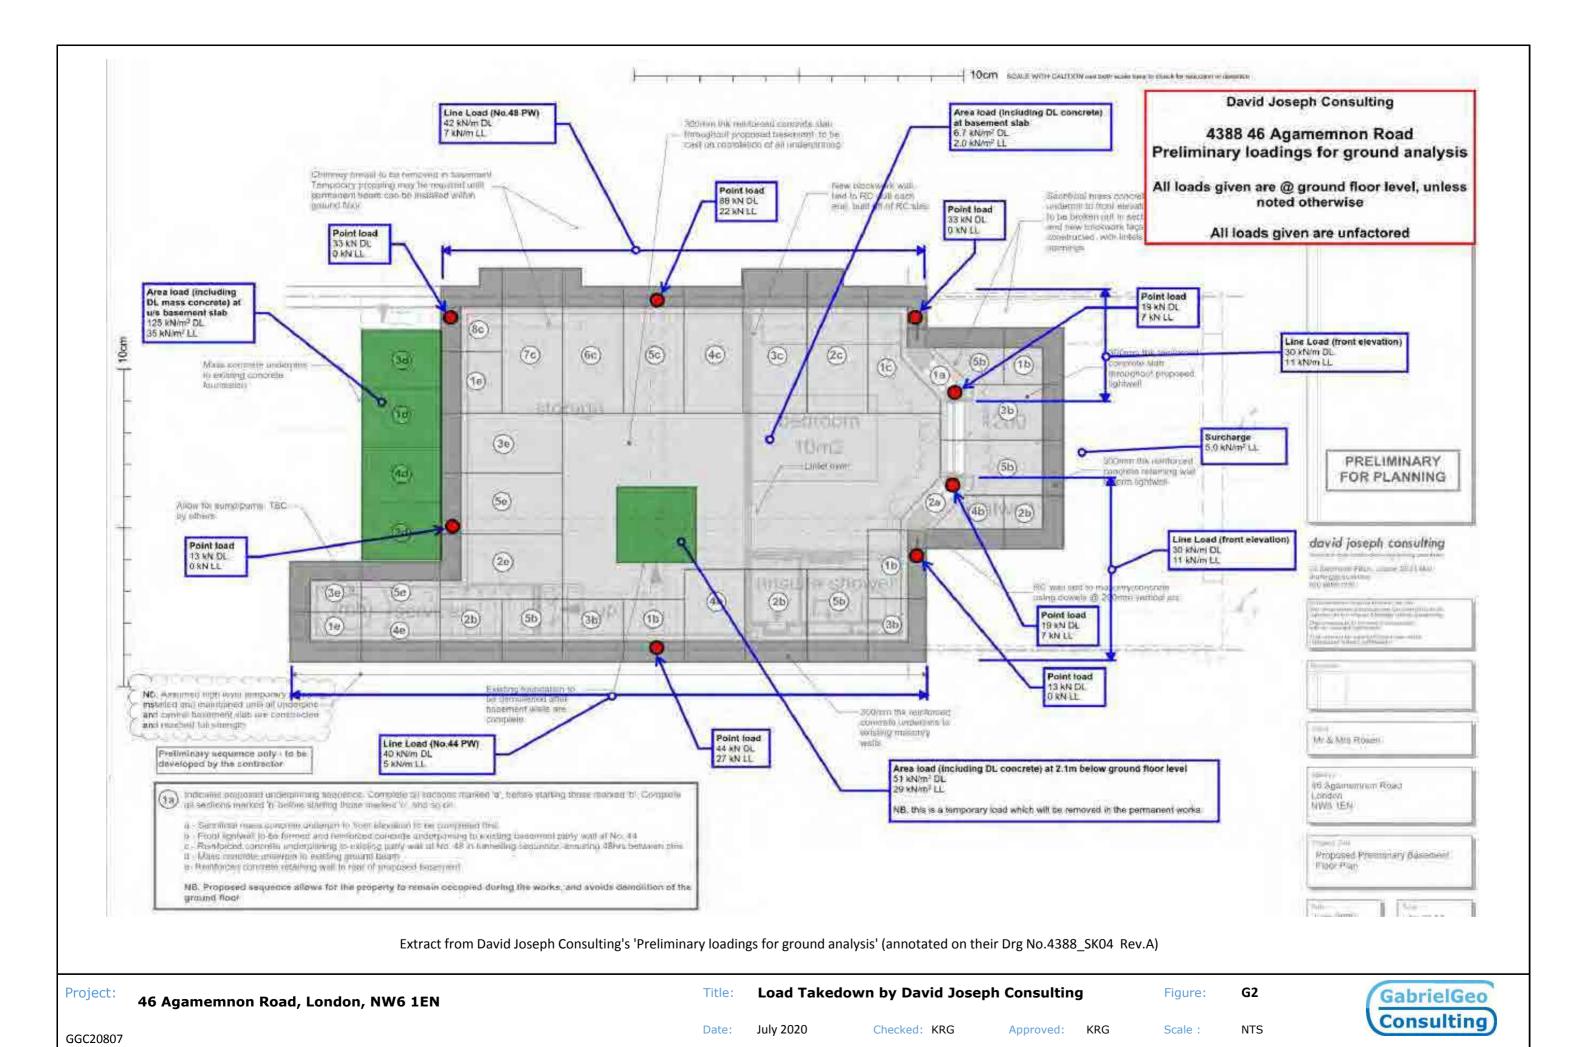
Red zone (14) = Existing pad footing to be removed.

Yellow zones = excavation and basement slab.

Notes: 1. Base drawing is from 'Proposed Preliminary Basement Floor Plan' (DJC's Drg No. 4388\_SK04 Rev.A)

Title: Layout of Zones used for PDISP Analyses Figure: G1

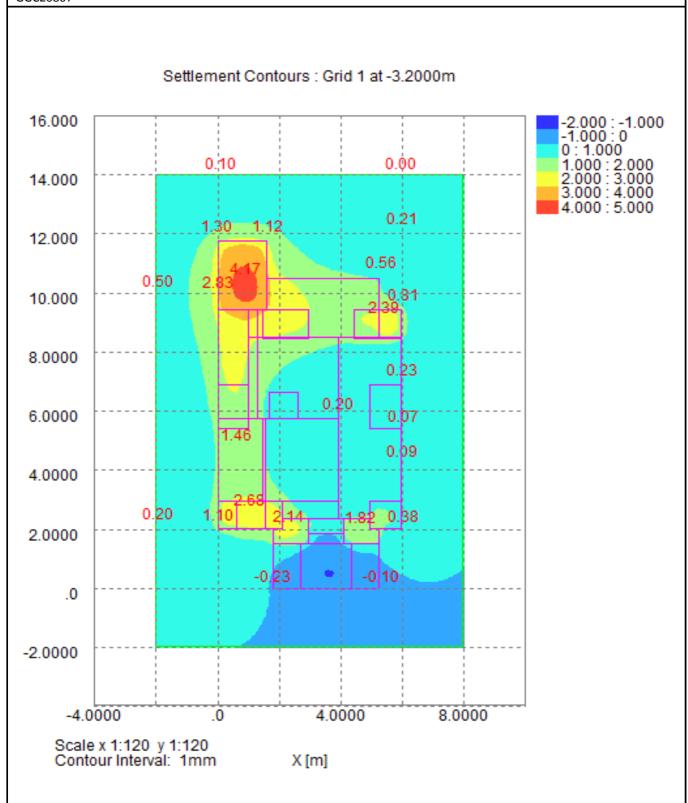
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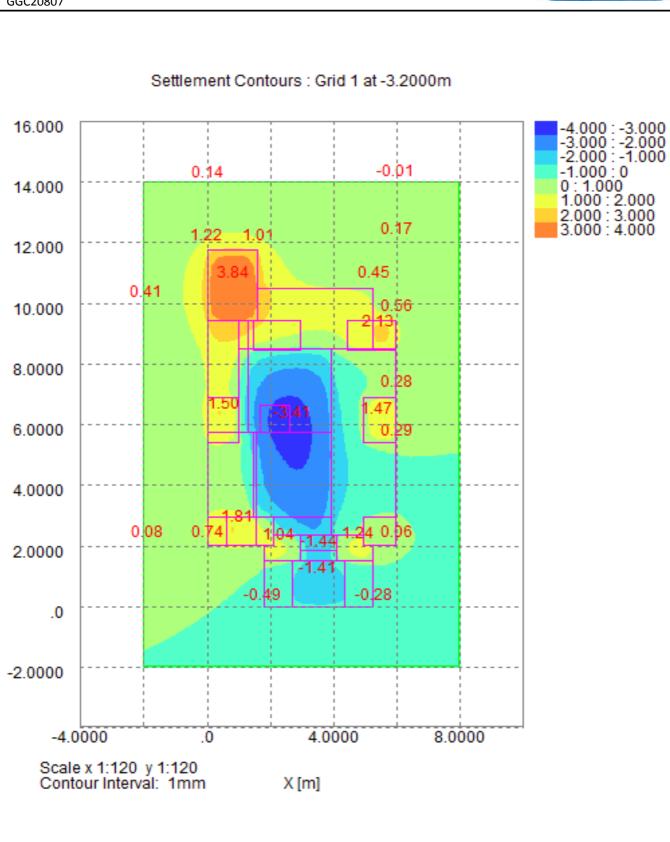
Title: PDISP Output - Contour Plot for Stage 1 Figure: G3

Date: July 2020 Checked: KRG Approved: KRG Scale: NTS

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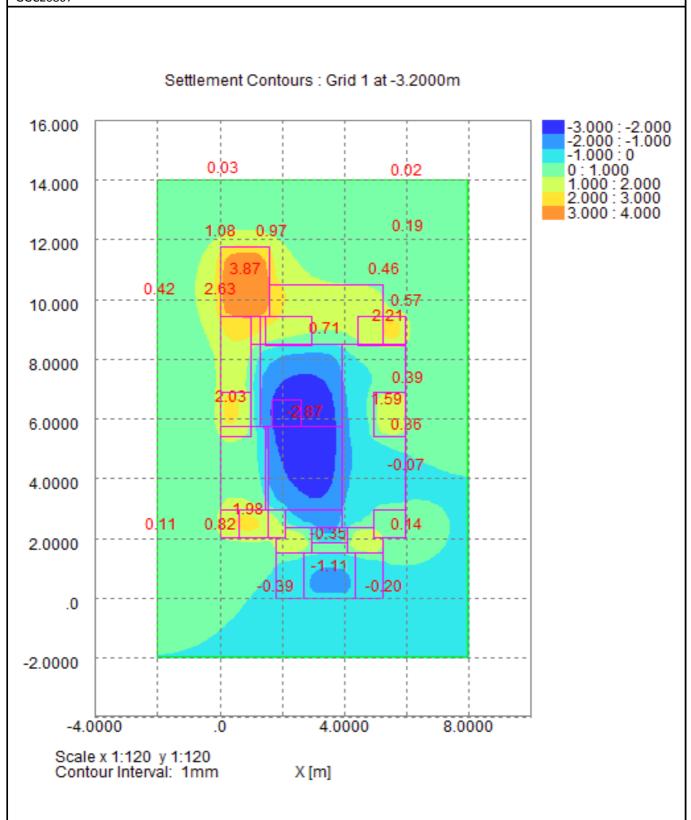


**PDISP Output - Contour Plot for Stage 2** Title: Figure: G4 Date: July 2020 Checked: KRG Approved: KRG Scale: NTS

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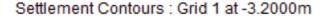
Title: PDISP Output - Contour Plot for Stage 3 Figure: G5

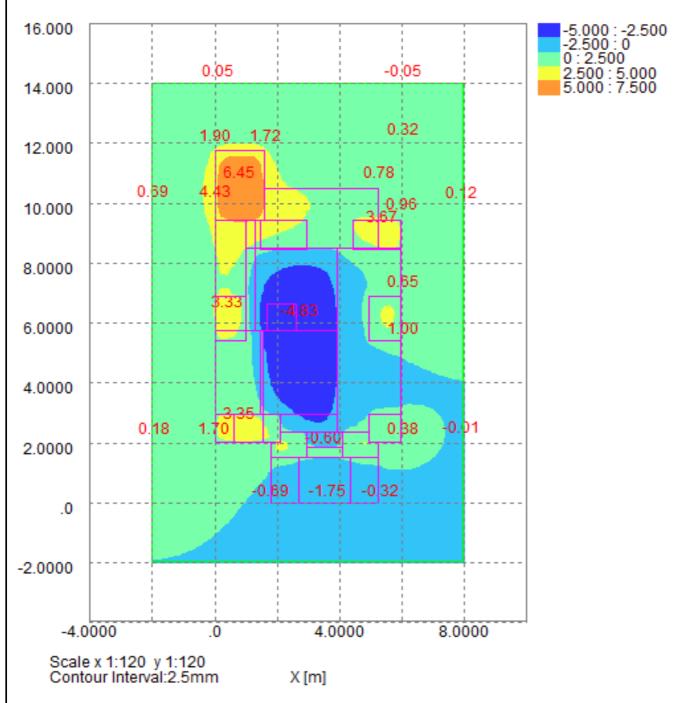
Date: July 2020 Checked: KRG Approved: KRG Scale: NTS

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Title: PDISP Output - Contour Plot for Stage 4

Date: July 2020 Checked: KRG Approved: KRG Scale: NTS

Figure:

G6