

800 x 800 x 1500 LONG ATTENUATOR

KITCHEN EXTRACT FAN  
MOUNTED INTERNALLY  
ABOVE CEILING

2 No. CATERING CONDENSERS  
BELOW KITCHEN EXTRACT RISER

600 x 600 KITCHEN EXTRACT RISER TO HIGH LEVEL.  
DUCT TO BE PAINTED TO MATCH BRICKWORK.

AIR INTAKE LOUVRE AND DUCTWORK  
(AS SHOWN) TO REMAIN

- General notes:
- Positions of all equipment, ductwork and fittings are indicative only.
  - Contractors shall confirm the sequence of installation works to ensure safe access is maintained.
  - Attention is drawn to health & safety issues. Liaise with the main contractor to ensure that installation works are programmed to minimise H&S risks and optimise co-ordination.
  - All dimensions / duct sizes are in millimetres unless otherwise stated.
  - This drawing was produced using CAD and should not be amended by hand.
  - All dimensions shown are for reference and should be checked on site prior to commencement of work.
- Specific notes:
- This drawing should be read in conjunction with all architectural, structural and drawings from other services (incl. mechanical, catering, electrical, sprinklers) along with contract documentation and specification for the works.
  - Ensure all method statements, sign offs and approvals are in place before proceeding with any work.
  - All works to be carried out in accordance with the current British Standards, B.S. codes of practice and building regulations.
  - The HVAC services works shall be carried out in full accordance with the client specification and brief, together with any standard technical guide and specification.
  - Ductwork shall be installed in accordance with all current industry standard guidelines / regulations.
  - Galvanneal ductwork to be manufactured to DW144.
  - Ductwork sized in accordance with all current industry standard guidelines / regulations. Duct dimensions shown on drawing are clear internal dimensions (not including flanges and fittings).
  - Access doors required on kitchen extract duct every 1500mm for cleaning and before / after every change of direction & should be accessible at all locations via ceiling access panels or gridded ceiling etc. Access panels to be provided by main contractor in any solid ceilings where final requirements indicated by HVAC installation contractor.
  - Duct connections with fans and other equipment to be a manufactured canvas connection to prevent duct transmitted noise and transmission of vibrations.
  - Volume control dampers shall be installed on all branch legs and diffuser / grille terminals to facilitate commissioning.
  - Supply and secondary fan coil unit ductwork to be fully insulated.
  - Fresh air intakes and exhausts locations are shown individually on these drawings. The exact positions shall be agreed with the client, architect and the main contractor and shall be shown accurately on the working / coordinated drawings.
  - Position of all grilles / air valves shown are in optimum positions for air flow. The grilles to be positioned as close as practicable to location shown and coordinated with other services and fabric constraints.
  - Fire dampers are to be shown on ductwork (including kitchen extract ducts) penetrating fire compartment divides and shall incorporate certified fire dampers to match the barrier rating together with access panels. Reference to be made to architect fire strategy drawings to establish locations. Fire dampers are shown indicatively on these drawings.
  - All transfer grilles and ductwork where fire rated, shall match the fire rating of the wall in which it is installed.
  - Attenuation and anti-vibration measures shall be incorporated on all plant and ductwork supports in full accordance with acoustic consultant's specification.
  - Access required to all plant equipment for maintenance and cleaning.
  - Refer to catering specialist layout to determine confirmed canopy sizes and location.
  - Cooperate drain from AC condensers to be run to the nearest waste connection or to rooftop drain. Condensate drains from the FCU's to be run to the nearest drain (20mm), subject to manufacturer and their requirements. Both shall be the equivalent plastic or copper sizes.
  - Install all mechanical equipment in accordance with manufacturers guidelines.
  - Catering condensers are not CVL equipment. However, they are indicatively shown on CVL drawings to show the provisioned space and access within the HVAC plant area.
  - Locations of all required floor, wall and roof openings shall be co-ordinated with all other trades involved.
  - No other loads (i.e. other services or man loading) shall be hung from ductwork supports.

**METERAGE**

SUPPLY DUCTWORK	
WC EXTRACT DUCTWORK	
AC PIPEWORK	

*Quantities are for this sheet only*

No.	Date	Rev. By	Rev.	Description
A	29-07-20	PR		Catering condensers added.

Client:  
**JOLIBEE**

Project:  
**JOLIBEE**  
122-126 KILBURN HIGH ROAD  
LONDON NW1 6LG

Drawing Title:  
**PROPOSED HVAC  
GROUND FLOOR**

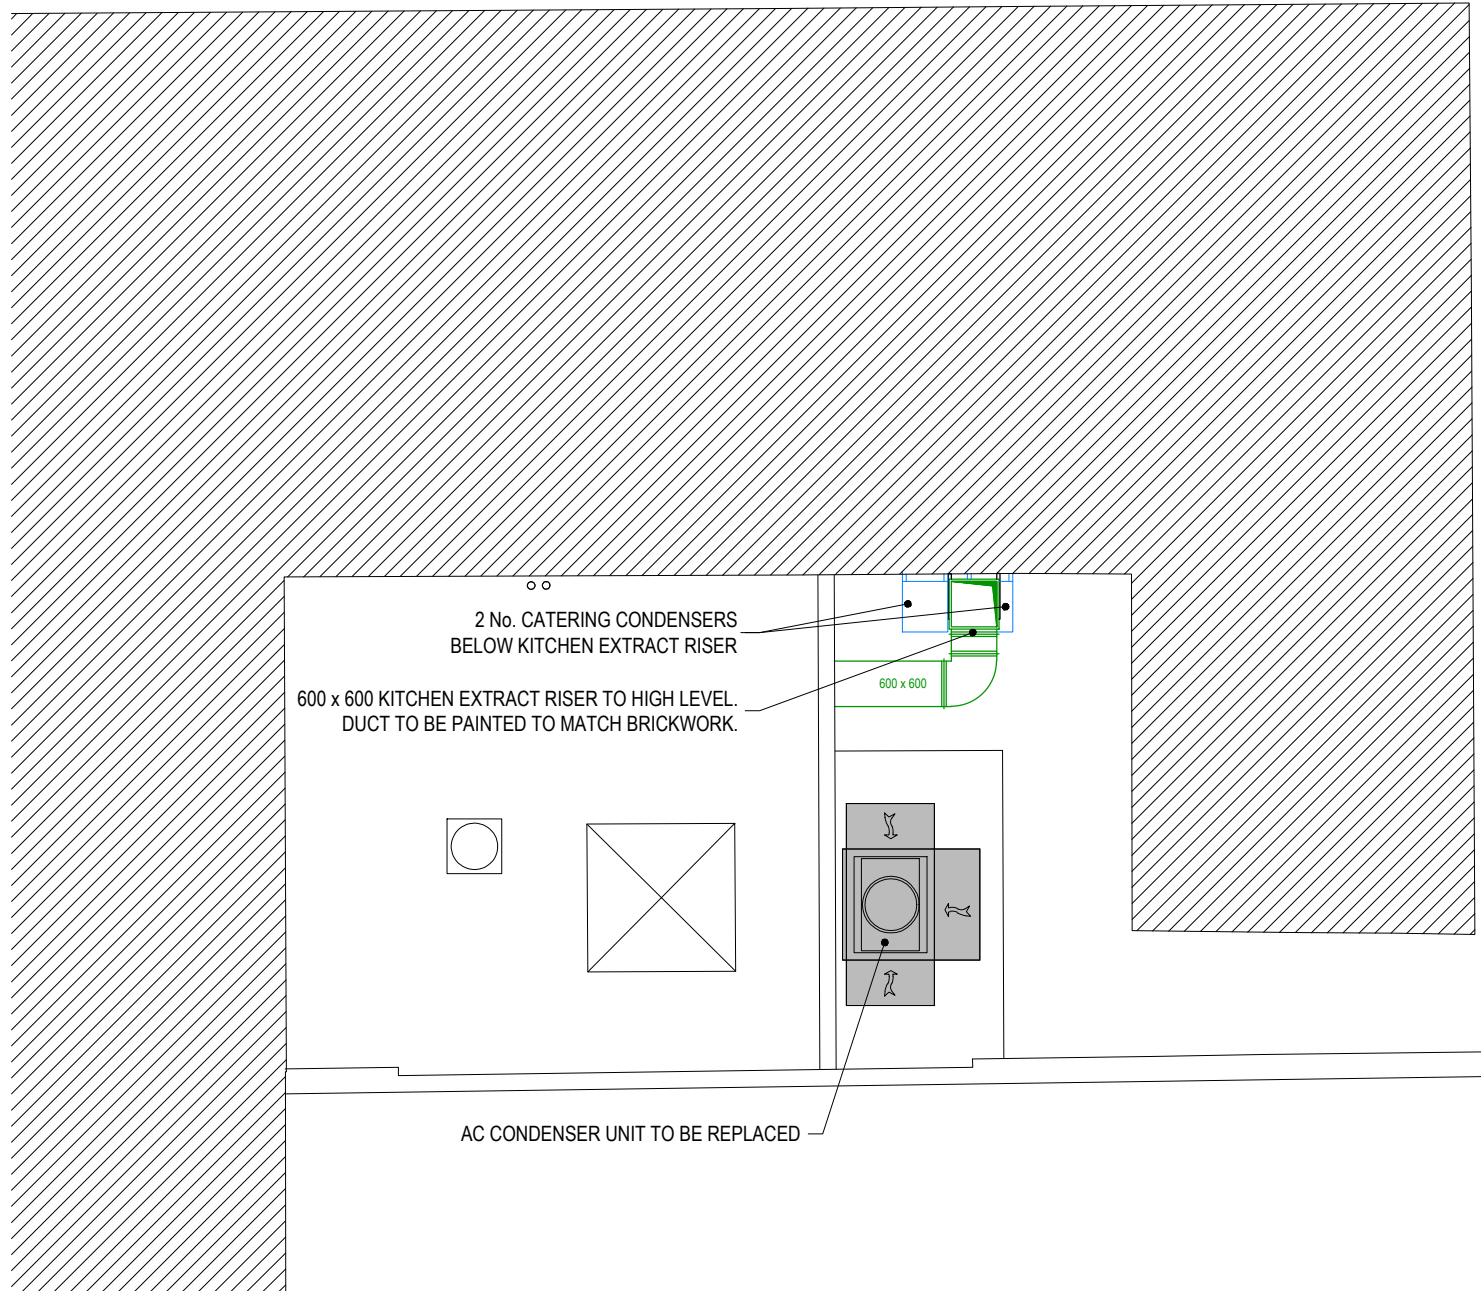
Drawing No.:	Rev:
001-731-11	A
Scale: 1:50 @ A1 1:100 @ A3	
Drawn By: PR	Date: 28/07/20

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- General notes:
- Positions of all equipment, ductwork and fittings are indicative only.
  - Contractors shall confirm the sequence of installation works to ensure safe access is maintained.
  - Attention is drawn to health & safety issues. Liaise with the main contractor to ensure that installation works are programmed to minimise H&S risks and optimise co-ordination.
  - All dimensions / duct sizes are in millimetres unless otherwise stated.
  - This drawing was produced using CAD and should not be amended by hand.
  - All dimensions shown are for reference and should be checked on site prior to commencement of work.

- Specific notes:
- This drawing should be read in conjunction with all architectural, structural and drawings from other services (incl. mechanical, catering, electrical, sprinklers), along with contract documentation and specification for the works.
  - Ensure all method statements, sign off and approvals are in place before proceeding with any work.
  - All works to be carried out in accordance with the current British Standards, B.S. codes of practice and building regulations.
  - The HVAC services works shall be carried out in full accordance with the client specification and brief, together with any standard technical guide and specification.
  - Ductwork shall be installed in accordance with all current industry standard guidelines / regulations.
  - Galvanneal ductwork to be manufactured to DW154.
  - Ductwork sized in accordance with all current industry standard guidelines / regulations. Duct dimensions shown on drawing are clear internal dimensions (not including flanges and fittings).
  - Access doors required on kitchen extract duct every 1500mm for cleaning and before / after every change of direction & should be accessible at all locations via ceiling access panels or gridded ceiling etc. Access panels to be provided by main contractor in any solid ceilings where final requirements indicated by HVAC installation contractor.
  - Duct connections with fans and other equipment to be manufactured canvas connection to prevent duct thermal noise and transmission of vibrations.
  - Volume control dampers shall be installed on all branch legs and diffuser / grille terminals to facilitate commissioning.
  - Supply and secondary fan coil unit ductwork to be fully insulated.
  - Final air intake and exhaust locations are shown individually on these drawings. The exact positions shall be agreed with the client, architect and the main contractor and shall be shown accurately on the working / coordinated drawings.
  - Position of all grilles / air valves shown are in optimum positions for air flow. The grilles to be positioned as close as practicable to location shown and coordinated with other services and fabric constraints.
  - Fire elements are to be shown on ductwork (including kitchen extract ducts) penetrating fire compartment divides and shall incorporate certified fire dampers to match the lower rating, together with access panels. Reference to be made to architect fire strategy drawings to establish locations. Fire dampers are shown indicatively on these drawings.
  - All transfer grilles and ductwork where fire rated, shall match the fire rating of the wall in which it is installed.
  - Attenuation and anti-vibration measures shall be incorporated on all plant and ductwork supports in full accordance with acoustic consultant's specification.
  - Access required to all plant equipment for maintenance and cleaning.
  - Refer to catering specialist layout to determine confirmed canopy sizes and location.
  - Cooperate drain from AC condensers to be run to the nearest waste connection or to rooftop drain. Condensate drains from the FCUs to be run to the nearest drain (20mm), subject to manufacturer and their requirements. Both shall be the equivalent plastic or copper sizes.
  - Install all mechanical equipment in accordance with manufacturers guidelines.
  - Catering condensers are not CVL equipment. However, they are indicatively shown on CVL drawings to show the provisioned space and access within the HVAC plant area.
  - Locations of all required floor, wall and roof openings shall be co-ordinated with all other trades involved.
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SUPPLY DUCTWORK	
WC EXTRACT DUCTWORK	
AC PIPEWORK	

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A	29-07-20	PR	Catering condensers added.
No.	Date	Rev. By	Revision Description

Client: **JOLIBEE**

Project: **JOLIBEE  
122-126 KILBURN HIGH ROAD  
LONDON NW1 GLG**

Drawing Title: **PROPOSED HVAC  
FLAT ROOF & ELEVATION**

Drawing No.:	Rev:
001-731-12	A
Scale: 1:50 @ A1 1:100 @ A3	
Drawn By: PR	Date: 28/07/20

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