



PLANT AREA

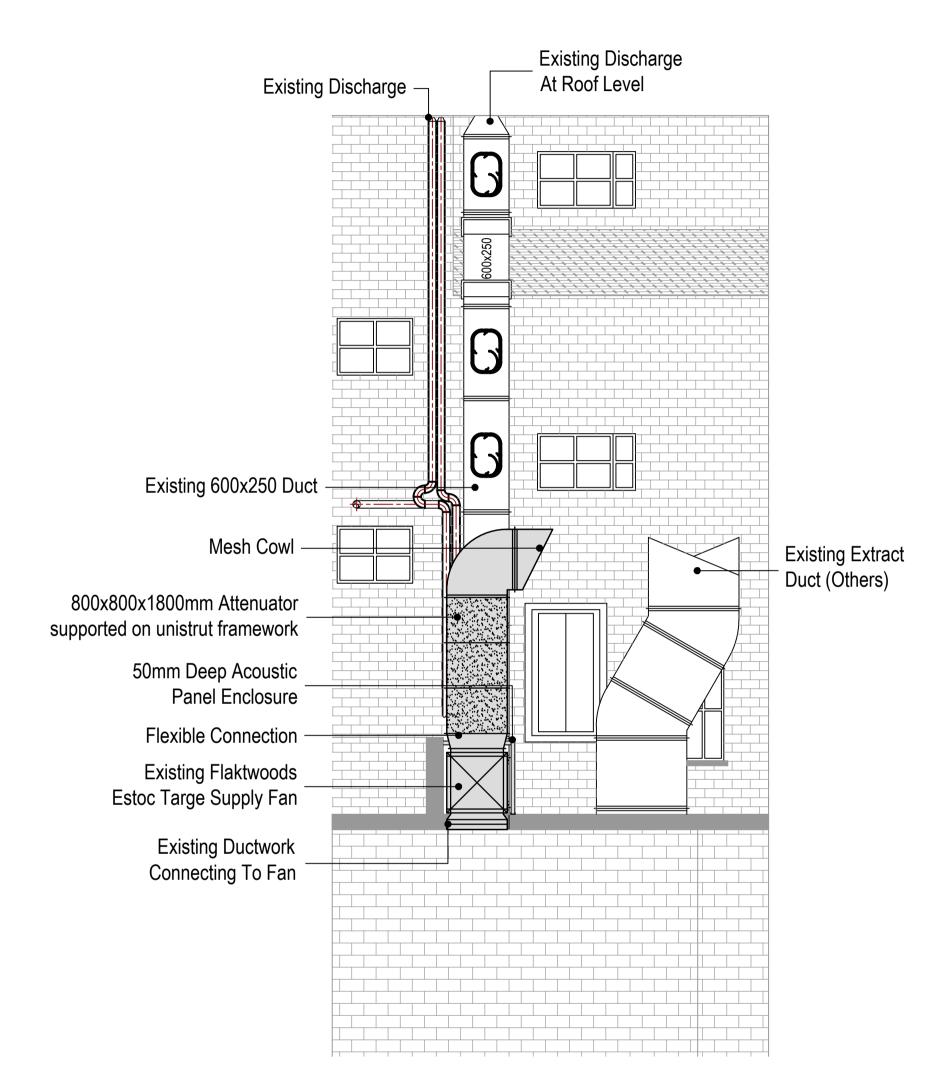

A-A ELEVATION

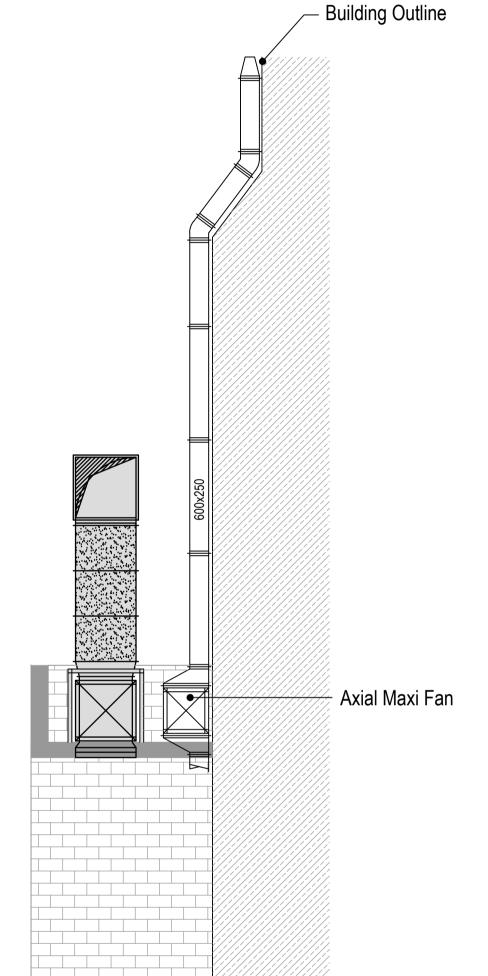

B-B ELEVATION

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METERAGE

SUPPLY DUCTWORK 0.0m WC EXTRACT DUCTWORK 0.0m 0.0m **AC PIPEWORK**

Quantities are for this sheet only

D 07/04/19 JJ Revised To Existing Revised Attenuation B | 19/03/19 | JJ | Revised Notation, Big Foot System A 27/02/19 JJ Added Extract duct repositioned

ROSA'S THAI CAFE

Rosa's Thai Cafe Earlham Street London

Existing Ventilation Layout Plant Deck & Elevation

001-612-01


Drawn By: JJ Checked By: - Date: 26/02/19


chapman ventilation
15-20 Woodfield Road, Welwyn Garden City

Hertfordshire AL7 1JQ
Tel: 01707 372858 Fax: 01707 325001
E-mail: info@chapmanventilation.co.uk
Web: www.chapmanventilation.co.uk


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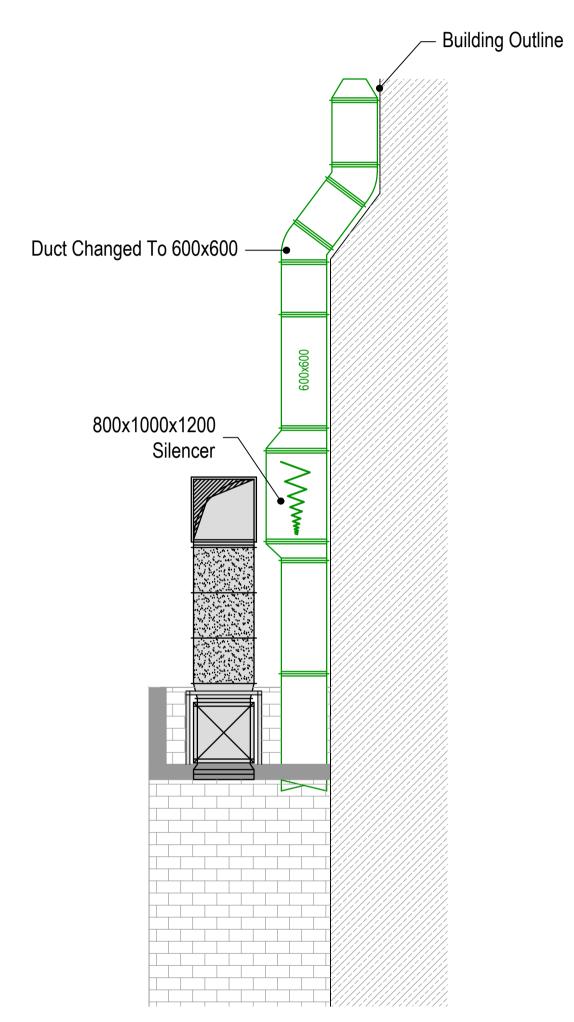


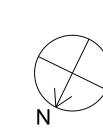

PLANT AREA

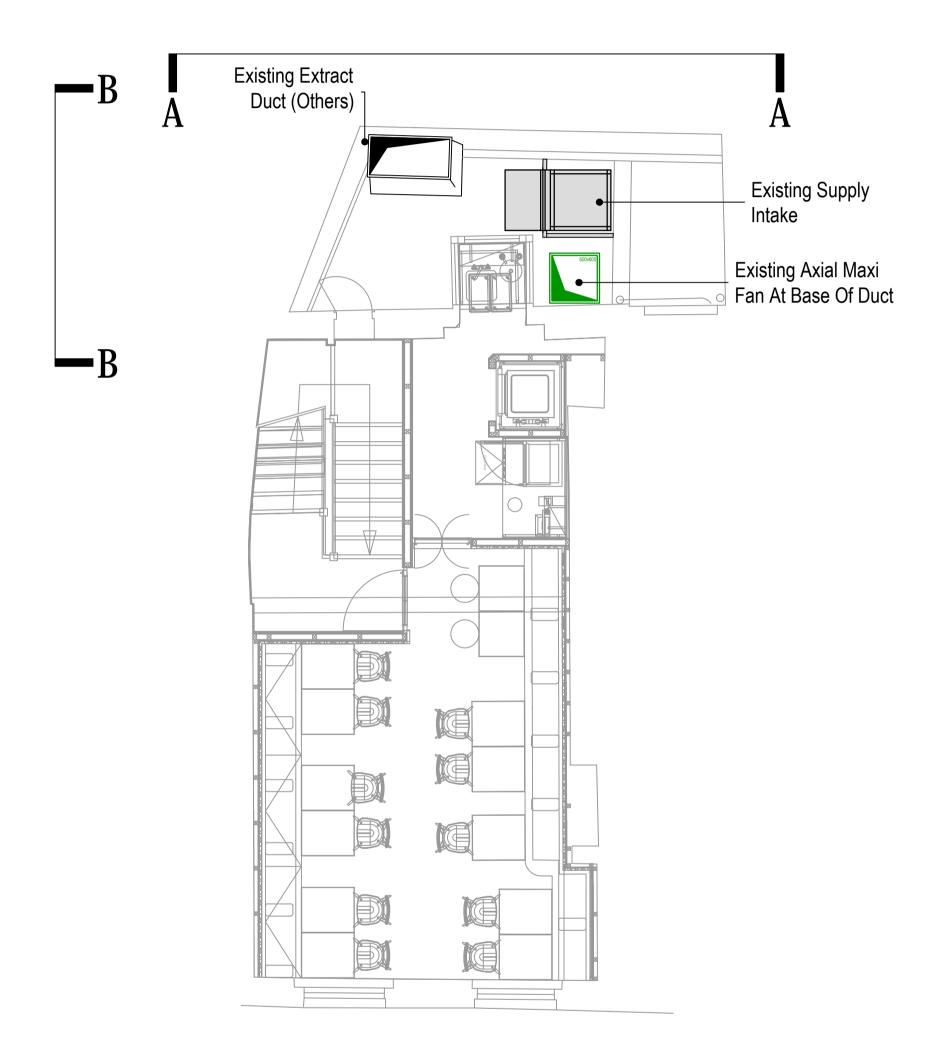

A-A ELEVATION

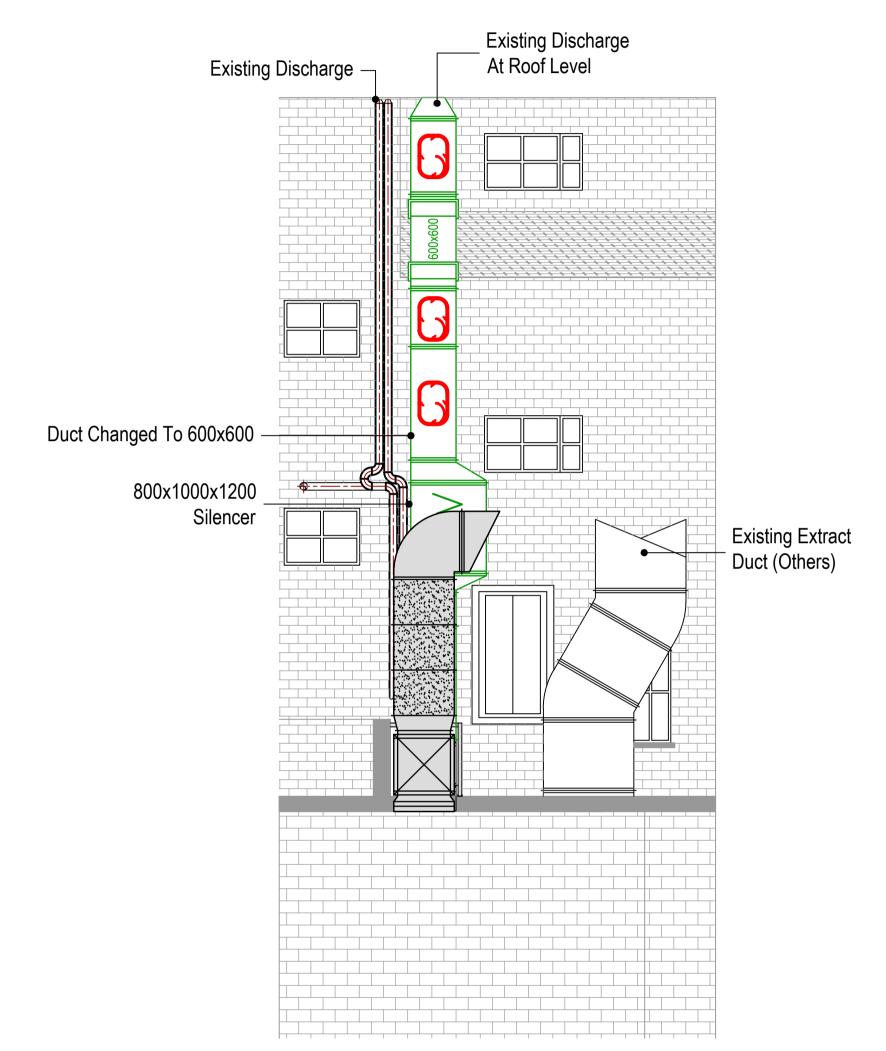

B-B ELEVATION

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METERAGE

SUPPLY DUCTWORK	0.0m
WC EXTRACT DUCTWORK	0.0m
AC PIPEWORK	0.0m

Quantities are for this sheet only

ROSA'S THAI CAFE

Rosa's Thai Cafe Earlham Street London

Proposed Ventilation Layout Plant Deck & Elevation


001-612-02

Drawn By: JJ Checked By: - Date: 07/04/20

chapman ventilation
15-20 Woodfield Road, Welwyn Garden City


Hertfordshire AL7 1JQ
Tel: 01707 372858 Fax: 01707 325001
E-mail: info@chapmanventilation.co.uk
Web: www.chapmanventilation.co.uk



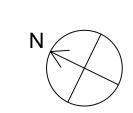


PROPOSED GROUND FLOOR

High Level Low Level

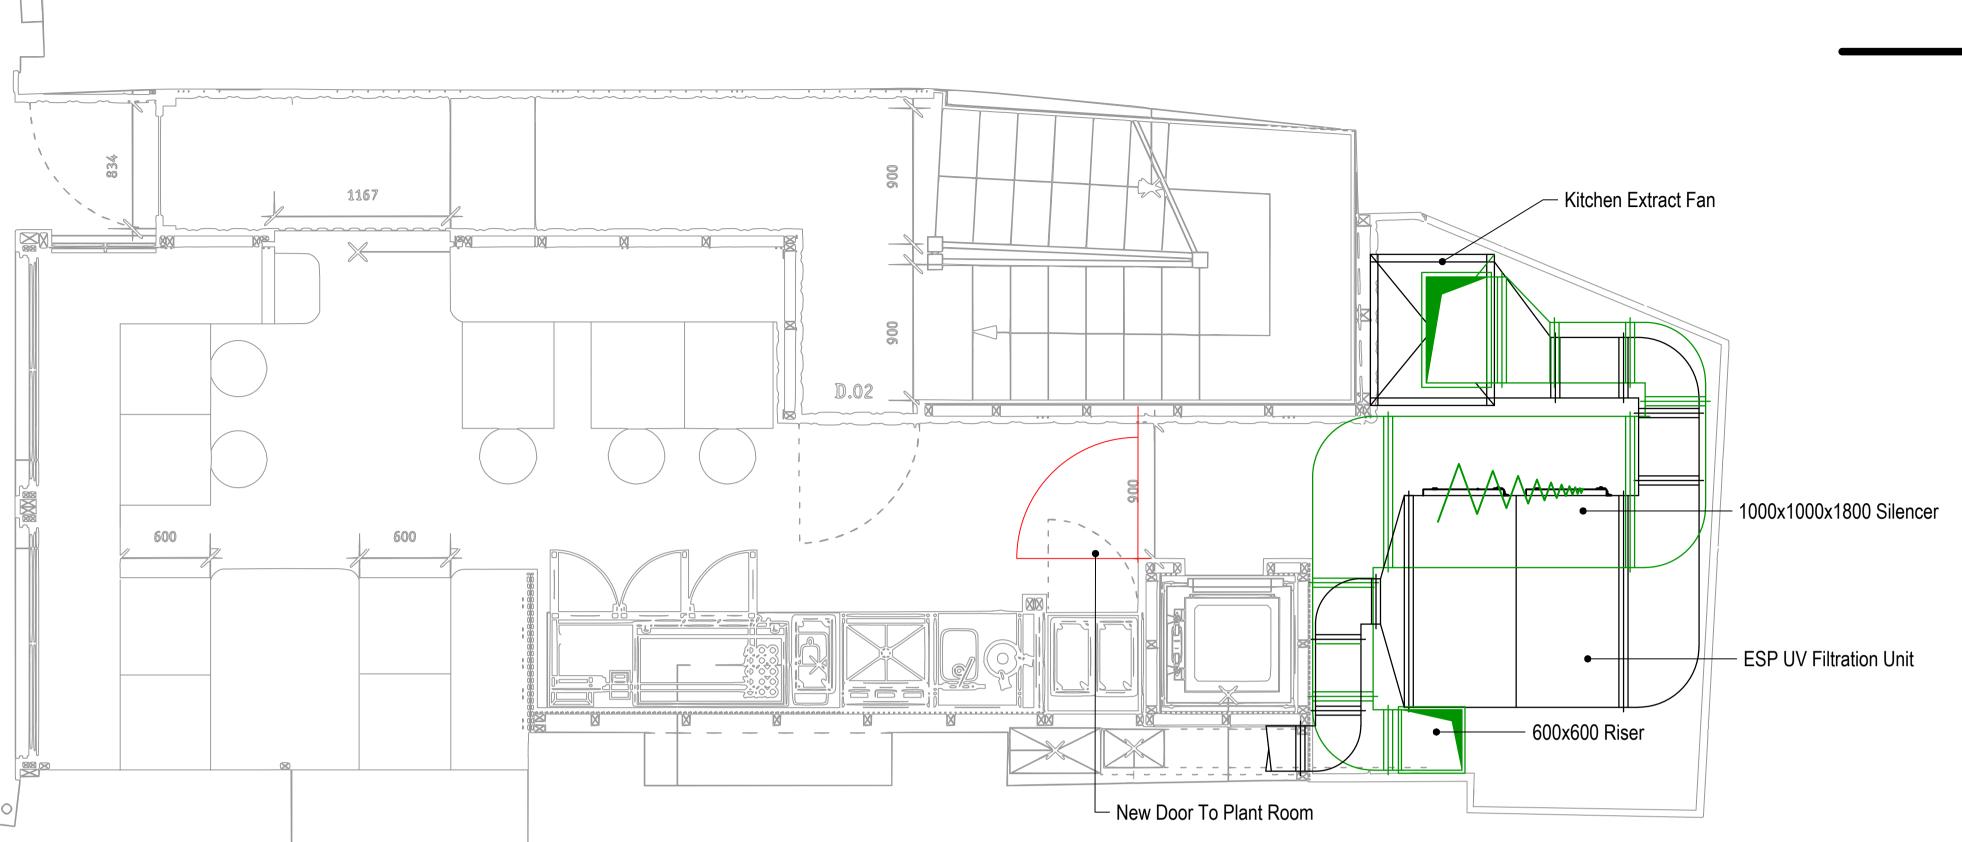

EXISTING GROUND FLOOR

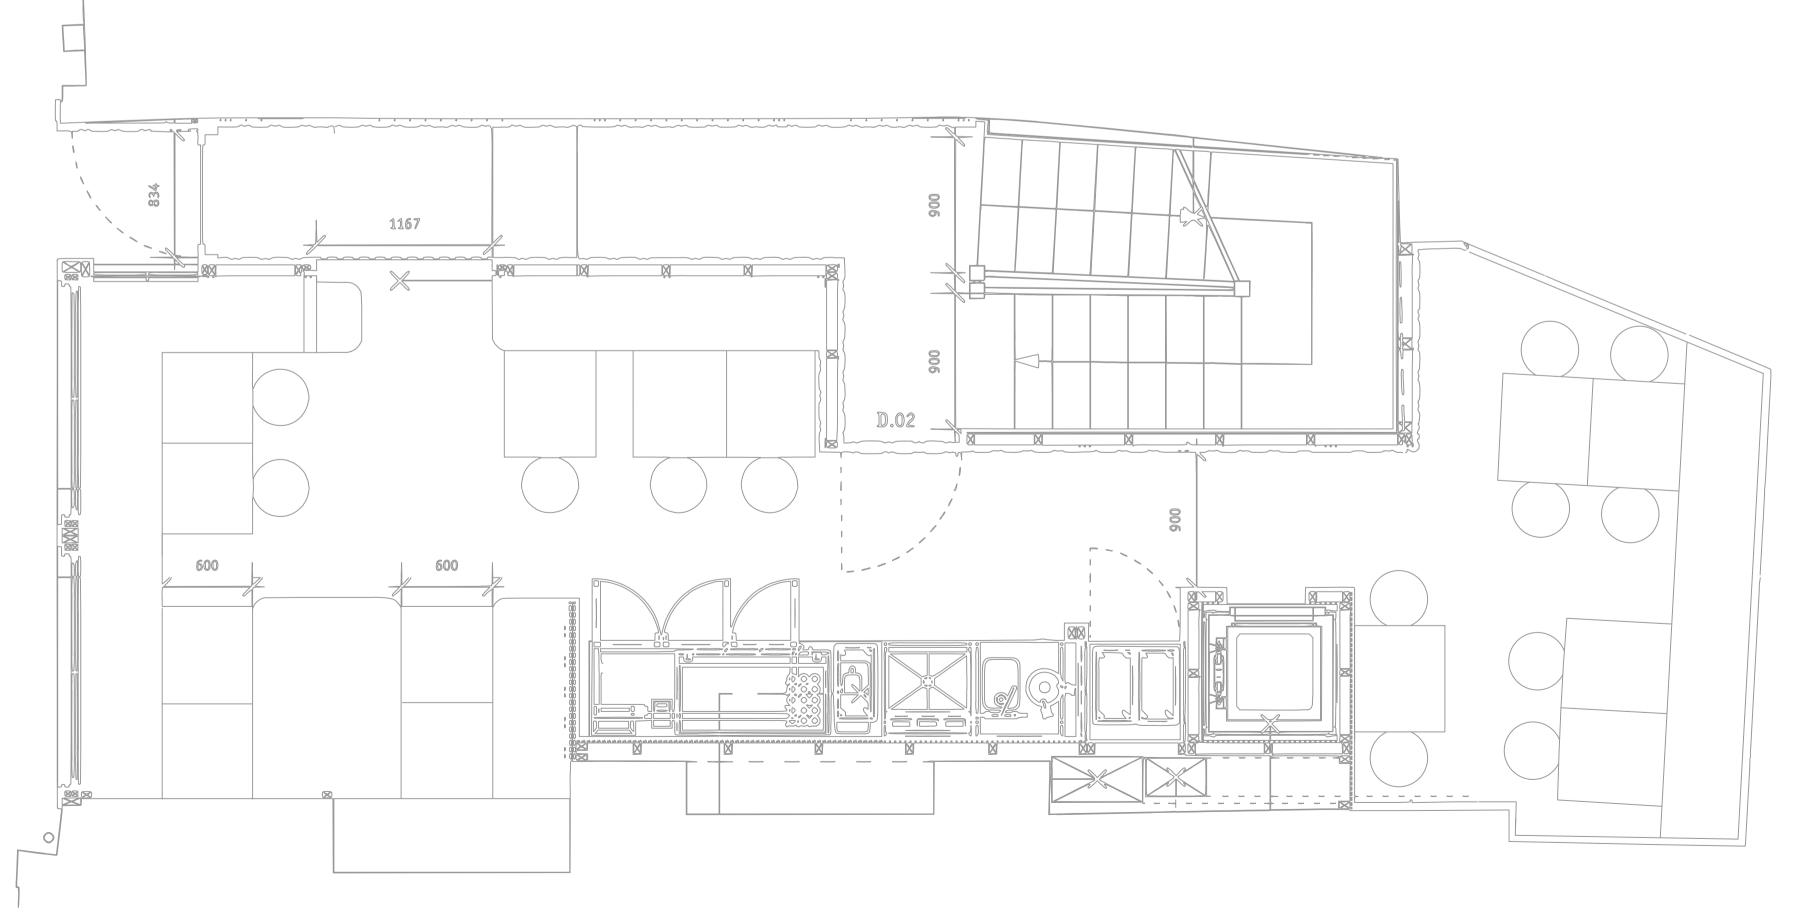

Note: -All plant will be installed on anti-vibration mounts

General notes:

1. Positions of all equipment, ductwork and fittings are indicative only. Contractors shall confirm the sequence of installation works to ensure safe access is maintained. 3. Attention is drawn to health & Safety issues. Liaise with the main contractor to ensure that installation works are programmed to minimise H&S risks and optimise co-ordination.

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METERAGE

SUPPLY DUCTWORK 0.0m WC EXTRACT DUCTWORK 0.0m 0.0m AC PIPEWORK

Quantities are for this sheet only

A 16/07/20 JJ Existing Ground Floor Layout Added

ROSA'S THAI CAFE

Rosa's Thai Cafe Earlham Street

Drawing Title:

London

Ground Floor Ventilation Layout


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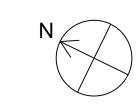
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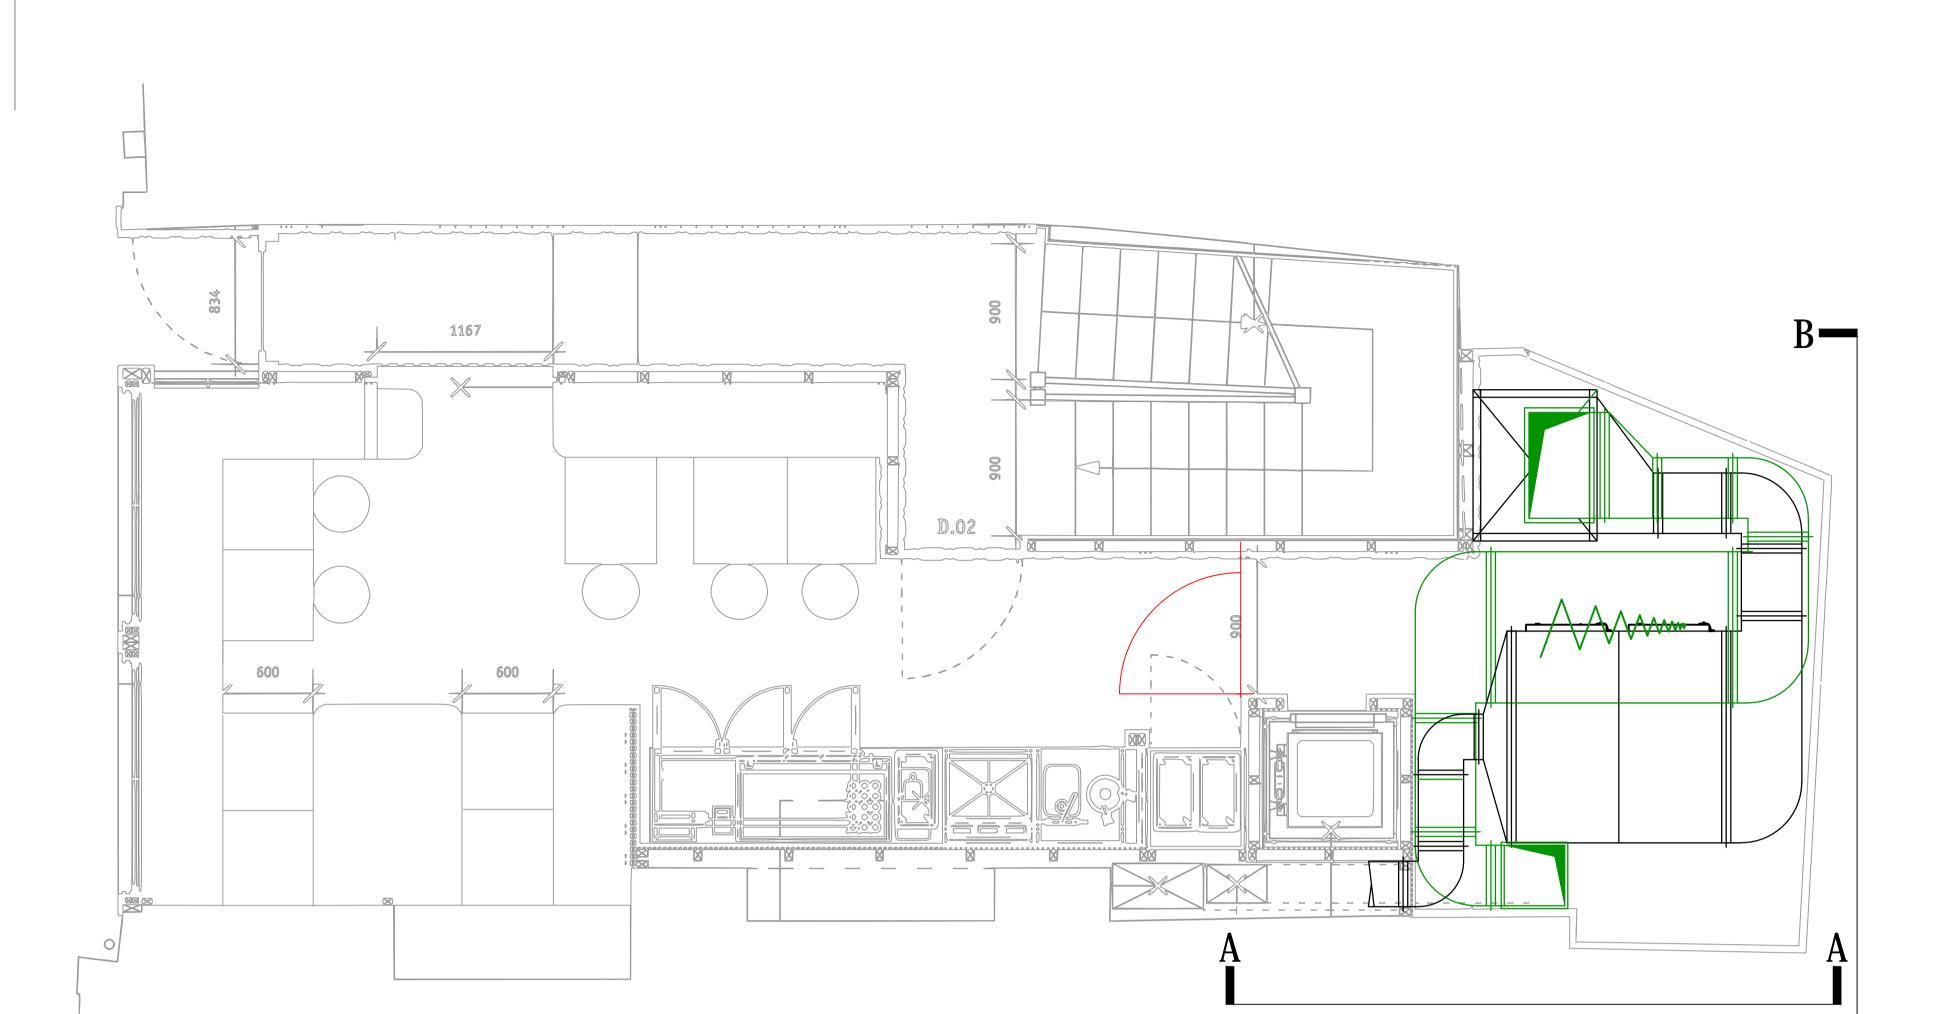
Drawn By: JJ Checked By: - Date: 10/06/20

chapman ventilation


15-20 Woodfield Road, Welwyn Garden City Hertfordshire AL7 1JQ Tel: 01707 372858 Fax: 01707 325001 E-mail: info@chapmanventilation.co.uk Web: www.chapmanventilation.co.uk





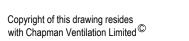


PROPOSED GROUND FLOOR

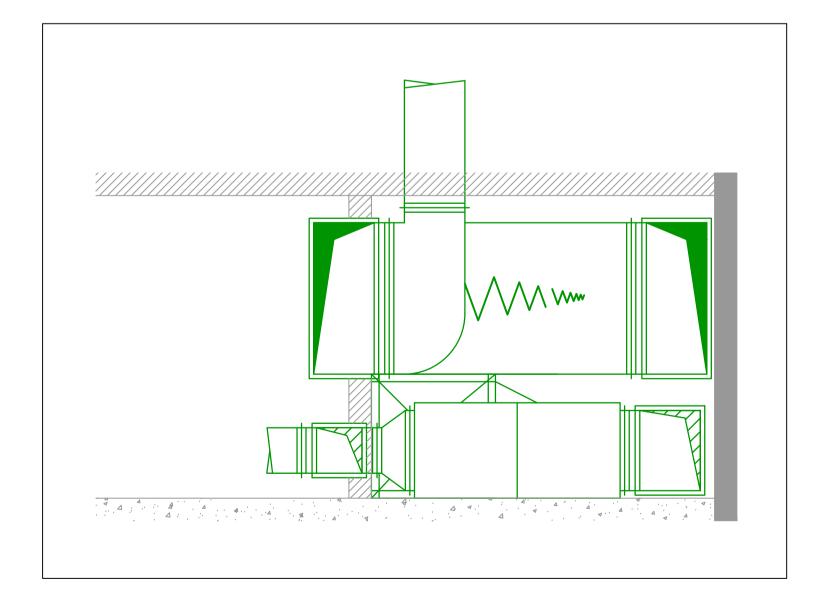

A-A ELEVATION



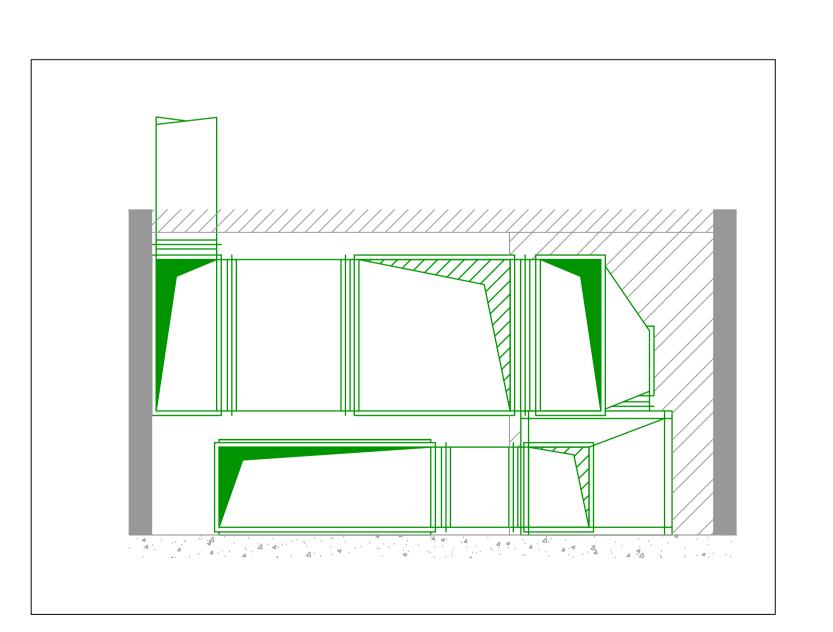

B-B ELEVATION

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METERAGE

SUPPLY DUCTWORK WC EXTRACT DUCTWORK 0.0m 0.0m AC PIPEWORK

Quantities are for this sheet only

Revision Description

ROSA'S THAI CAFE

Rosa's Thai Cafe Earlham Street London

Drawing Title :

Ground Floor Ventilation Layout Elevations

001-612-04

Drawn By: JJ Checked By: - Date: 10/06/20

chapman

Ventilation

15-20 Woodfield Road, Welwyn Garden City
Hertfordshire AL7 1JQ
Tel: 01707 372858 Fax: 01707 325001
E-mail: info@chapmanventilation.co.uk
Web: www.chapmanventilation.co.uk



Technical data



Project name Date

Position/Item
Customer reference

Our reference

m rs Thai Earlham

Project notes
Position notes

10.6.2020 13:31

Fan type	Plug fan CF3D	Fan data
Fan code	GMEB-1-04-063-7570	Max fan speed

 Fan code
 GMEB-1-04-063-7570
 Max fan speed
 2330 r/min

 Pcs
 1
 Airflow sensor k_factor
 11.63

Input values Connection

Volume flow rate 3.000 m³/s Connection: Free Inlet - Free outlet
Input static pressure 1200 Pa AHU dimensions Width 0 mm
AHU dimensions Height 0 mm

Output values Gas properties Volume flow rate $3.000 \,\mathrm{m}^3/\mathrm{s}$ Density 1.200 kg/m³ 20.0°C 0Pa Temperature AHU connection loss 0Pa Humidity 50.00% Other losses Fan static pressure 1200 Pa Elevation $0 \, m$ Fan speed 1752 r/min Total sound power level 88.7 dB(A) Weight 5.006 kW 107.0 kg Shaft power Fan Power from mains Ped 5.815 kW Motor -- kg Overall static efficiency 61.9% Accessories 7.4 kg 1.938 kW/m³/s Total SFP 114.4 kg

Fan data according to ISO 5801 and ISO 13347-2. Sound data below is calculated for selected connection method.

The octave sound power level near BPF can be higher than calculated below.

Lwoct (Hz)	63	125	250	500	1000	2000	4000	8000	Lwt (dB)	LwA (dBA)
Free outlet	80.5	88.2	85.4	83.8	83.7	82.7	78.0	71.1	92.7	88.7
Free inlet	77.6	87.4	84.1	77.7	76.4	76.5	71.1	64.0	90.1	82.9

Motor code APAL-4-00750-2-2-7 Speed controller

Motor type	FW motor IE2	VSD not included in FW delivery	
Nominal power	7.50 kW	Calculated operating Hz	60.0 Hz
Nominal speed	1460 r/min	Calculated operating voltage	8.7 V
Motor efficiency	%	Max speed with motor	1967 r/min
Efficiency class	IE2	Calculated max Hz	67.4 Hz
Motor current	15.00 A	Phase	3
IEC-size	132M	Voltage	400V
		Frequency	50 Hz

Accessories

Airflow sensor with four measuring points GMEZ-09-00-063-1-0 Flexible discharge GMEZ-21-00-063-1-0 Anti-vibration mountings (rubber) GMEZ-42-00-063-2-0

Data according to ErP-directive ErP 2016 Compliant

64.3 %	Speed	1675 r/min
70	Target efficiency grade N	62
5.342 kW	Installation category	А
$3.626 \mathrm{m}^3/\mathrm{s}$	Efficiency category	static
948 Pa	VSD	Yes
NC	DIN 24166 classification	LK 2
	70 5.342 kW 3.626 m³/s 948 Pa	70 Target efficiency grade N 5.342 kW Installation category 3.626 m³/s Efficiency category 948 Pa VSD

Fan chart

FläktWoods

Project name
Position/Item
Customer reference
Our reference

Overall static efficiency


Rovers Thai Earlham

Date Project notes Position notes 10.6.2020 13:31


Fan	GMEB-1-04-063-7570	Connection	
Fan type	Plug fan CF3D	Connection: Free Inlet - Free outlet	
Pcs	1	AHU dimensions Width	0 mm
		AHU dimensions Height	0 mm
Output values			
Volume flow rate	3.000 m³/s	SFP	$1.938 kW/m^3/s$
AHU connection loss	0 Pa	Fan chart density	1.200kg/m^3
Other losses	0 Pa	Operating density	1.200kg/m^3
Fan static pressure	1200 Pa		
Fan speed	1752 r/min		
Total sound power level	88.7 dB(A)		
Power from mains Ped	5.815 kW		


 $61.9\,\%$


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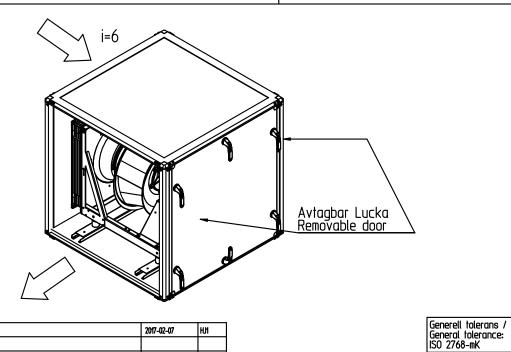


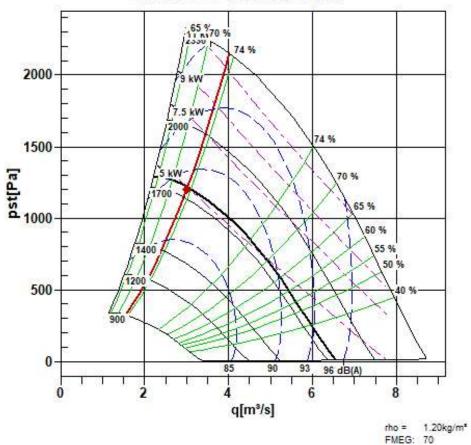Issue Modification



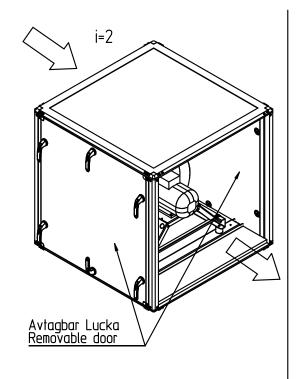

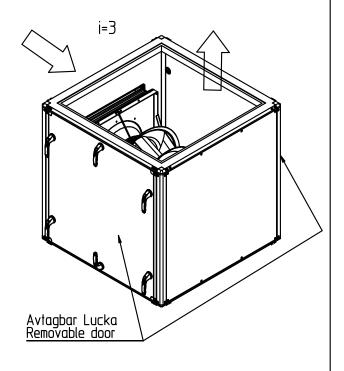

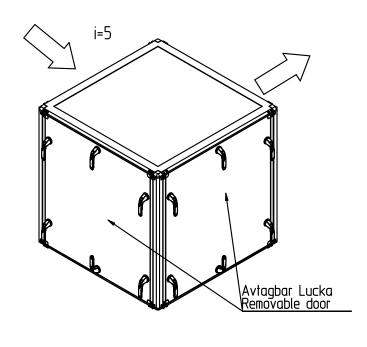



Date

Qty.	Qty.	Item no.	Internal article no.		Description					
Variant	Variant 21-	Dept.	Date 2017-02-07	Drawn by H. Jonss	on	Check TA	Appr PB	Scale 1:20	FlaktWo	ods
		EQGA	h=4	•		-		Fläkt W Jönköping	oods AB	
		Fan	section					Ritning nr Dra	wing no 3627	Issue A

Version 9

GMEB-1-14-063-5570 / GMEB-1-14-063-5580 GMEB-1-14-063-7570 / GMEB-1-14-063-7580

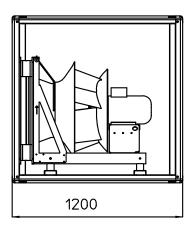

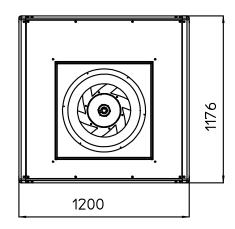

Qty.	Qty.	Item no.	Internal article no.		Description					
Variant	Variant 21-	Dept. PUA	Date 2017-02-14	Drawn by J. Prodra	omou	Check AG	Appr PB	Scale 1:20	FlaktWo	ods
		EQGA	h=4					Fläkt W Jönköping	oods AB	
	 , ,	Fan	section					Ritning nr Dra 1801	ing m 3652	Issue A

Version 6

A		2017-02-14	JP.
Issue	Modification	Date	Sign.