

1:50 0m 1n

GROUND FLOOR PLAN: PROPOSED

Scale 1:50


- 1. This drawing has been based upon a survey that was itself based on OUTLINE measurements NOT a full measured survey. As a result, considerable attention to the dimensions of any proposed works must be applied, taking site dimensions and templates as necessary.
- 2. While this drawing can be used as a base drawing for construction purposes, it is VERY IMPORTANT that all dimensions are checked carefully before any work commences or any materials are ordered.
- 3. This drawing can be used as part of a planning application, although your planning officer may ask for more specific information about some aspects of the design. For further information ask your architect.
- 4. Where applicable, a suitable Structural Engineer and/or a Party Wall Surveyor should be consulted. Although as far as possible these instances have been indicated, this is not necessarily exhaustive and the whole scope of proposed works should be reviewed.
- 5. Unless other arrangements have been specifically made, your building contractor should serve a Building Notice, as and where applicable, to your local authority to satisfy the requirements of the Building Regulations. Your building contractor should also liaise with the Building Control Officer regarding routine inspections of the work.

This is a 'Scheme Level Drawing' and is intended to illustrate the general arrangement of the project proposals. As it stands this drawing does not include all of the detail necessary for a full plans building regulations application.

While this drawing can be used as a base drawing for construction purposes, your building contractor may require more information. It is therefore important to discuss, with your architect & builder together, where more detail would be appropriate.

Scheme Level

				from an out	line survey	
REVISIONS C Extension doors	Date 19/03/2020	Inl NB	Architect Your Home Licensee: Architect Your Home Camden	Drawing name: GROUND FLOOR PLAN : PROPOSED		
D Dining Rm opening; remove int. window to Hall	19/03/2020	NB	4 Dartmouth Park Road London NW5 1SY	Date: 20/1/2020	Job no: 08-271	Drawing no: 07
E Lantern revised to flat roofligh	03/07/2020 t	NB	Tel: 020 7485 3133	Scale: 1:50 @ A3	Revision:	Drawn by: NB
All dimensions are in millimetres All dimensions to be checked on site @ Architect Your Home			Project name: 36A Goldhurst Terrace London, NW6 3HU	architectyourhome		

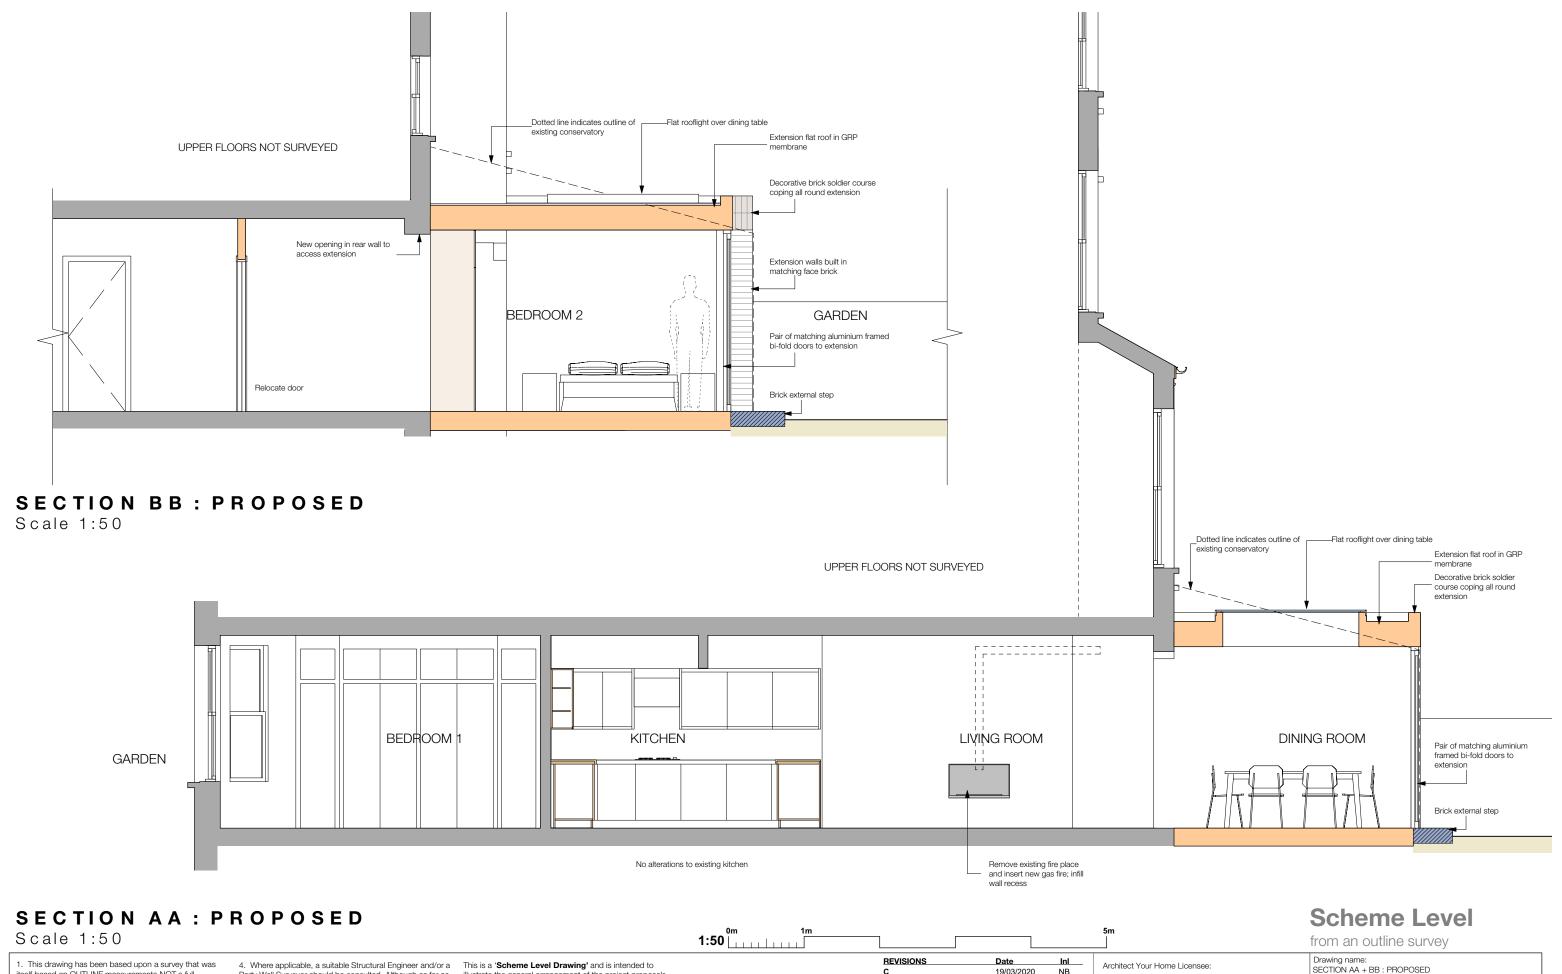

This drawing has been based upon a survey that was itself based on OUTLINE measurements NOT a full measured survey. As a result, considerable attention to the dimensions of any proposed works must be applied, taking site dimensions and templates as necessary.

- While this drawing can be used as a base drawing for construction purposes, it is VERY IMPORTANT that all dimensions are checked carefully before any work commences or any materials are ordered.
- This drawing can be used as part of a planning application, although your planning officer may ask for more specific information about some aspects of the design. For further information ask your architect.
- Where applicable, a suitable Structural Engineer and/or a Party Wall Surveyor should be consulted. Although as far as possible these instances have been indicated, this is not necessarily exhaustive and the whole scope of proposed works should be reviewed.
- 5. Unless other arrangements have been specifically made, your building contractor should serve a Building Notice, as and where applicable, to your local authority to satisfy the requirements of the Building Regulations. Your building contractor should also liaise with the Building Control Officer regarding routine inspections of the work.

This is a 'Scheme Level Drawing' and is intended to illustrate the general arrangement of the project proposals. As it stands this drawing does not include all of the detail necessary for a full plans building regulations application.

While this drawing can be used as a base drawing for construction purposes, your building contractor may require more information. It is therefore important to discuss, with your architect & builder together, where more detail would be appropriate.

1:50 @ A3

Tel: 020 7485 3133

Project name

19/03/2020

03/07/2020

NB

All dimensions are in millimetres


All dimensions to be checked on site © Architect Your Home

Remove int. window to Hall

Lantern revised to flat rooflight

36A Goldhurst Terrace London, NW6 3HU architectyourhome

NB

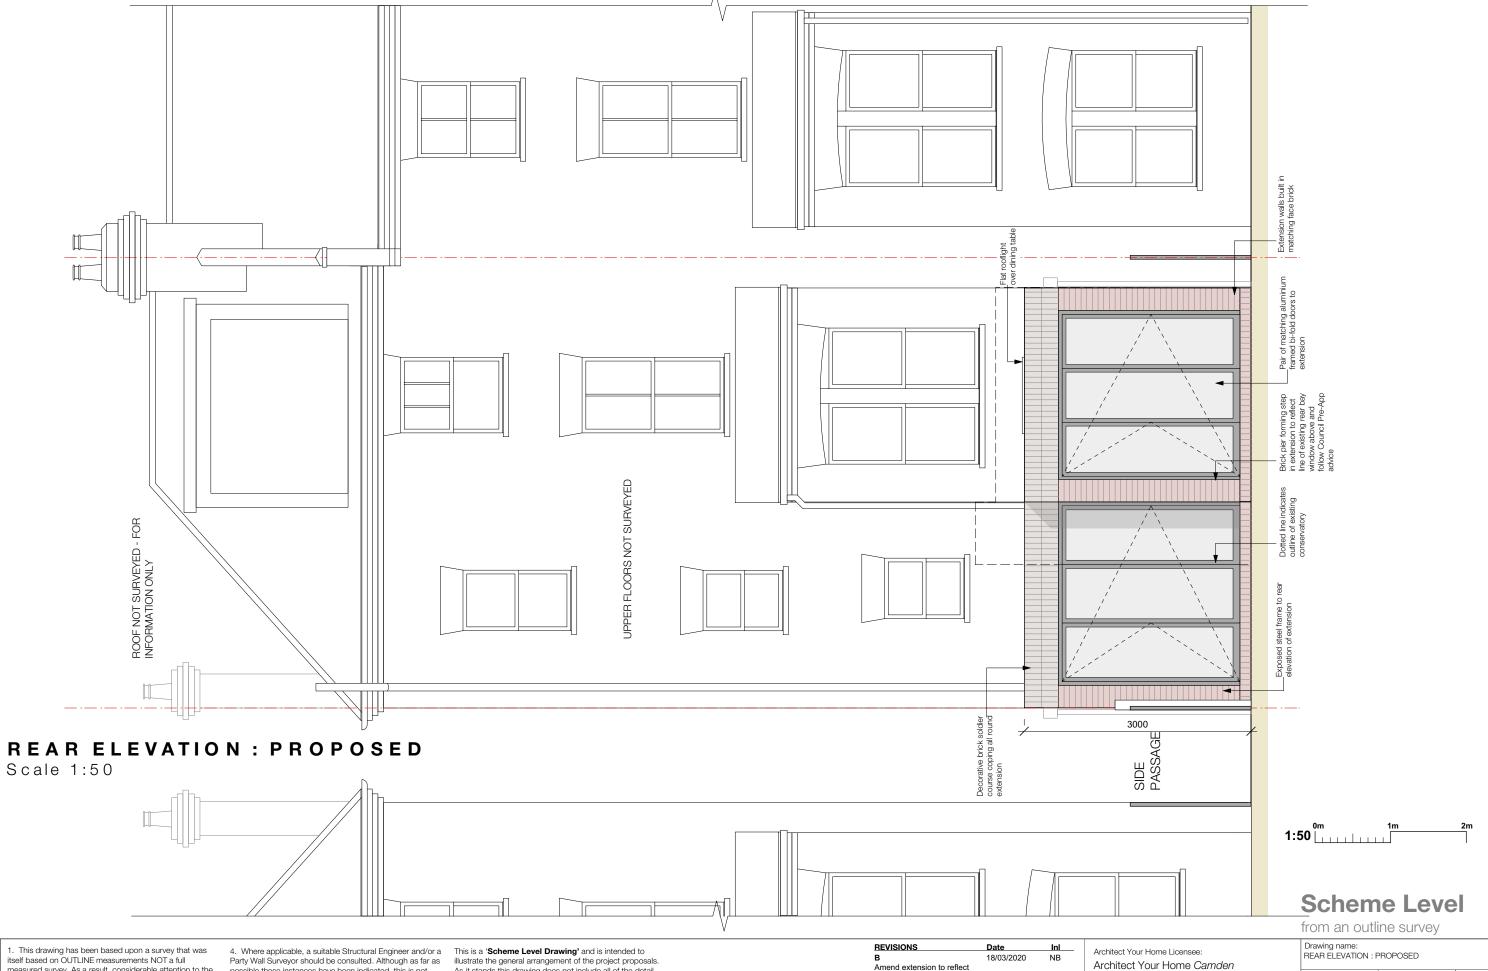

- 1. This drawing has been based upon a survey that was itself based on OUTLINE measurements NOT a full measured survey. As a result, considerable attention to the dimensions of any proposed works must be applied, taking site dimensions and templates as necessary.
- 2. While this drawing can be used as a base drawing for construction purposes, it is VERY IMPORTANT that all dimensions are checked carefully before any work commences or any materials are ordered.
- 3. This drawing can be used as part of a planning application, although your planning officer may ask for more specific information about some aspects of the design. For further information ask your architect.
- possible these instances have been indicated, this is not necessarily exhaustive and the whole scope of proposed works should be reviewed.
- 5. Unless other arrangements have been specifically made, your building contractor should serve a Building Notice, as and where applicable, to your local authority to satisfy the requirements of the Building Regulations. Your building contractor should also liaise with the Building Control Officer regarding routine inspections of the work.

illustrate the general arrangement of the project proposals. As it stands this drawing does not include all of the detail necessary for a full plans building regulations application.


While this drawing can be used as a base drawing for construction purposes, your building contractor may require more information. It is therefore important to discuss, with your architect & builder together, where more detail would be appropriate.


REVISIONS	Date	Inl
В	18/03/2020	NB
Amend extension to reflect		
Council Pre-App advice with		
stepped plan + depth		
reduction		
С	19/03/2020	NB
Extension doors		
D	03/07/2020	NB
Lantern revised to flat rooflight		
	A.HP	

All dimensions are in millimetres All dimensions to be checked on site © Architect Your Home

Drawing no: 4 Dartmouth Park Road London NW5 1SY 21/1/2020 08-271 09 Drawn by: Tel: 020 7485 3133 1:50 @ A3 NB

Project name 36A Goldhurst Terrace architectyourhome London, NW6 3HU

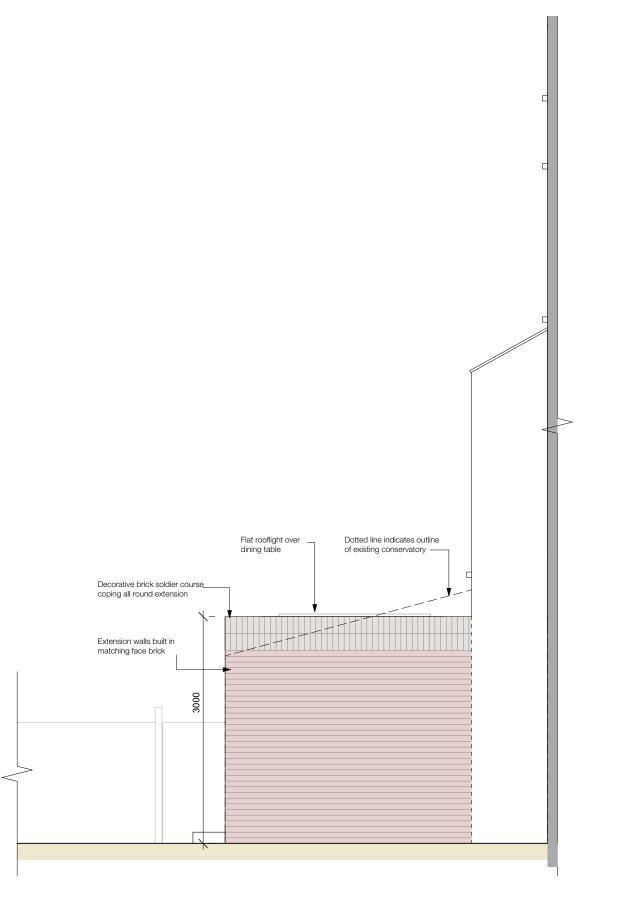

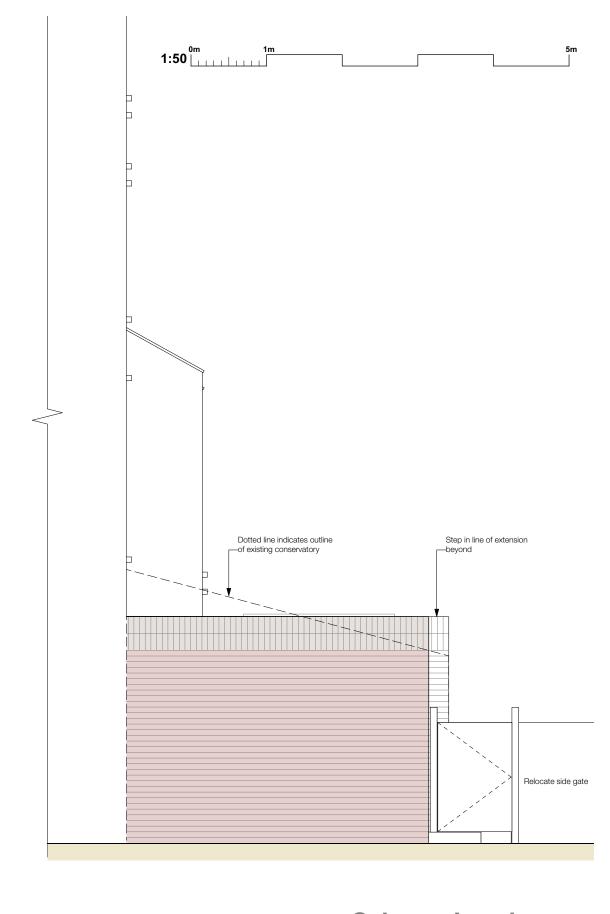

SOUTH SIDE ELEVATION: PROPOSED

Scale 1:50

1. This drawing has been based upon a survey that was itself based on OUTLINE measurements NOT a full measured survey. As a result, considerable attention to the dimensions of any proposed works must be applied, taking site dimensions and templates as necessary.

2. While this drawing can be used as a base drawing for construction purposes, it is VERY IMPORTANT that all dimensions are checked carefully before any work commences or any materials are ordered.

3. This drawing can be used as part of a planning application, although your planning officer may ask for more specific information about some aspects of the design. For further information ask your architect.

4. Where applicable, a suitable Structural Engineer and/or a Party Wall Surveyor should be consulted. Although as far as possible these instances have been indicated, this is not necessarily exhaustive and the whole scope of proposed works should be reviewed.

5. Unless other arrangements have been specifically made, your building contractor should serve a Building Notice, as and where applicable, to your local authority to satisfy the requirements of the Building Regulations. Your building contractor should also liaise with the Building Control Officer regarding routine inspections of the work.

This is a 'Scheme Level Drawing' and is intended to illustrate the general arrangement of the project proposals. As it stands this drawing does not include all of the detail necessary for a full plans building regulations application.

While this drawing can be used as a base drawing for construction purposes, your building contractor may require more information. It is therefore important to discuss, with your architect & builder together, where more detail would be appropriate.

NORTH SIDE ELEVATION: PROPOSED Scheme Level

Scale 1:50

REVISIONS Date Inl
A 18/03/2020 NB Architect Your Architect Your Council Pre-App advice with stepped plan + depth reduction B 03/07/2020 NB Lantern revised to flat rooflight

Architect Your Architect Y

All dimensions are in millimetres
All dimensions to be checked on site

Architect Your Home

Architect Your Home Licensee:
Architect Your Home Camden

Drawing name:
NORTH + SOUTH SIDE ELEVATIONS : PROPOSED

4 Dartmouth Park Road
London NW5 1SY

Tel: 020 7485 3133

Date:
22/1/2020

Scale:
1:50 @ A3

Project name:
36A Goldhurst Terrace
London, NW6 3HU

architectyourhome

Drawing no:

Drawn by:

10

NB

08-271