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27 John Street

Application: 2019/5338/L

Discharge of Conditions

Conditions 4a & 4c




Condition 4a


GROUND FLOOR

New opening formed in the existing non loadbearing wall.

See page 3 for details

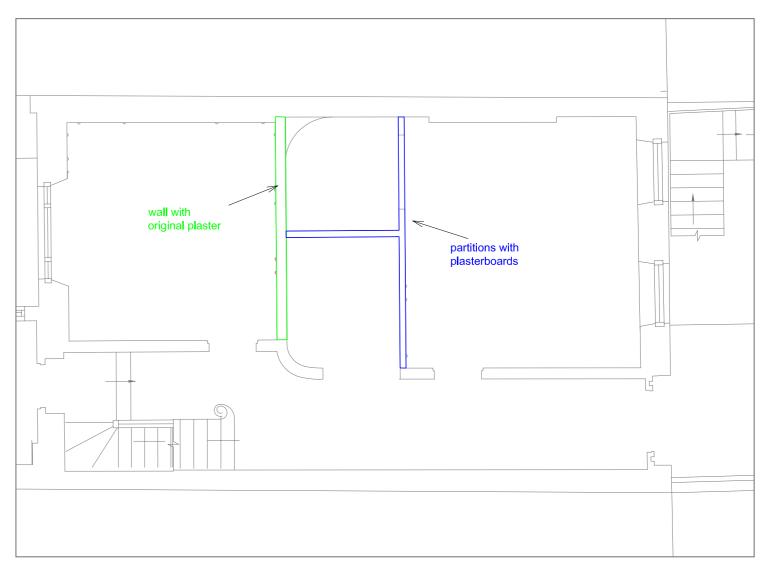

Ground Floor Opening

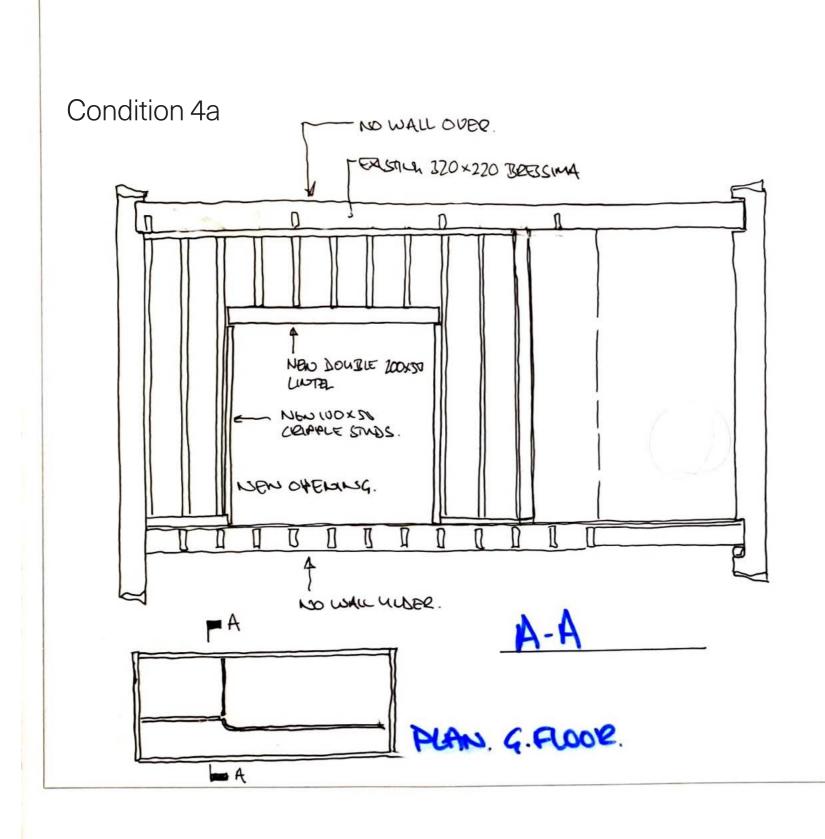

DOLES:

EXISTING WALL NOW LOAD BRADING.

CUT EXSTAND STUDS.


PROUDE NOW 200X100 LINTER &

100X 50 CREAPLE STUDS. FIXED WIM

SIMIN DIA SCREWS C 200 CRES.

PACK U/S OX CUT STUDS TIGHTY TO

LINTER.

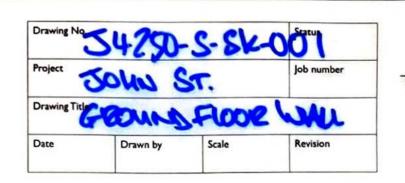




Condition 4a

FIRST FLOOR

The original opening through the wall will be reinstated.



Photograph of existing opening from rear room showing pre-existing timber frame lined with studwork and plasterboard

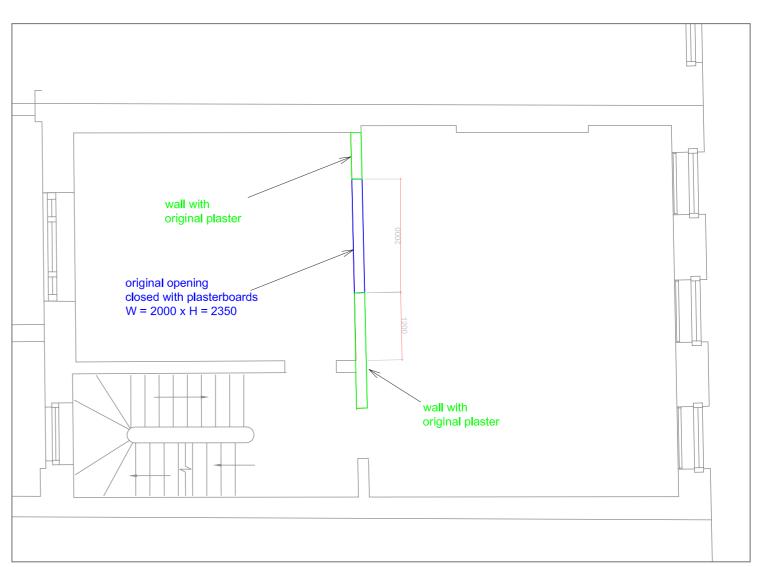

First Floor Opening

Condition 4c

SERVICE ROUTE STRATEGY

Vertical Route:

Two existing risers are already in place. These run the entire height of the building. The riser on the party wall with No.26 will be used predominantly to serve bathrooms. Additionally there is an existing SVP on the rear elevation of the house.

Basement:

Existing 650 wide x 175 deep service trench. To be re-used to take all piped and electrical services.

Ground floor:

All services run in the direction of the joists towards service risers. No joists will need to be cut.


1st 2nd and 3rd Floors.

The floor structure is comprised of a double system of 100×70 joists running perpendicular to 220×100 primary joists. The majority of services will run in the 100×70 zone. The deeper joist zone below allows for any crossovers below the 100×70 joists. Services never need to cross the 290×215 timber beams. No joists will need to be cut. Vertical routes will be shared between the existing internal riser and external SVP on the rear elevation.

4th Floor:

Where services cross joists they will run at high level on the 3rd floor below a dropped ceiling in the 3rd floor bathrooms. Services will then connect to the existing internal riser. No joists will need to be cut.


REFER TO PAGE 8 FOR DETAILS OF ALL FLOORS.

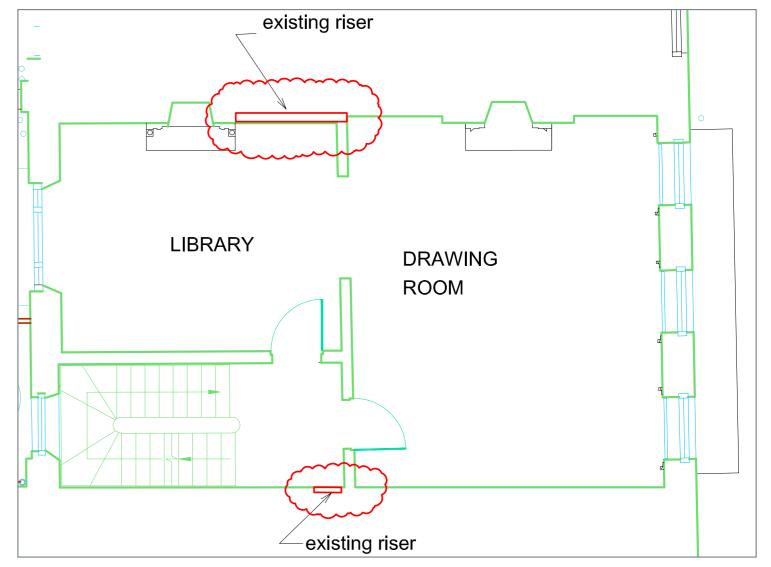


Internal Riser Locations

Condition 4c

BASEMENT

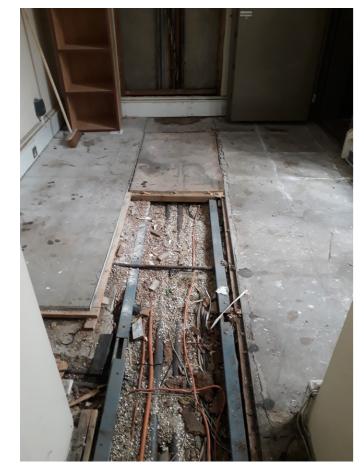


Photograph of the existing service trench in the basement slab

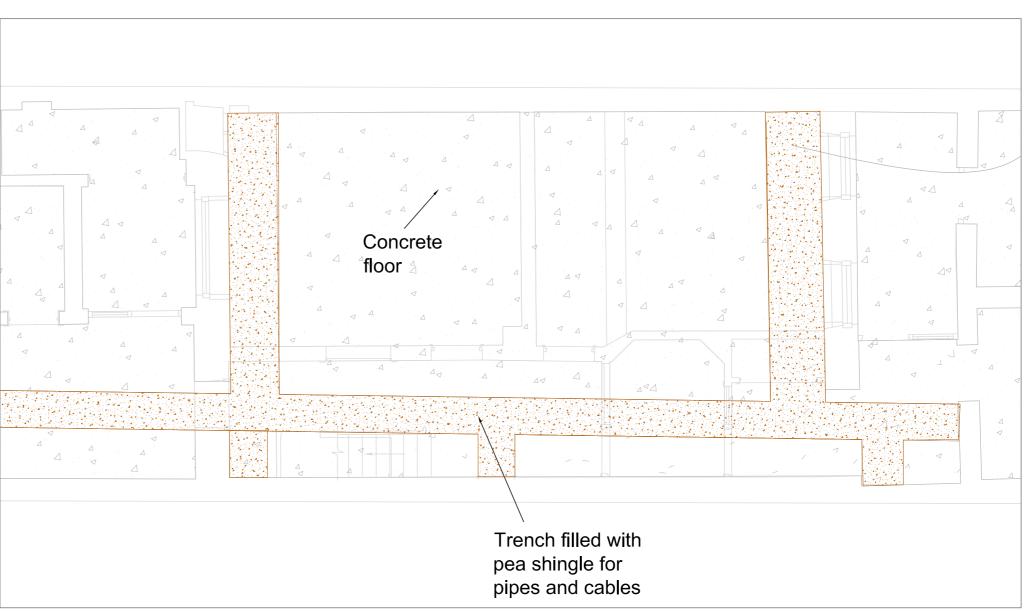

Basement floor

Condition 4c

1st, 2nd & 3rd FLOOR TYPICAL JOIST ARRANGEMENT

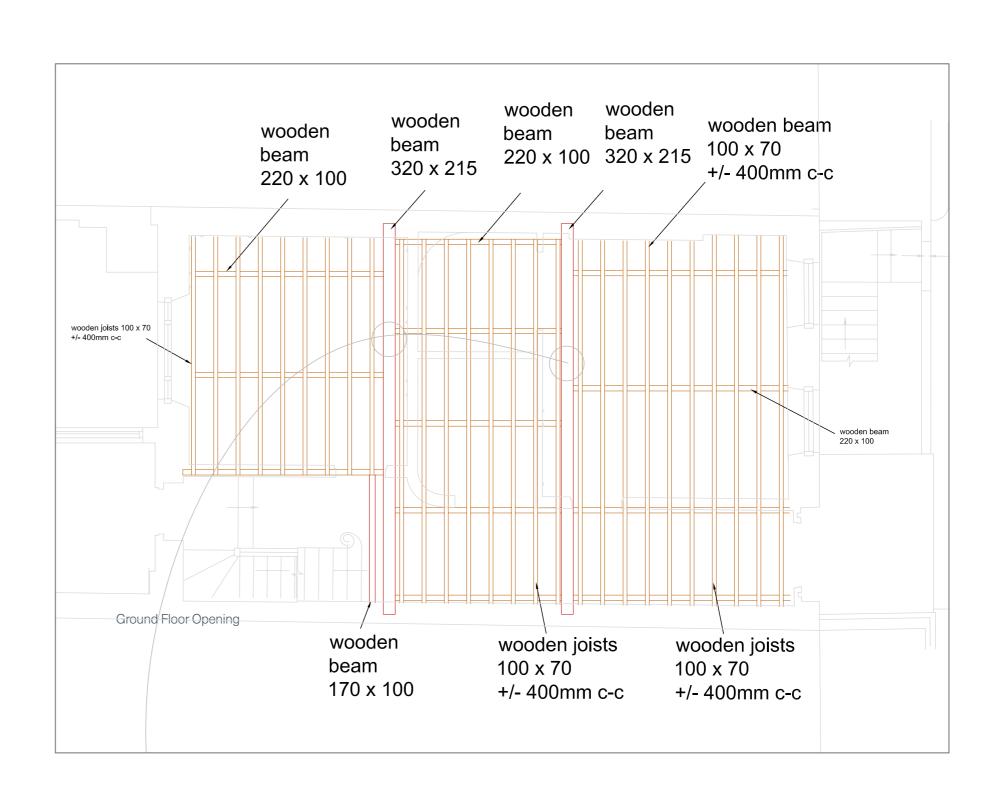


Note:

Final, accurate dimensions are to be confirm on site and setting out. Do not scale from drawing.

DETAILSSCALE 1:10 & 1:5

SCALE 1:10


Lower Ground Floor

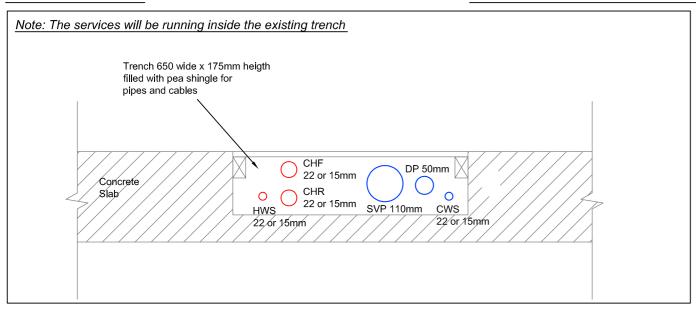

SCALE 1:5

Ground Floor

4th Floor

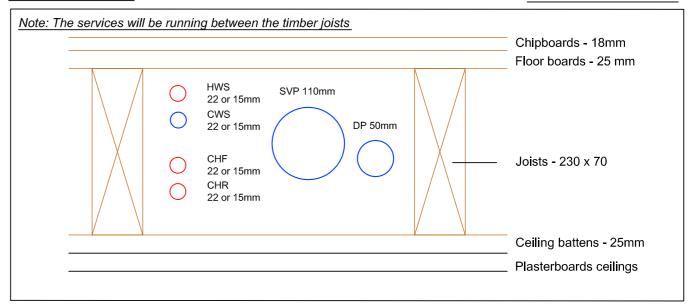

SCALE 1:5


1st / 2nd / 3rd Floors

JOS-MHC-015

05.06.2020

SCALE


REVIEWED BY:

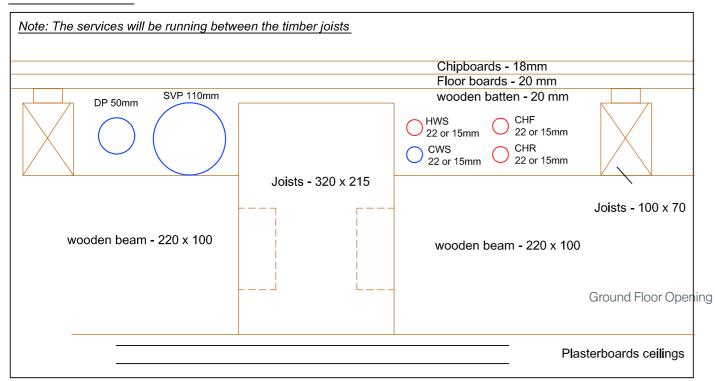

SCALE 1:5

AS SHOWN / DETAILS

A/S

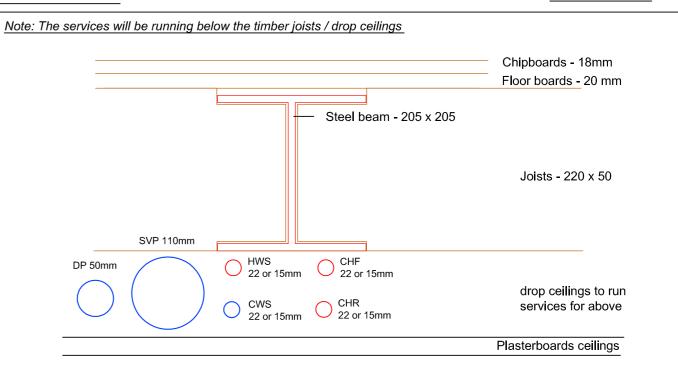

LEGEND:	2. D	VP - Soil vent pipe P - drainage pipe WS - hot water supply	4. 5. 6.	CWS - cold water supp CHF - central heating f DP - central heating re	low pipe
PROJECT NAME	27 JOHN STREET, LONDON, WC1N 2BX (JOS) DRAWING No				
PROPOSED	DETAILS - DRAINAGE/HEATING/GOLD AND HOT WATER SUPPLY DATE				DATE OF ISSUE

MHCOSTA