

1. This drawing has been based upon a measured survey by others. As a result, considerable attention to the dimensions of any proposed works must be applied, taking

site dimensions and templates as necessary. 2. While this drawing can be used as a base drawing for construction purposes, it is VERY IMPORTANT that all dimensions are checked carefully before any work

commences or any materials are ordered. 3. This drawing can be used as part of a planning application, although your planning officer may ask for more specific information about some aspects of the design. For further information ask your architect. 4. Where applicable, a suitable Structural Engineer and/or a Party Wall Surveyor should be consulted. Although as far as possible these instances have been indicated, this is not necessarily exhaustive and the whole scope of proposed works should be reviewed.

5. Unless other arrangements have been specifically made. your building contractor should serve a Building Notice, as and where applicable, to your local authority to satisfy the requirements of the Building Regulations. Your building contractor should also liaise with the Building Control Officer regarding routine inspections of the work.

This is a 'Scheme Level Drawing' and is intended to illustrate the general arrangement of the project proposals As it stands this drawing does not include all of the detail necessary for a full plans building regulations application.

While this drawing can be used as a base drawing for construction purposes, your building contractor may require more information. It is therefore important to discuss, with your architect & builder together, where more detail would be from measured survey by others

REVISIONS

Update demolitions

Date

07/04/2020

Drawing name: GROUND FLOOR PLAN : EXISTING Architect Your Home Licensee: Architect Your Home Camden 4 Dartmouth Park Road 24/03/2020 08-285 London NW5 1SY Scale: Tel: 020 7485 3133 1:50@A3


Project name: All dimensions are in millimetres All dimensions to be checked on site © Architect Your Home 27 Fairfax Place, LONDON, NW6 4EJ

architectyourhome

Drawing no:

Drawn by:

02

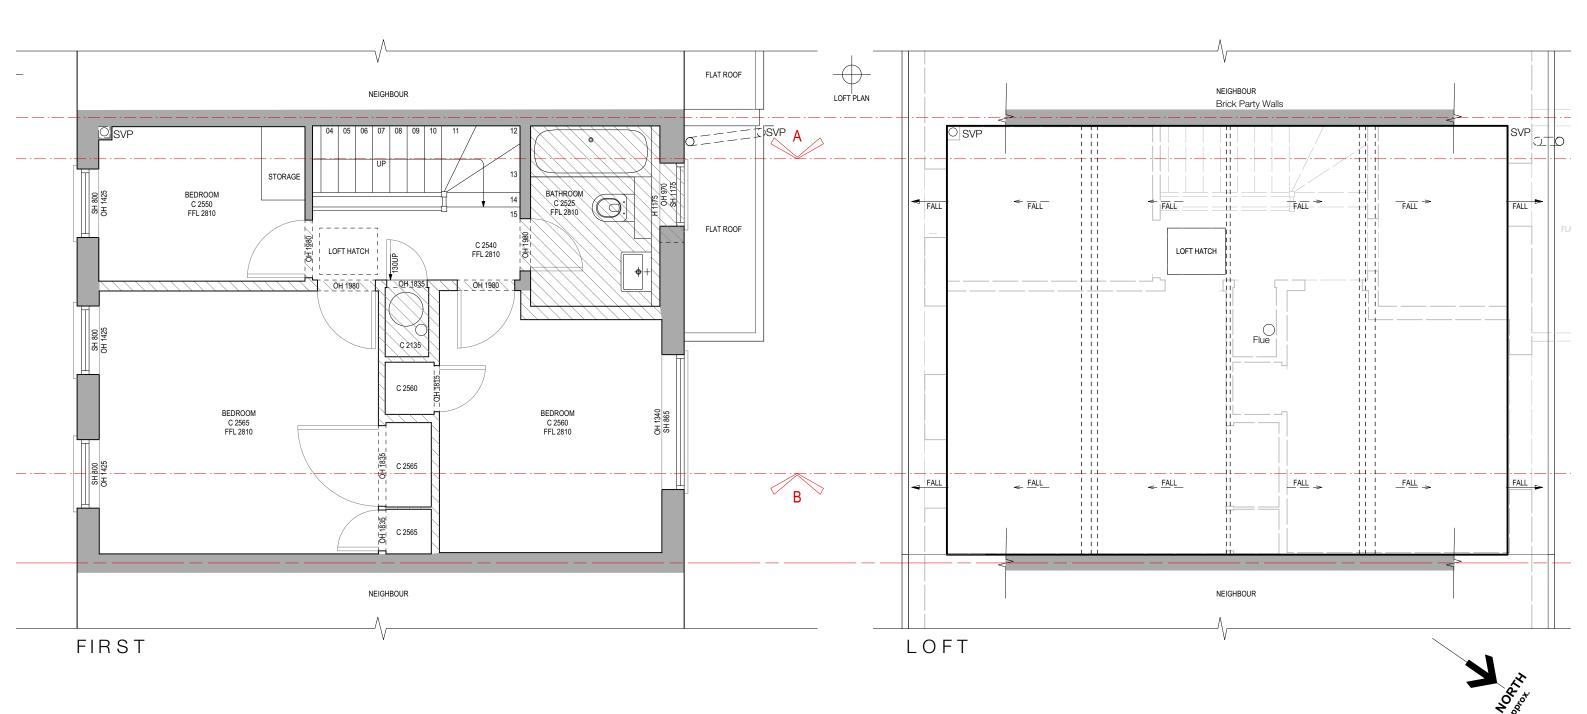

1:50 | 1

REVISIONS

Update demolitions

Date

07/04/2020

All dimensions are in millimetres
All dimensions to be checked on site
© Architect Your Home

Inl

FIRST + LOFT FLOOR PLANS : EXISTING

This drawing has been based upon a measured survey by others. As a result, considerable attention to the dimensions of any proposed works must be applied, taking site dimensions and templates as necessary.

Scale 1:50

- While this drawing can be used as a base drawing for construction purposes, it is VERY IMPORTANT that all dimensions are checked carefully before any work commences or any materials are ordered.
- 3. This drawing can be used as part of a planning application, although your planning officer may ask for more specific information about some aspects of the design. For further information ask your architect.
- 4. Where applicable, a suitable Structural Engineer and/or a Party Wall Surveyor should be consulted. Although as far as possible these instances have been indicated, this is not necessarily exhaustive and the whole scope of proposed works should be reviewed.
- 5. Unless other arrangements have been specifically made, your building contractor should serve a Building Notice, as and where applicable, to your local authority to satisfy the requirements of the Building Regulations. Your building contractor should also liaise with the Building Control Officer regarding routine inspections of the work.

This is a 'Scheme Level Drawing' and is intended to illustrate the general arrangement of the project proposals. As it stands this drawing does not include all of the detail necessary for a full plans building regulations application.

While this drawing can be used as a base drawing for construction purposes, your building contractor may require more information. It is therefore important to discuss, with your architect & builder together, where more detail would be appropriet.

Scheme Level

from measured survey by others

Drawing name: FIRST + LOFT SECOND FLOOR PLANS : EXISTING Architect Your Home Licensee: Architect Your Home Camden 4 Dartmouth Park Road 24/03/2020 08-285 03 London NW5 1SY Scale: Drawn by: Tel: 020 7485 3133 1:50@A3 NB/AB Project name: 27 Fairfax Place, LONDON, NW6 4EJ architectyourhome



1:50 0m 1m

REVISIONS

Update rooflights

Date

07/04/2020

Inl

FRONT ELEVATION: EXISTING showing proposed rooflights

 This drawing has been based upon a measured survey by others. As a result, considerable attention to the dimensions of any proposed works must be applied, taking

Scale 1:50

- dimensions of any proposed works must be applied, taking site dimensions and templates as necessary. 2. While this drawing can be used as a base drawing for construction purposes, it is VERY IMPORTANT that all
- dimensions are checked carefully before any work commences or any materials are ordered.
- 3. This drawing can be used as part of a planning application, although your planning officer may ask for more specific information about some aspects of the design. For further information ask your architect.
- 4. Where applicable, a suitable Structural Engineer and/or a Party Wall Surveyor should be consulted. Although as far as possible these instances have been indicated, this is not necessarily exhaustive and the whole scope of proposed works should be reviewed.
- 5. Unless other arrangements have been specifically made, your building contractor should serve a Building Notice, as and where applicable, to your local authority to satisfy the requirements of the Building Regulations. Your building contractor should also liaise with the Building Control Officer regarding routine inspections of the work.
- This is a 'Scheme Level Drawing' and is intended to illustrate the general arrangement of the project proposals. As it stands this drawing does not include all of the detail necessary for a full plans building regulations application.

While this drawing can be used as a base drawing for construction purposes, your building contractor may require more information. It is therefore important to discuss, with your architect & builder together, where more detail would be appropriate.

Scheme Level

from measured survey by others

- Architect Your Home Licensee:
 Architect Your Home Camden
 4 Dartmouth Park Road
 London NW5 1SY

 Tel: 020 7485 3133

 Drawing name:
 FRONT ELEVATION: EXISTING + PROPOSED


 Date:
 01/04/2020
 08-285
 04

 Scale:
 Revision:
 1:50@A3
 A

 NB/AB
- All dimensions are in millimetres
 All dimensions to be checked on site
 © Architect Your Home

 27 Fairfax Place, LONDON, NW6 4EJ

 architectyourhome

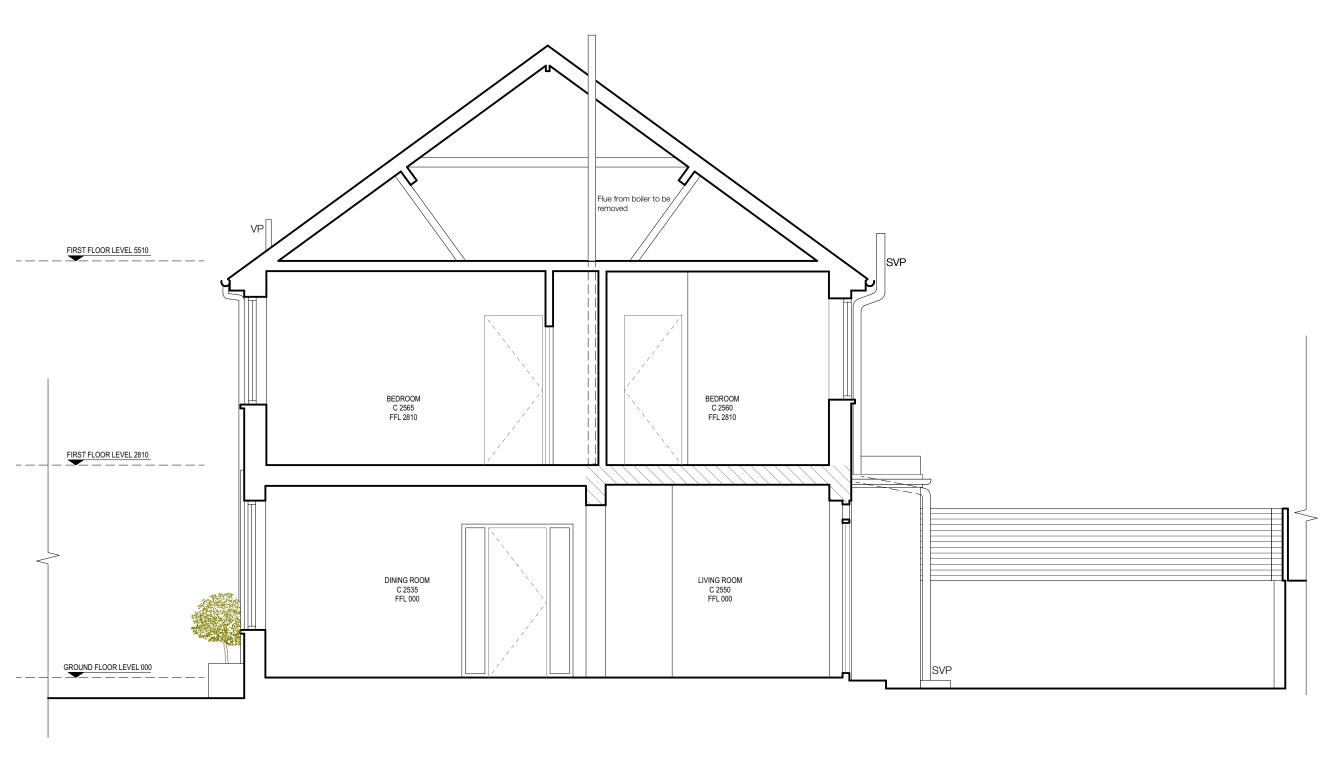

REVISIONS

Update flue removal


SECTION AA: EXISTING

Scale 1:50

- 1. This drawing has been based upon a measured survey by others. As a result, considerable attention to the dimensions of any proposed works must be applied, taking site dimensions and templates as necessary.
- While this drawing can be used as a base drawing for construction purposes, it is VERY IMPORTANT that all dimensions are checked carefully before any work commences or any materials are ordered.
- 3. This drawing can be used as part of a planning application, although your planning officer may ask for more specific information about some aspects of the design. For further information ask your architect.
- 4. Where applicable, a suitable Structural Engineer and/or a Party Wall Surveyor should be consulted. Although as far as possible these instances have been indicated, this is not necessarily exhaustive and the whole scope of proposed
- works should be reviewed.
 5. Unless other arrangements have been specifically made, your building contractor should serve a Building Notice, as and where applicable, to your local authority to satisfy the requirements of the Building Regulations. Your building contractor should also liaise with the Building Control Officer regarding routine inspections of the work.
- This is a 'Scheme Level Drawing' and is intended to illustrate the general arrangement of the project proposals. As it stands this drawing does not include all of the detail necessary for a full plans building regulations application.
 - While this drawing can be used as a base drawing for construction purposes, your building contractor may require more information. It is therefore important to discuss, with your architect & builder together, where more detail would be

Scheme Level

	from measured survey by others			
Date Inl 07/04/2020 AB	Architect Your Home Licensee: Architect Your Home Camden	Drawing name: SECTION A-A: EXISTING		
	4 Dartmouth Park Road London NW5 1SY	Date: 26/03/2020	Job no: 08-285	Drawing no:
	Tel: 020 7485 3133	Scale: 1:50+100@A3	Revision:	Drawn by: NB/AB
All dimensions are in millimetres All dimensions to be checked on site © Architect Your Home	Project name: 27 Fairfax Place, LONDON, NW6 4EJ	archite	ectyou	rhome

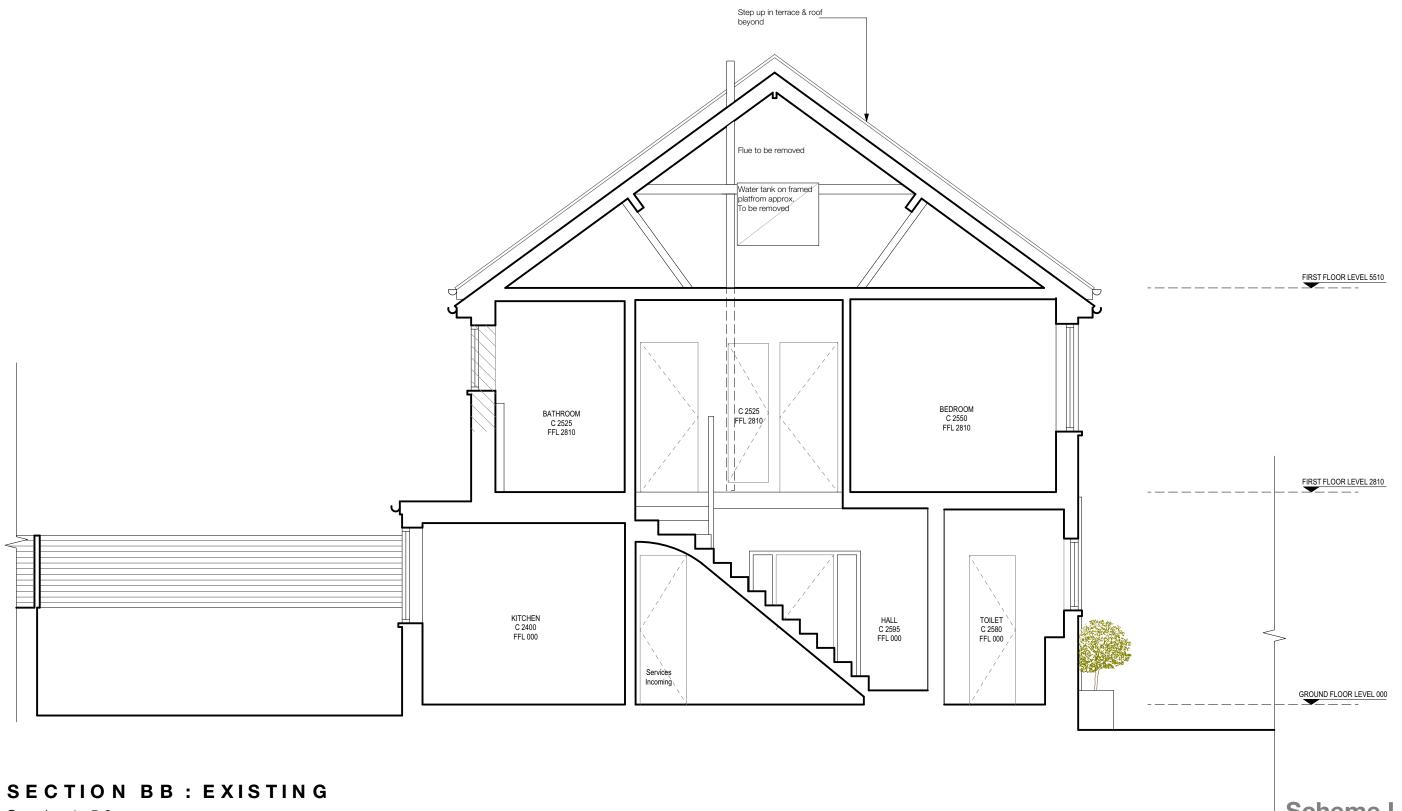

1:50 0m 11

Scale 1:50

- 1. This drawing has been based upon a measured survey by others. As a result, considerable attention to the dimensions of any proposed works must be applied, taking site dimensions and templates as necessary.
- 2. While this drawing can be used as a base drawing for construction purposes, it is VERY IMPORTANT that all dimensions are checked carefully before any work commences or any materials are ordered.
- 3. This drawing can be used as part of a planning application, although your planning officer may ask for more specific information about some aspects of the design. For further information ask your architect.
- Party Wall Surveyor should be consulted. Although as far as possible these instances have been indicated, this is not necessarily exhaustive and the whole scope of proposed works should be reviewed.
- 5. Unless other arrangements have been specifically made, your building contractor should serve a Building Notice, as and where applicable, to your local authority to satisfy the requirements of the Building Regulations. Your building contractor should also liaise with the Building Control Officer regarding routine inspections of the work.
- 4. Where applicable, a suitable Structural Engineer and/or a This is a 'Scheme Level Drawing' and is intended to illustrate the general arrangement of the project proposals. As it stands this drawing does not include all of the detail necessary for a full plans building regulations application.

While this drawing can be used as a base drawing for construction purposes, your building contractor may require more information. It is therefore important to discuss, with your architect & builder together, where more detail would be

Scheme Level from measured survey by others

Drawing name: SECTION B-B : EXISTING Architect Your Home Licensee: Architect Your Home Camden Drawing no: 4 Dartmouth Park Road Job no: 26/03/2020 08-285 06 London NW5 1SY Scale: Revision: Drawn by: Tel: 020 7485 3133 1:50@A3 NB/AB Project name: architectyourhome

All dimensions are in millimetres All dimensions to be checked on site © Architect Your Home


Date

07/04/2020

REVISIONS

Update demolitions

27 Fairfax Place, LONDON, NW6 4EJ

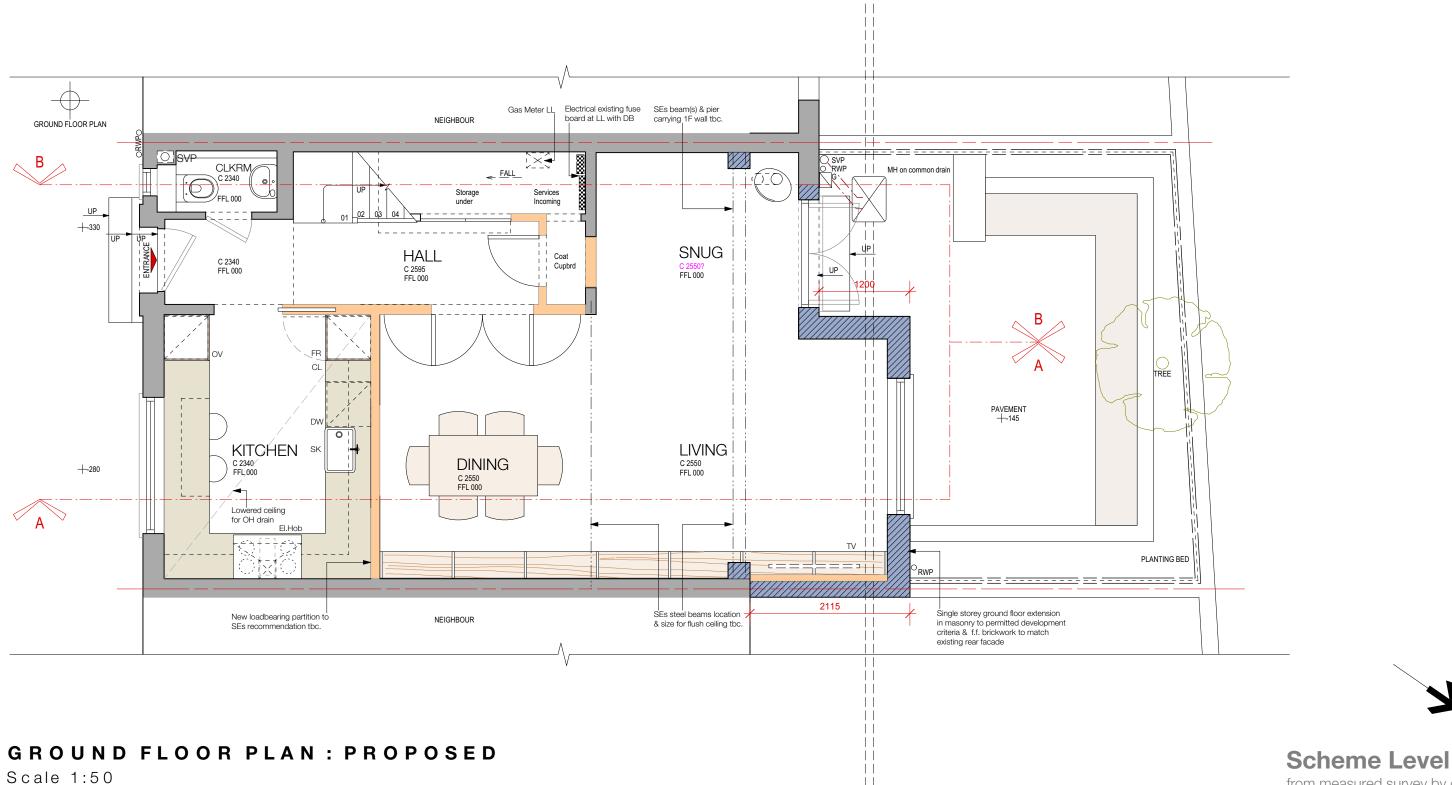

1. This drawing has been based upon a measured survey by others. As a result, considerable attention to the dimensions of any proposed works must be applied, taking site dimensions and templates as necessary.

While this drawing can be used as a base drawing for construction purposes, it is VERY IMPORTANT that all dimensions are checked carefully before any work commences or any materials are ordered.

3. This drawing can be used as part of a planning application, although your planning officer may ask for more specific information about some aspects of the design. For further information ask your architect.

4. Where applicable, a suitable Structural Engineer and/or a Party Wall Surveyor should be consulted. Although as far as possible these instances have been indicated, this is not necessarily exhaustive and the whole scope of proposed works should be reviewed.

5. Unless other arrangements have been specifically made, your building contractor should serve a Building Notice, as and where applicable, to your local authority to satisfy the requirements of the Building Regulations. Your building contractor should also liaise with the Building Control Officer regarding routine inspections of the work.

This is a 'Scheme Level Drawing' and is intended to illustrate the general arrangement of the project proposals As it stands this drawing does not include all of the detail necessary for a full plans building regulations application.

While this drawing can be used as a base drawing for construction purposes, your building contractor may require more information. It is therefore important to discuss, with your architect & builder together, where more detail would be appropriate.

REVISIONS Date Inl
A 07/04/2020 AB
Update arrangement to client requirements

Architect Your Home Licensee:
Architect Your Home Camden
4 Dartmouth Park Road
London NW5 1SY

Tel: 020 7485 3133

All dimensions are in millimetres
All dimensions to be checked on site

 Architect Your Home

from measured survey by others

Drawing name:
GROUND FLOOR PLAN: PROPOSED


Date:
27/03/2020

Does Drawing no:
08-285

O7

Scale:
Revision:
Drawn by:
NB/AB

architectyourhome

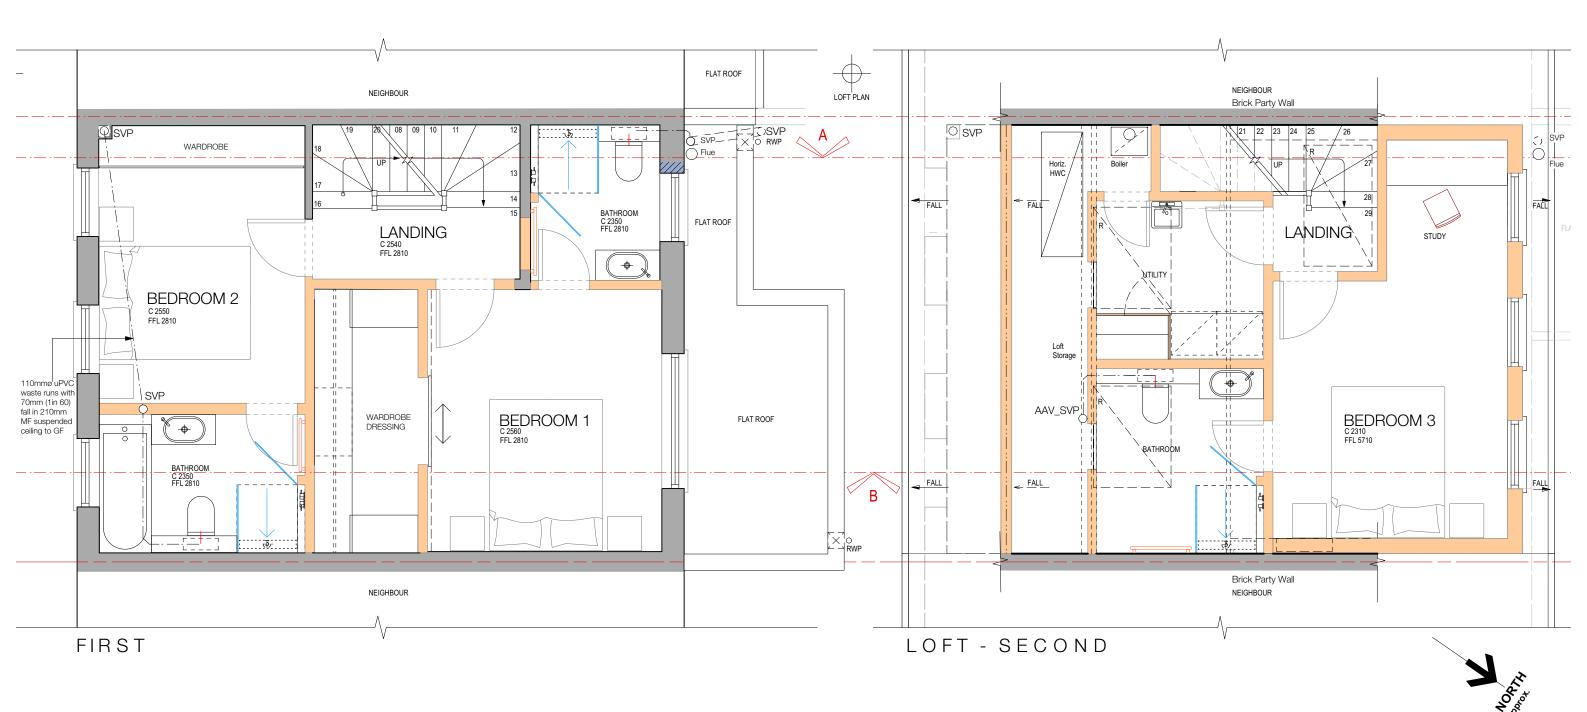

1:50 (m) 1

REVISIONS

Update arrangement to client

Date

07/04/2020

All dimensions are in millimetres All dimensions to be checked on site © Architect Your Home

Inl

FIRST + SECOND FLOOR PLANS: PROPOSED

This drawing has been based upon a measured survey by others. As a result, considerable attention to the dimensions of any proposed works must be applied, taking site dimensions and templates as necessary.

Scale 1:50

- While this drawing can be used as a base drawing for construction purposes, it is VERY IMPORTANT that all dimensions are checked carefully before any work commences or any materials are ordered.
- 3. This drawing can be used as part of a planning application, although your planning officer may ask for more specific information about some aspects of the design. For further information ask your architect.
- 4. Where applicable, a suitable Structural Engineer and/or a Party Wall Surveyor should be consulted. Although as far as possible these instances have been indicated, this is not necessarily exhaustive and the whole scope of proposed works should be reviewed.
- 5. Unless other arrangements have been specifically made, your building contractor should serve a Building Notice, as and where applicable, to your local authority to satisfy the requirements of the Building Regulations. Your building contractor should also liaise with the Building Control Officer regarding routine inspections of the work.

This is a 'Scheme Level Drawing' and is intended to illustrate the general arrangement of the project proposals As it stands this drawing does not include all of the detail necessary for a full plans building regulations application.

While this drawing can be used as a base drawing for construction purposes, your building contractor may require more information. It is therefore important to discuss, with your architect & builder together, where more detail would be appropriate.

Scheme Level

from measured survey by others

Drawing name: FIRST + SECOND FLOOR PLANS : PROPOSED Architect Your Home Licensee: Architect Your Home Camden 4 Dartmouth Park Road Drawing no: 01/04/2020 08-285 80 London NW5 1SY Scale: Drawn by: Tel: 020 7485 3133 1:50@A3 Project name: 27 Fairfax Place, LONDON, NW6 4EJ architectyourhome



07/04/2020

All dimensions are in millimetres

All dimensions to be checked on site © Architect Your Home

Update arrangement to client

REAR ELEVATION: EXISTING + PROPOSED

. This drawing has been based upon a measured survey by others. As a result, considerable attention to the dimensions of any proposed works must be applied, taking

site dimensions and templates as necessary.

2. While this drawing can be used as a base drawing for construction purposes, it is VERY IMPORTANT that all dimensions are checked carefully before any work commences or any materials are ordered.

Scale 1:50


- 3. This drawing can be used as part of a planning application, although your planning officer may ask for more specific information about some aspects of the design. For further information ask your architect.
- 4. Where applicable, a suitable Structural Engineer and/or a Party Wall Surveyor should be consulted. Although as far as possible these instances have been indicated, this is not necessarily exhaustive and the whole scope of proposed works should be reviewed.
- 5. Unless other arrangements have been specifically made, your building contractor should serve a Building Notice, as and where applicable, to your local authority to satisfy the requirements of the Building Regulations. Your building contractor should also liaise with the Building Control Officer regarding routine inspections of the work.
- This is a 'Scheme Level Drawing' and is intended to illustrate the general arrangement of the project proposals. As it stands this drawing does not include all of the detail necessary for a full plans building regulations application.

While this drawing can be used as a base drawing for construction purposes, your building contractor may require more information. It is therefore important to discuss, with your architect & builder together, where more detail would be

Scheme Level

from measured survey by others

Drawing name: REAR ELEVATION : EXISTING + PROPOSED Architect Your Home Licensee: Architect Your Home Camden 4 Dartmouth Park Road 01/04/2020 08-285 09 London NW5 1SY Drawn by: Tel: 020 7485 3133 1:50@A3 NB/AB Project name: architectyourhome 27 Fairfax Place, LONDON, NW6 4EJ

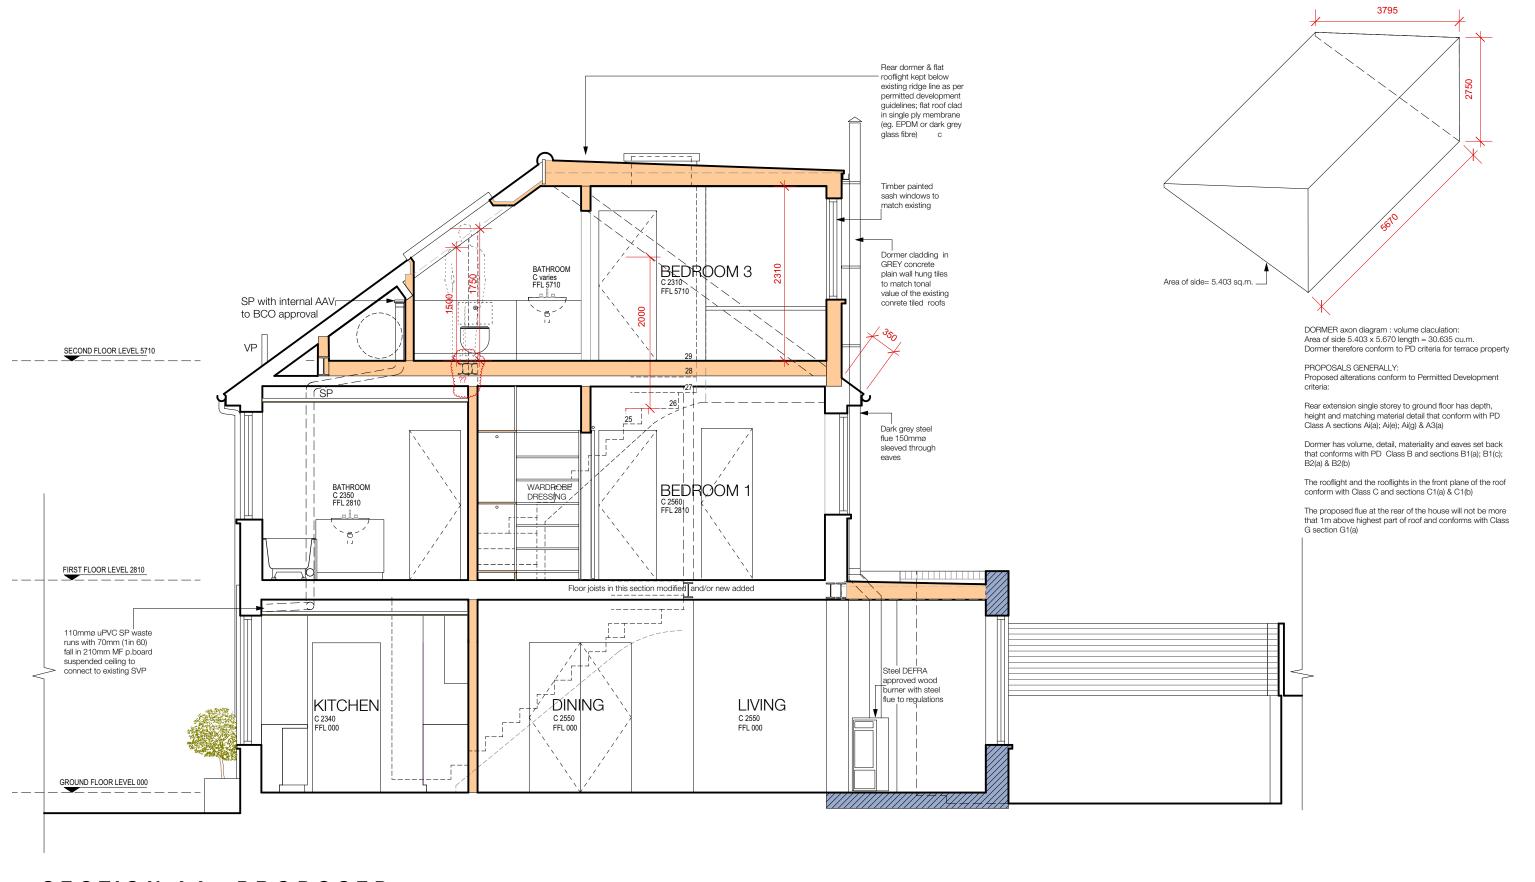

1:50 | 1

REVISIONS

requirements

Update arrangement to client

Date

07/04/2020

17/04/2020

AB

AB

All dimensions are in millimetres

All dimensions to be checked on site © Architect Your Home

SECTION AA: PROPOSED

 This drawing has been based upon a measured survey by others. As a result, considerable attention to the dimensions of any proposed works must be applied, taking

Scale 1:50

- site dimensions and templates as necessary.

 2. While this drawing can be used as a base drawing for construction purposes, it is VERY IMPORTANT that all dimensions are checked carefully before any work
- commences or any materials are ordered.
 3. This drawing can be used as part of a planning application, although your planning officer may ask for more specific information about some aspects of the design. For further information ask your architect.
- 4. Where applicable, a suitable Structural Engineer and/or a Party Wall Surveyor should be consulted. Although as far as possible these instances have been indicated, this is not necessarily exhaustive and the whole scope of proposed works should be reviewed.
- 5. Unless other arrangements have been specifically made, your building contractor should serve a Building Notice, as and where applicable, to your local authority to satisfy the requirements of the Building Regulations. Your building contractor should also liaise with the Building Control Officer regarding routine inspections of the work.

This is a 'Scheme Level Drawing' and is intended to illustrate the general arrangement of the project proposals As it stands this drawing does not include all of the detail necessary for a full plans building regulations application.

While this drawing can be used as a base drawing for construction purposes, your building contractor may require more information. It is therefore important to discuss, with your architect & builder together, where more detail would be appropriate.

Scheme Level

from measured survey by others Drawing name: SECTION AA : PROPOSED Architect Your Home Licensee: Architect Your Home Camden 4 Dartmouth Park Road Drawing no: 17/04/2020 08-285 London NW5 1SY 10 Scale: Drawn by: Tel: 020 7485 3133 1:50@A3 В NB/AB Project name: architectyourhome 27 Fairfax Place, LONDON, NW6 4EJ

