


Rear of no.36 including gate to side passage which forms access to land to rear of gardens



Rear elevation

#### EXISTING CONTEXT PHOTOS

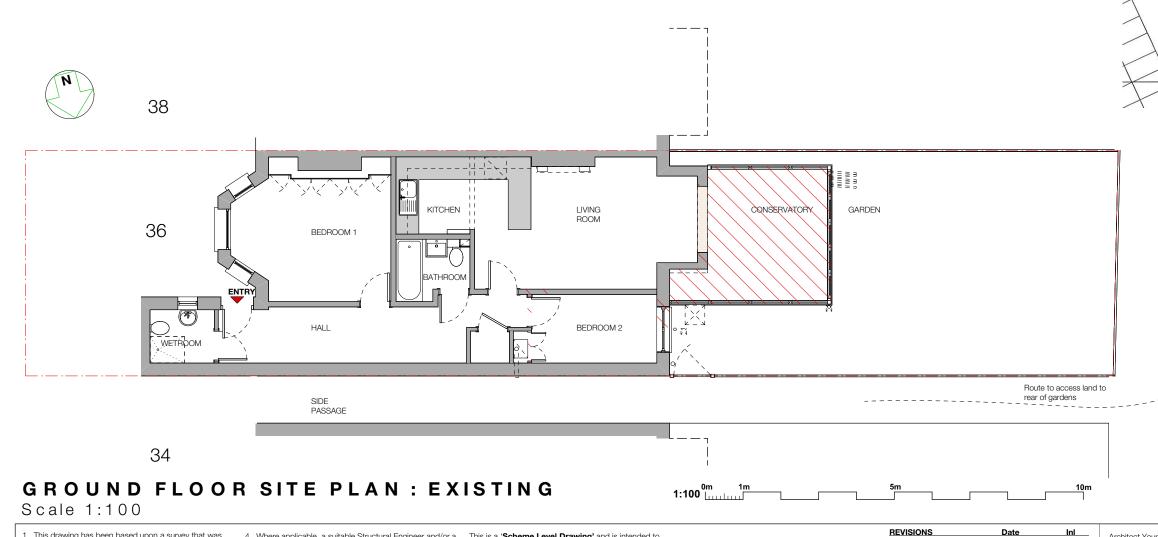

**Scheme Level** 

from an outline survey

34 36 38

**OS LOCATION PLAN** 

Scale 1:1250

1. This drawing has been based upon a survey that was itself based on OUTLINE measurements NOT a full measured survey. As a result, considerable attention to the dimensions of any proposed works must be applied, taking site dimensions and templates as necessary.

- 2. While this drawing can be used as a base drawing for construction purposes, it is VERY IMPORTANT that all dimensions are checked carefully before any work commences or any materials are ordered.
- 3. This drawing can be used as part of a planning application, although your planning officer may ask for more specific information about some aspects of the design. For further information ask your architect.
- 4. Where applicable, a suitable Structural Engineer and/or a Party Wall Surveyor should be consulted. Although as far as possible these instances have been indicated, this is not necessarily exhaustive and the whole scope of proposed works should be reviewed.
- 5. Unless other arrangements have been specifically made, your building contractor should serve a Building Notice, as and where applicable, to your local authority to satisfy the requirements of the Building Regulations. Your building contractor should also liaise with the Building Control Officer regarding routine inspections of the work.

This is a 'Scheme Level Drawing' and is intended to illustrate the general arrangement of the project proposals. As it stands this drawing does not include all of the detail necessary for a full plans building regulations application.

While this drawing can be used as a base drawing for construction purposes, your building contractor may require more information. It is therefore important to discuss, with your architect & builder together, where more detail would be appropriate.

All dimensions are in millimetres 36A Goldhurst Terrace All dimensions to be checked on site © Architect Your Home London, NW6 3HU

Reproduced from the Ordnance Survey Map with permission of the Controller of the Stationery Office Crown Copyright reserved

Licence No. AR 187240

Drawing name: LOCATION PLAN; SITE PLAN : EXISTING Architect Your Home Licensee Architect Your Home Camden 4 Dartmouth Park Road 16/1/2020 08-271 London NW5 1SY Tel: 020 7485 3133 1:100 @ A3

Project name

architectyourhome


Drawing no:

Drawn by:

03

NB



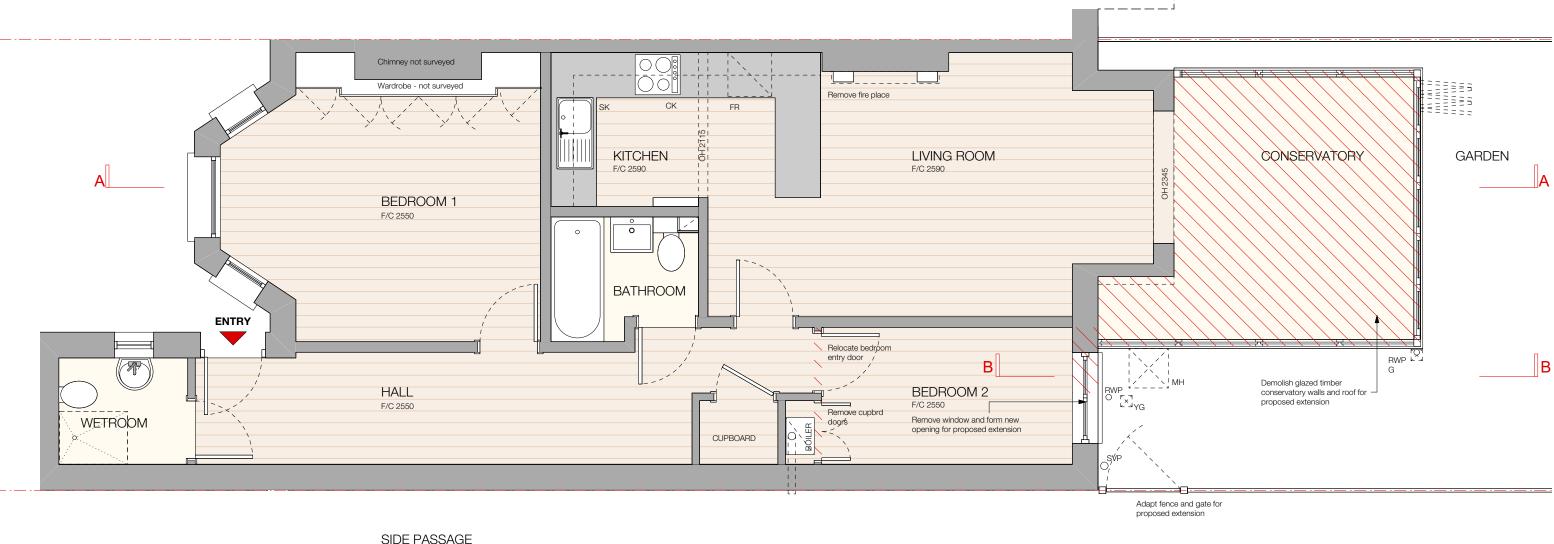

1:50 0m 1n

REVISIONS

Omit internal window

#### GROUND FLOOR PLAN: EXISTING

Scale 1:50


- 1. This drawing has been based upon a survey that was itself based on OUTLINE measurements NOT a full measured survey. As a result, considerable attention to the dimensions of any proposed works must be applied, taking site dimensions and templates as necessary.
- 2. While this drawing can be used as a base drawing for construction purposes, it is VERY IMPORTANT that all dimensions are checked carefully before any work commences or any materials are ordered.
- 3. This drawing can be used as part of a planning application, although your planning officer may ask for more specific information about some aspects of the design. For further information ask your architect.
- 4. Where applicable, a suitable Structural Engineer and/or a Party Wall Surveyor should be consulted. Although as far as possible these instances have been indicated, this is not necessarily exhaustive and the whole scope of proposed works should be reviewed.
- 5. Unless other arrangements have been specifically made, your building contractor should serve a Building Notice, as and where applicable, to your local authority to satisfy the requirements of the Building Regulations. Your building contractor should also liaise with the Building Control Officer regarding routine inspections of the work.

This is a 'Scheme Level Drawing' and is intended to illustrate the general arrangement of the project proposals. As it stands this drawing does not include all of the detail necessary for a full plans building regulations application.

While this drawing can be used as a base drawing for construction purposes, your building contractor may require more information. It is therefore important to discuss, with your architect & builder together, where more detail would be appropriate.

# **Scheme Level**

			from an ou	iline survey		
<b>Date</b> 09/04/2020	Inl NB	Architect Your Home Licensee: Architect Your Home <i>Camden</i> 4 Dartmouth Park Road London NW5 1SY	Drawing name: GROUND FLOOR PLAN : EXISTING			
			Date: 16/1/2020	Job no: 08-271	Drawing no: <b>04</b>	
		Tel: 020 7485 3133	Scale: 1:50 @ A3	Revision:	Drawn by: NB	
All dimensions are in millimetres All dimensions to be checked on site  © Architect Your Home		Project name: 36A Goldhurst Terrace London, NW6 3HU	archit	architectyourhome		

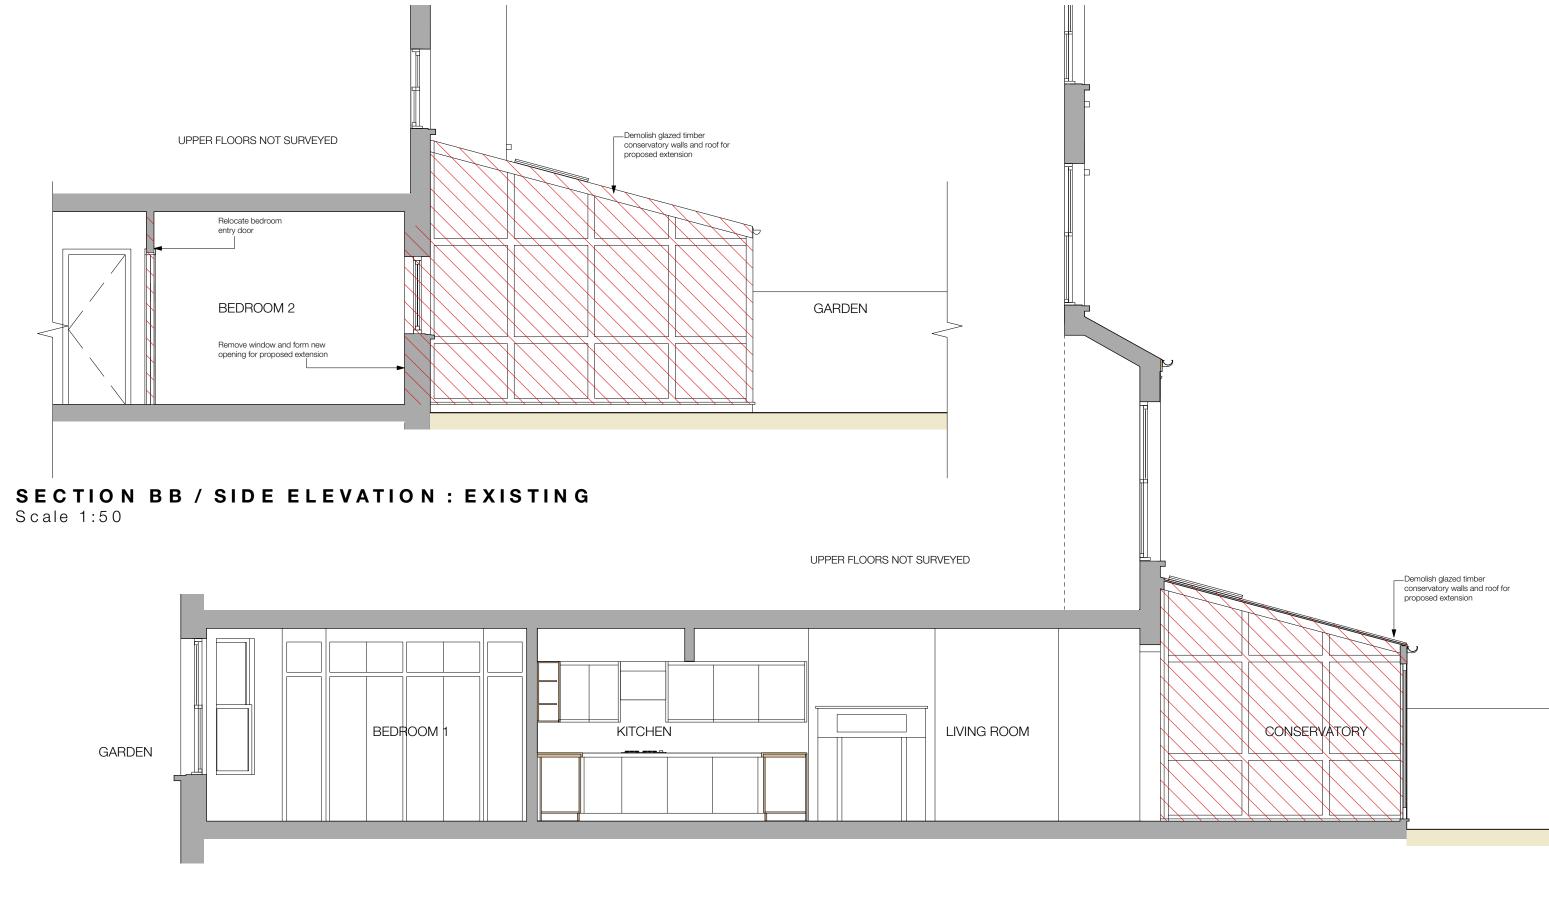

1:50 0m 1n

REVISIONS

Omit internal opening

Date

09/04/2020

All dimensions to be checked on site © Architect Your Home

London, NW6 3HU

### SECTION AA: EXISTING

1. This drawing has been based upon a survey that was itself based on OUTLINE measurements NOT a full

Scale 1:50

- measured survey. As a result, considerable attention to the dimensions of any proposed works must be applied, taking site dimensions and templates as necessary.
- 2. While this drawing can be used as a base drawing for construction purposes, it is VERY IMPORTANT that all dimensions are checked carefully before any work commences or any materials are ordered.
- 3. This drawing can be used as part of a planning application, although your planning officer may ask for more specific information about some aspects of the design. For further information ask your architect.
- 4. Where applicable, a suitable Structural Engineer and/or a Party Wall Surveyor should be consulted. Although as far as possible these instances have been indicated, this is not necessarily exhaustive and the whole scope of proposed works should be reviewed.
- 5. Unless other arrangements have been specifically made, your building contractor should serve a Building Notice, as and where applicable, to your local authority to satisfy the requirements of the Building Regulations. Your building contractor should also liaise with the Building Control Officer regarding routine inspections of the work.


This is a 'Scheme Level Drawing' and is intended to illustrate the general arrangement of the project proposals. As it stands this drawing does not include all of the detail necessary for a full plans building regulations application.

While this drawing can be used as a base drawing for construction purposes, your building contractor may require more information. It is therefore important to discuss, with your architect & builder together, where more detail would be appropriate.

# **Scheme Level**

from an outline survey

Drawing name: SECTION AA + SECTION BB/SIDE ELEVATION : EXISTING Architect Your Home Licensee: Architect Your Home Camden Drawing no: 4 Dartmouth Park Road 16/1/2020 08-271 05 London NW5 1SY Drawn by: Tel: 020 7485 3133 1:50 @ A3 NB Project name All dimensions are in millimetres 36A Goldhurst Terrace architectyourhome

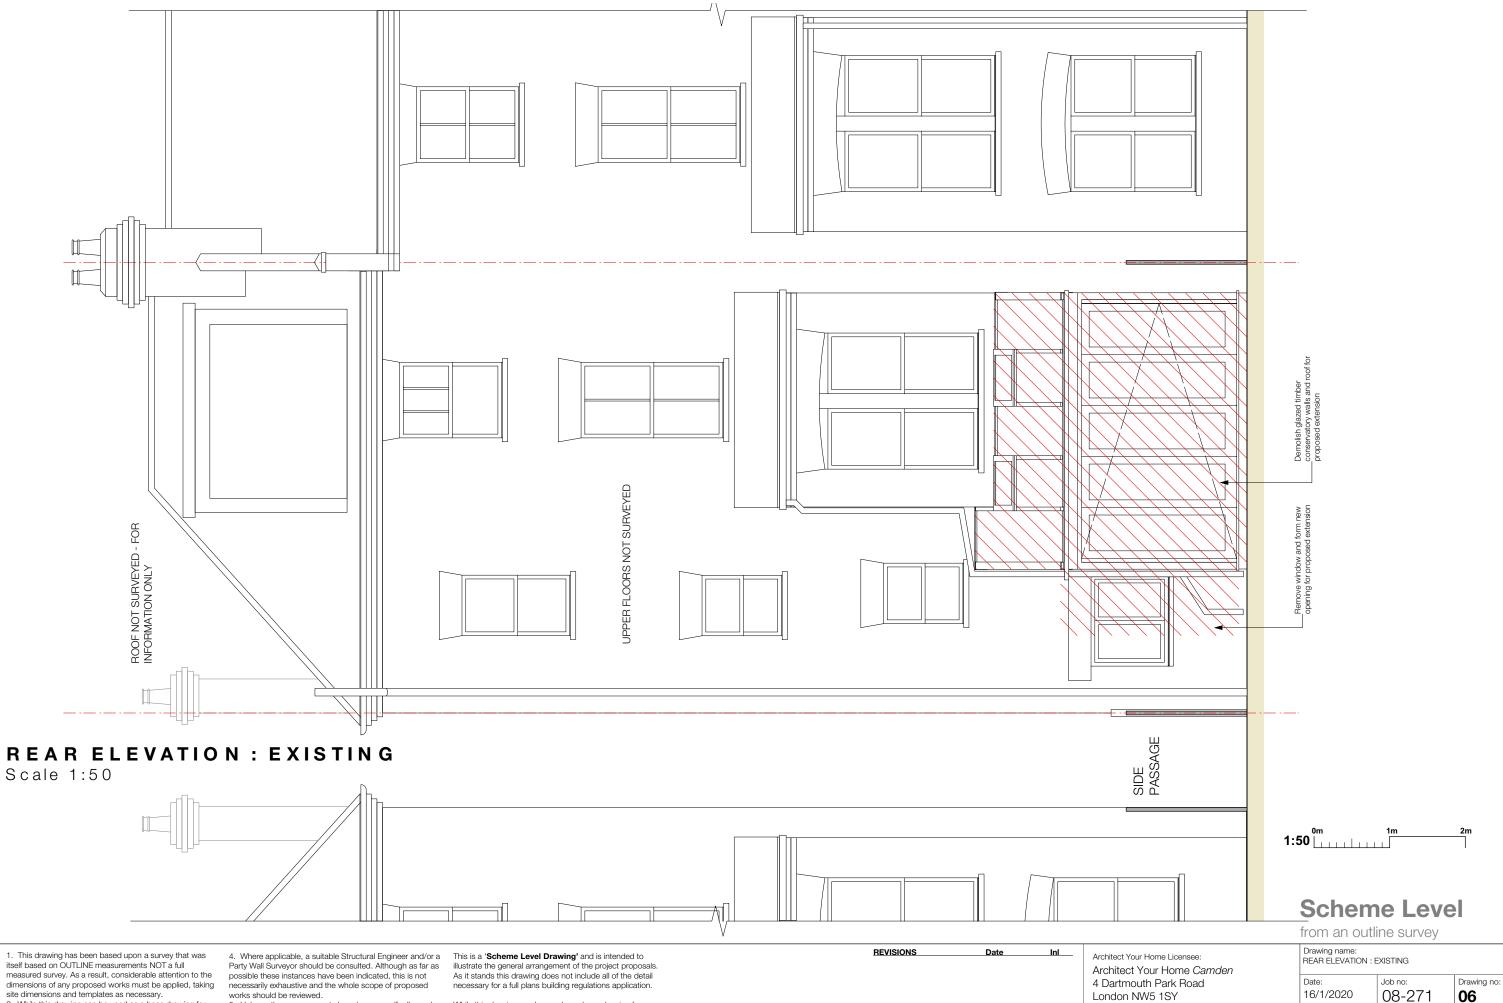

measured survey. As a result, considerable attention to the dimensions of any proposed works must be applied, taking site dimensions and templates as necessary.

2. While this drawing can be used as a base drawing for construction purposes, it is VERY IMPORTANT that all dimensions are checked carefully before any work commences or any materials are ordered.

3. This drawing can be used as part of a planning application, although your planning officer may ask for more specific information about some aspects of the design. For further information ask your architect.

5. Unless other arrangements have been specifically made, your building contractor should serve a Building Notice, as and where applicable, to your local authority to satisfy the requirements of the Building Regulations. Your building contractor should also liaise with the Building Control Officer regarding routine inspections of the work.

While this drawing can be used as a base drawing for construction purposes, your building contractor may require more information. It is therefore important to discuss, with your architect & builder together, where more detail would be appropriate.

London NW5 1SY

Tel: 020 7485 3133

All dimensions are in millimetres All dimensions to be checked on site © Architect Your Home 16/1/2020 08-271 1:50 @ A3

Project name: 36A Goldhurst Terrace London, NW6 3HU

NB architectyourhome

Drawn by: