




Third Floor Plan (Scale 1:50)

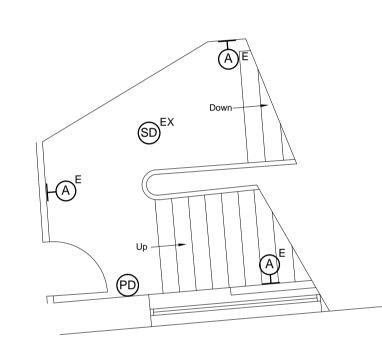

First Floor Plan (Scale 1:50)

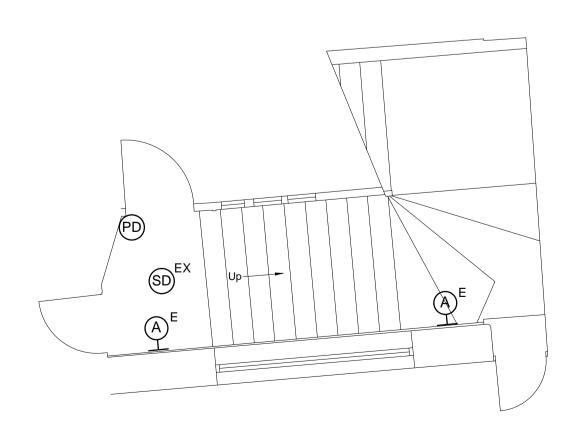

Ground Floor Plan (Scale 1:50)

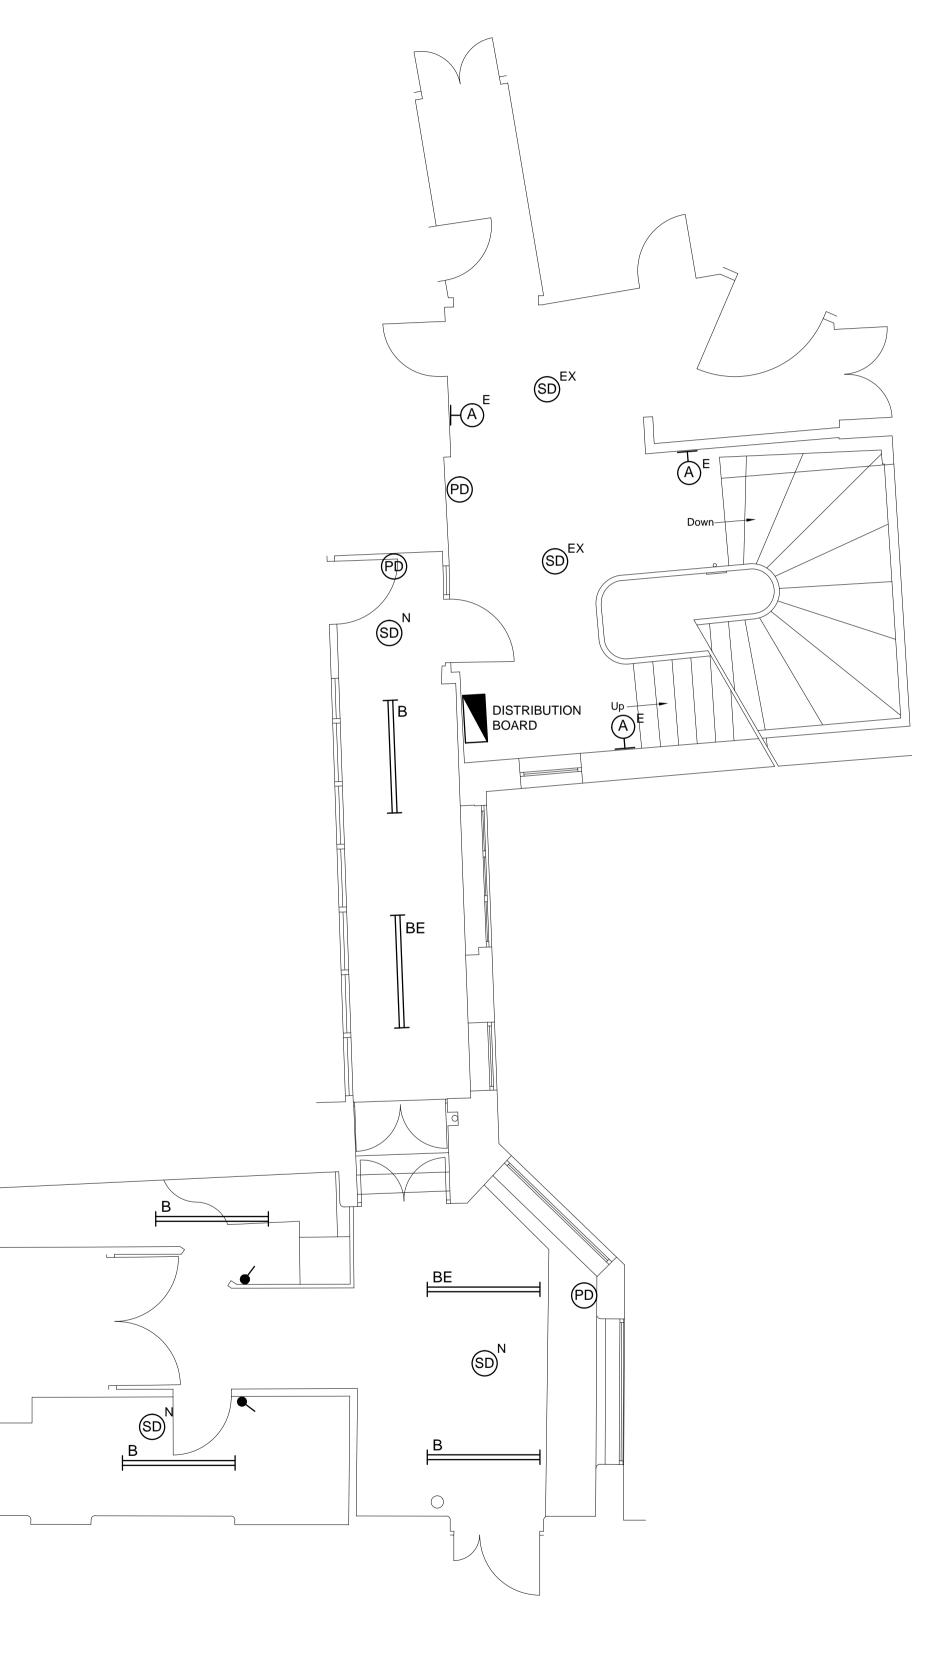


Second Floor Plan (Scale 1:50)

Mondia G2 WD2 LED1600-840 ET

TOC: 6777640



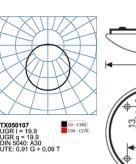



(€∰•<u>ॿ</u>॓ Offer text

Round surface-mounted LED luminaire with opal PMMA diffuser. For wall or ceilling mounting. Round, opal diffuser, spherical construction. Luminaire luminous flux 1800 lm, connected load 14,00 W, luminous efficiency of luminaire 114 lm/W. Light colour neutral white, correlated colour temperature (CCT) 4000 K, general colour rendering index (CR) R $_{\rm a} > 80$. Mean rated service life L $_{\rm 80}$ (t $_{\rm q}$ 25 °C) = 35,000 h, mean rated service life L $_{\rm 80}$ (t $_{\rm q}$ 25 °C) = 35,000 h. Luminaire body sheet steel. Surface is solvent-free powder-coated white (RAL 9016). Diameter of diffuser Ø 402 mm, luminaire height 110 mm. Permissible ambient temperature (ta): -20 °C - +25 °C. Safety class (EN 61140): I, protection rating (DIN EN 60529): IP40, impact resistance level in accordance with IEC 62262: IKO3, testing temperature of wire glow test in accordance with IEC 606952-11: 1: 650 °C. With electronic transformer, switchable. The luminaire complies with fundamental requirements of applicable EU regulations and product safety legislation and bears the CE symbol. The luminaire is also ENEC-certified by an independent testing authority.

Product features and key data residential areas Round surface-mounted LED luminaire with opal PMMA diffuser. Surface-mounting Round, opal diffuser, spherical construction 42 71 90 91 100 14 29 50 9 Colour rendering index Photobiological class Group 0 - no risk RAL9016 Traffic white With electronic transformer, switchable. Electrical version Connection method Mains frequency Ingress Protection (IP) IP40 Protection rating on room IP40 Protection class Impact resistance (IK) IK03 Hot wire resistance 650 °C

Luminaire Type A - Specification (not to scale))



Suitable for internal or external use of industrial areas Moisture-proof and dust-resistant IP65 fixture Supplied with TAMTEC LED modules Impact resistant construction

Construction:

Gear options including DALI and emergency available CRI: Ra>80 Up to 132 lumens per Watt efficacy 50,000 hours lifetime (L70/B50)

Grey polycarbonate body Supplied with opal diffuser Integral driver Stainless steel fixing clips Supplied as standard with neutral white (4000K) LED

V205 - Batten-fit PIR V206 - Batten-fit PIR and photocell V208 - Batten-fit with daylight dimming HFS - Microwave movement sensor HFSD - Dimmable microwave movement sensor D - Dimmable DALI M3 - 3 hours integrated emergency

A3 - Emergency self test

Luminaire Type B - Specification (not to scale))

SCHEDULE OF SYMBOLS

SYMBOL DESCRIPTION

TRILUX 7402N 1500 24W LUMINAIRE MAINTAINED EMERGENCY FITTING (REFER TO LUMINAIRE TYPE A TECHNICAL SPECIFICATION ABOVE)

TAMLITE EXTREME EWPL 2574NW LUMINAIRE ☐ (REFER TO LUMINAIRE TYPE B TECHNICAL SPECIFICATON ABOVE)

DENOTES LUMINAIRE COMPLETE WITH EMERGENCY LIGHTING FACILITIES

DANLERS CESR PIR PRESENCE DETECTOR

ONE WAY LIGHTING SWITCH EXISTING FIRE ALARM SMOKE DETECTOR

NEW FIRE ALARM SMOKE DETECTOR

COMPLETE WITH SOUNDER BASE

EXISTING DISTRIBUTION BOARD

NEW FIRE ALARM SMOKE DETECTOR

This drawing is copyright and may not be reproduced or made use of unless expressly agreed by J. FARLEY CONTRACTS LIMITED

DO NOT SCALE - ALL DIMENSIONS TO BE CONFIRMED

1. DO NOT SCALE THIS DRAWINGS - ALWAYS WORK FROM SITE TAKEN DIMMENSIONS

-	20.01.20	ISSUED FOR COMMENTS/APPROVAL	
REV	DATE	AMENDMENT	

CLIENT

NEILCOTT CONSTRUCTION LTD

PROJECT

HEAL & SON LIMITED THE HEAL'S BUILDING 196 TOTTENHAM COURT ROAD LONDON W1T 7LQ

DRAWING TITLE

REAR STAIRCASE PROPOSED MODIFICATIONS TO ELECTRICAL SERVICES LAYOUT



J Farley Contracts Ltd Unit 6, The Metro Business Centre Kangley Bridge Road, London SE26 5BW Tel: 0208 650 7022 Email: Jfcontracts@btconnect,com

	•		
SCALE	DATE	DRN.	CHKD
1-50@A1	JANUARY 2020	EDS	JF
DRAWING No.	REV.		
JFC/202	-	•	