

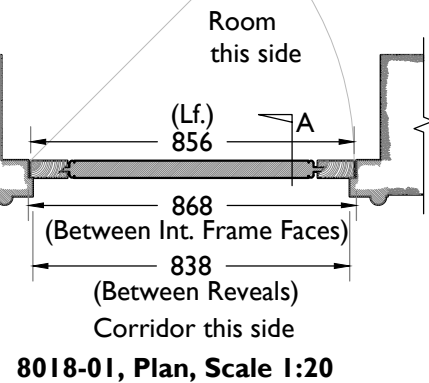


8018-05,  
Plan Details  
Scale: 1:2


8018-06,  
Section AA Details  
Scale: 1:2

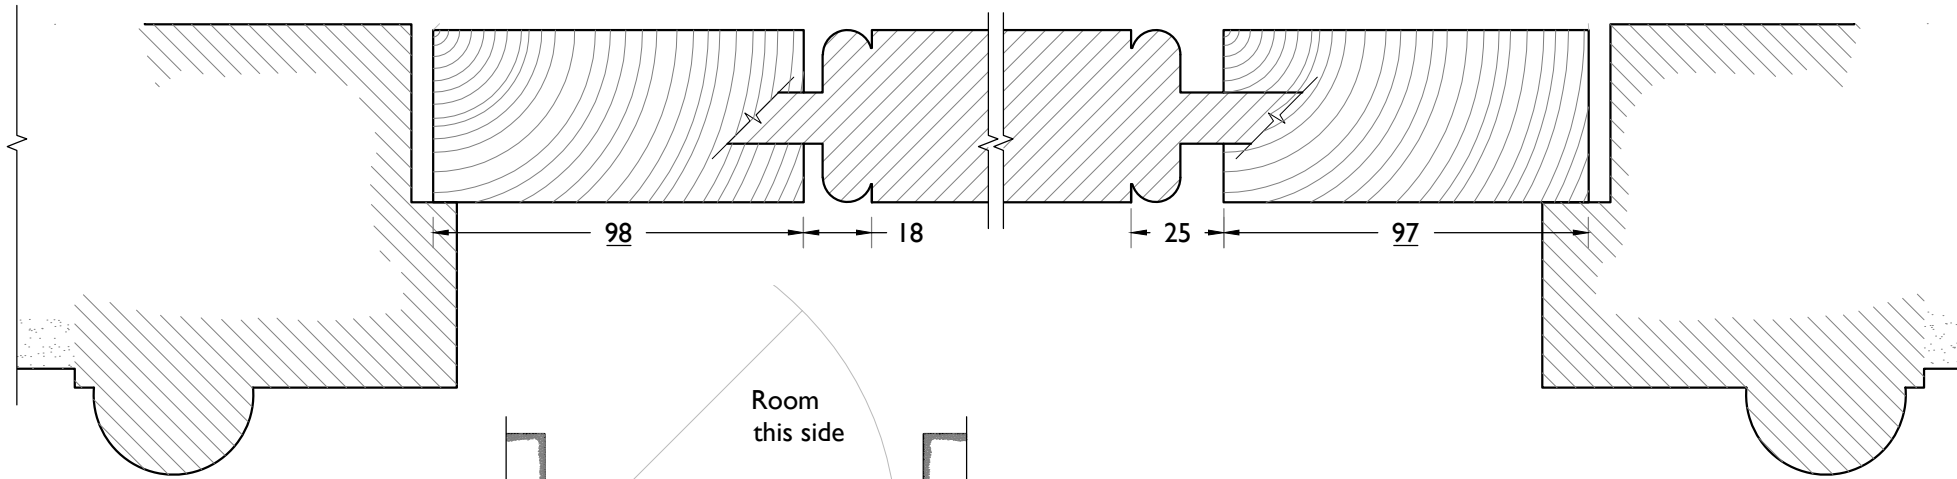


8018-01, Plan, Scale 1:20

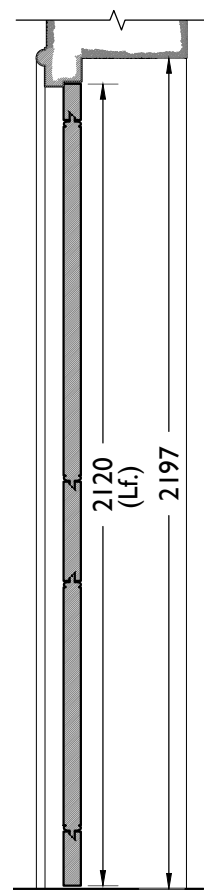

8018-02,  
Section AA  
Scale: 1:20

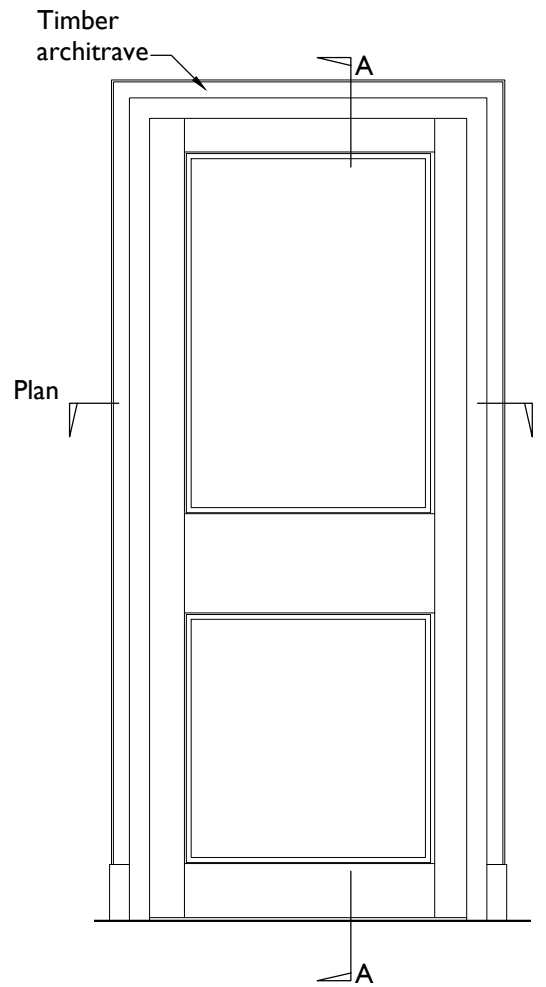

8018-03,  
Elevation viewed from corridor side  
Scale: 1:20

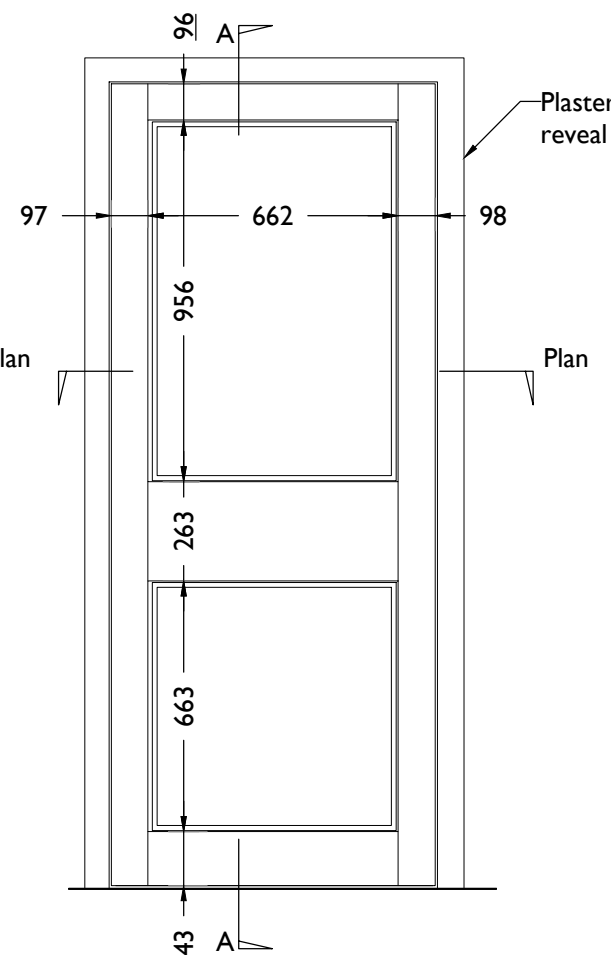

8018-04,  
Elevation viewed from room side  
Scale: 1:20

**E16 Specification Notes**

This drawing must be read in conjunction with the general notes on drawing 8040.

These notes are for the construction of replica doors that have no fire requirement. If door has fire requirement see 8040 notes. Generally replicate the existing door after surveying it on site. This drawing indicates the general details of the existing door type but must not be used as a fabrication drawing. The contractor must use its expertise to produce accurate shop drawings.

**Material:** To match existing

**Panel:** Solid timber raised and fielded with moulding to match existing.

**Finish:** To match existing colour and texture as closely as possible. Allow for 6 samples of 200mm x 200mm Oak panel to be stained and varnished to enable colour and texture of existing to be matched. In the first instance, produce two samples and notify the architect when complete to arrange inspection. After inspection further samples may be required to achieve the closest match possible.

**Action:** Door opens in one direction only.

**Door knobs:** to match original brass knobs. Refurbish existing and reuse if possible. If not possible, search project collection of salvaged door furniture for matching knob. In the event of salvage being impossible a replica will be required.

**Lock:** Provisionally allow for supply and installation of high security five lever mortice deadlock case and escutcheons in polished brass finish to match existing appearance of original items.

**Hinges:** 3x Polished brass butt hinge - double phosphor bronze washed to match size of existing hinges.

**Electronic Security:** Please see the *Hoare Lea* security design package for electronic locking requirements and specifications for each door. Please note that these requirements are also outlined on the door schedule. However, the door schedule should not be relied upon on its own as the security design package contains the key design and specification information describing the required installation.

**Closer (not fire rated):** Please see door schedule to establish which doors require a closer. Where a closer is required on a non fire rated door it will be the Abloy DC330 (Brass finish) and associated items required for full installation.

**Notes:**  
Drawings are based on survey data and may not accurately represent what is physically present.  
Do not scale from this drawing. All dimensions are to be verified on site before proceeding with the work.  
All dimensions are in millimeters unless noted otherwise.  
Purcell shall be notified in writing of any discrepancies.

- Timber door with timber panels
- Panel generally fits poorly

P00	18 Dec 2019			
First Issue	27 Sep 2019	RH	RH	
ISSUE	DATE	DRAWN	CHECKED	DESCRIPTION

**CLIENT** Lendlease  
**PROJECT** Camden Town Hall

**DRAWING TITLE** Details of Existing Door Type E16  
This existing door is DEB.76-1  
**SIZE & SCALE** A3L As Noted  
**DRAWING STATUS** ISSUED FOR LBC

**JOB NUMBER** 238664  
**DRAWING NO.** CTH-PUR-XXX-DR-31-A-8018  
**REVISION** P00

