


NOTE: ARCHITECTURAL DRAWING USED FOR COMPILATION OF IN2 DRAWING.
ARCHITECTURAL DRAWING REVISION:
DATE RECEIVED: 14.06.2019

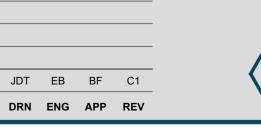

ENGINEERING DESIGN PARTNERSHIP
DUBLIN . ATHLONE . BELFAST . LONDON

BELSIZE PARK FIRESTATION

CLIENT

PLATINUM LAND

DRAWING TITLE

MECHANICAL SERVICES INSTALLATION

SOUTH & WEST EXTERNAL ELEVATIONS

VENTILATION SERVICES LAYOUT

STATUS S4


WEST ELEVATION


22.07.2019


STATUS DATE


CONSTRUCTION ISSUE

SCALE: 1:100@A1

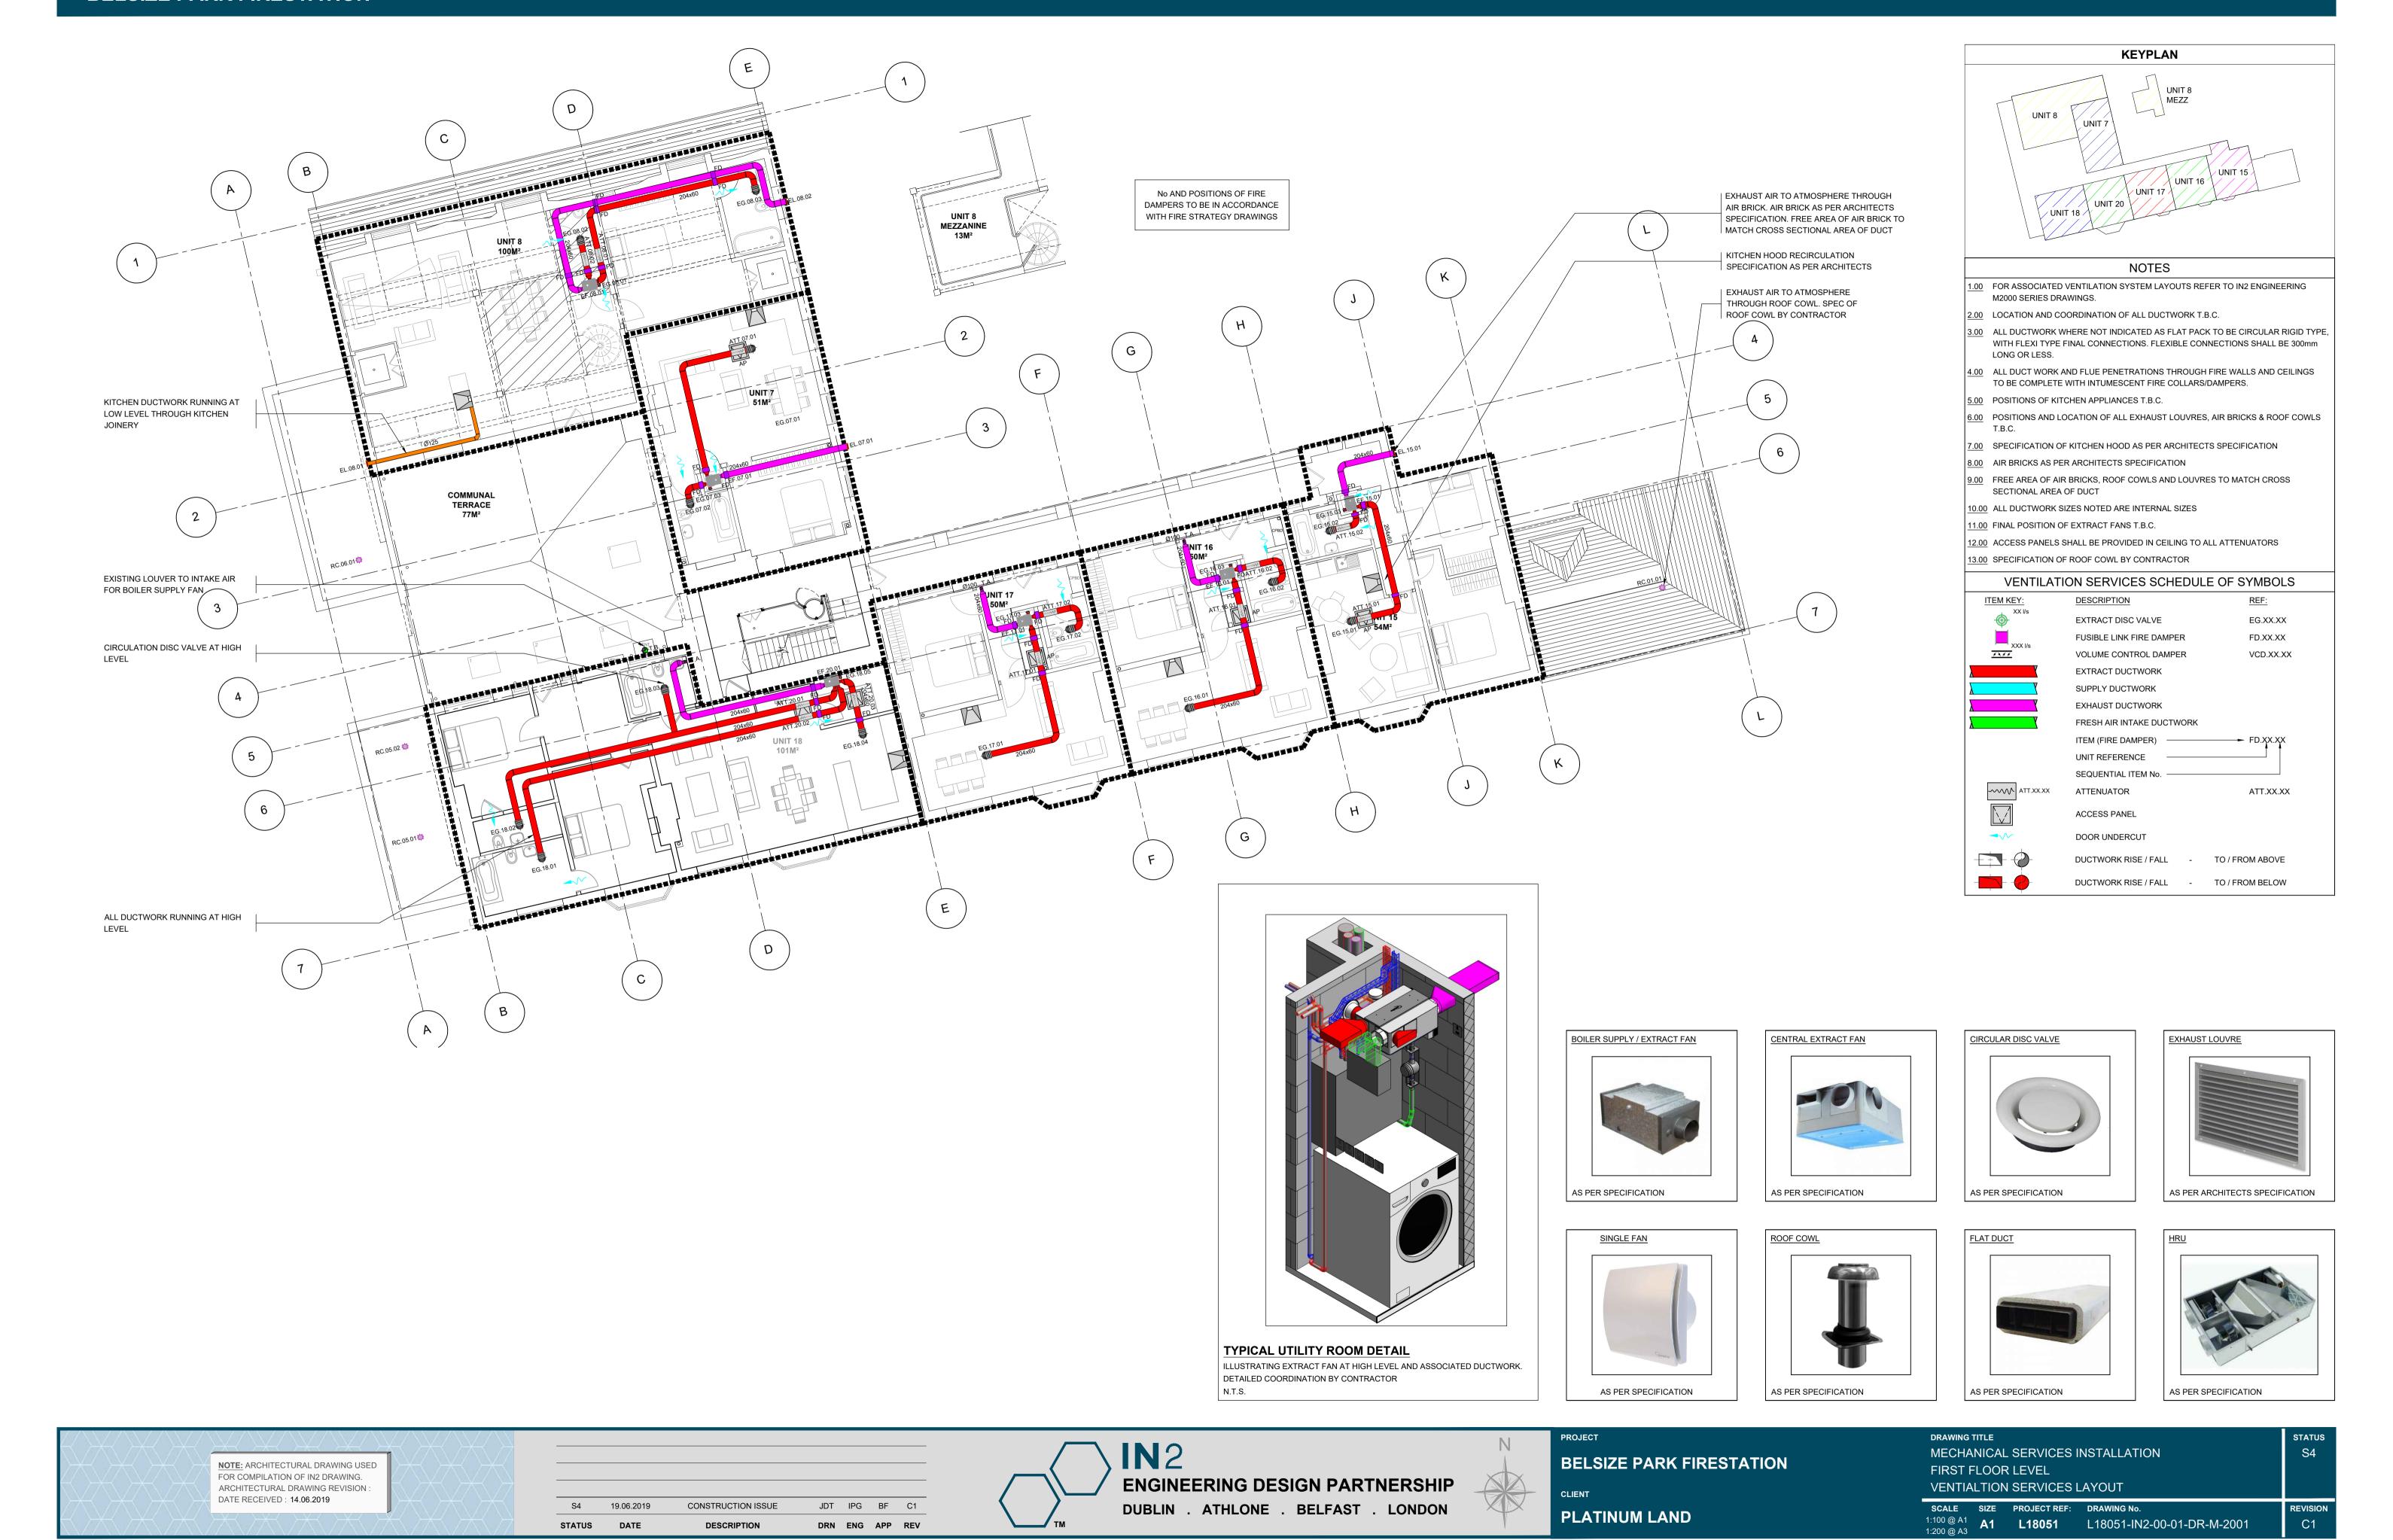

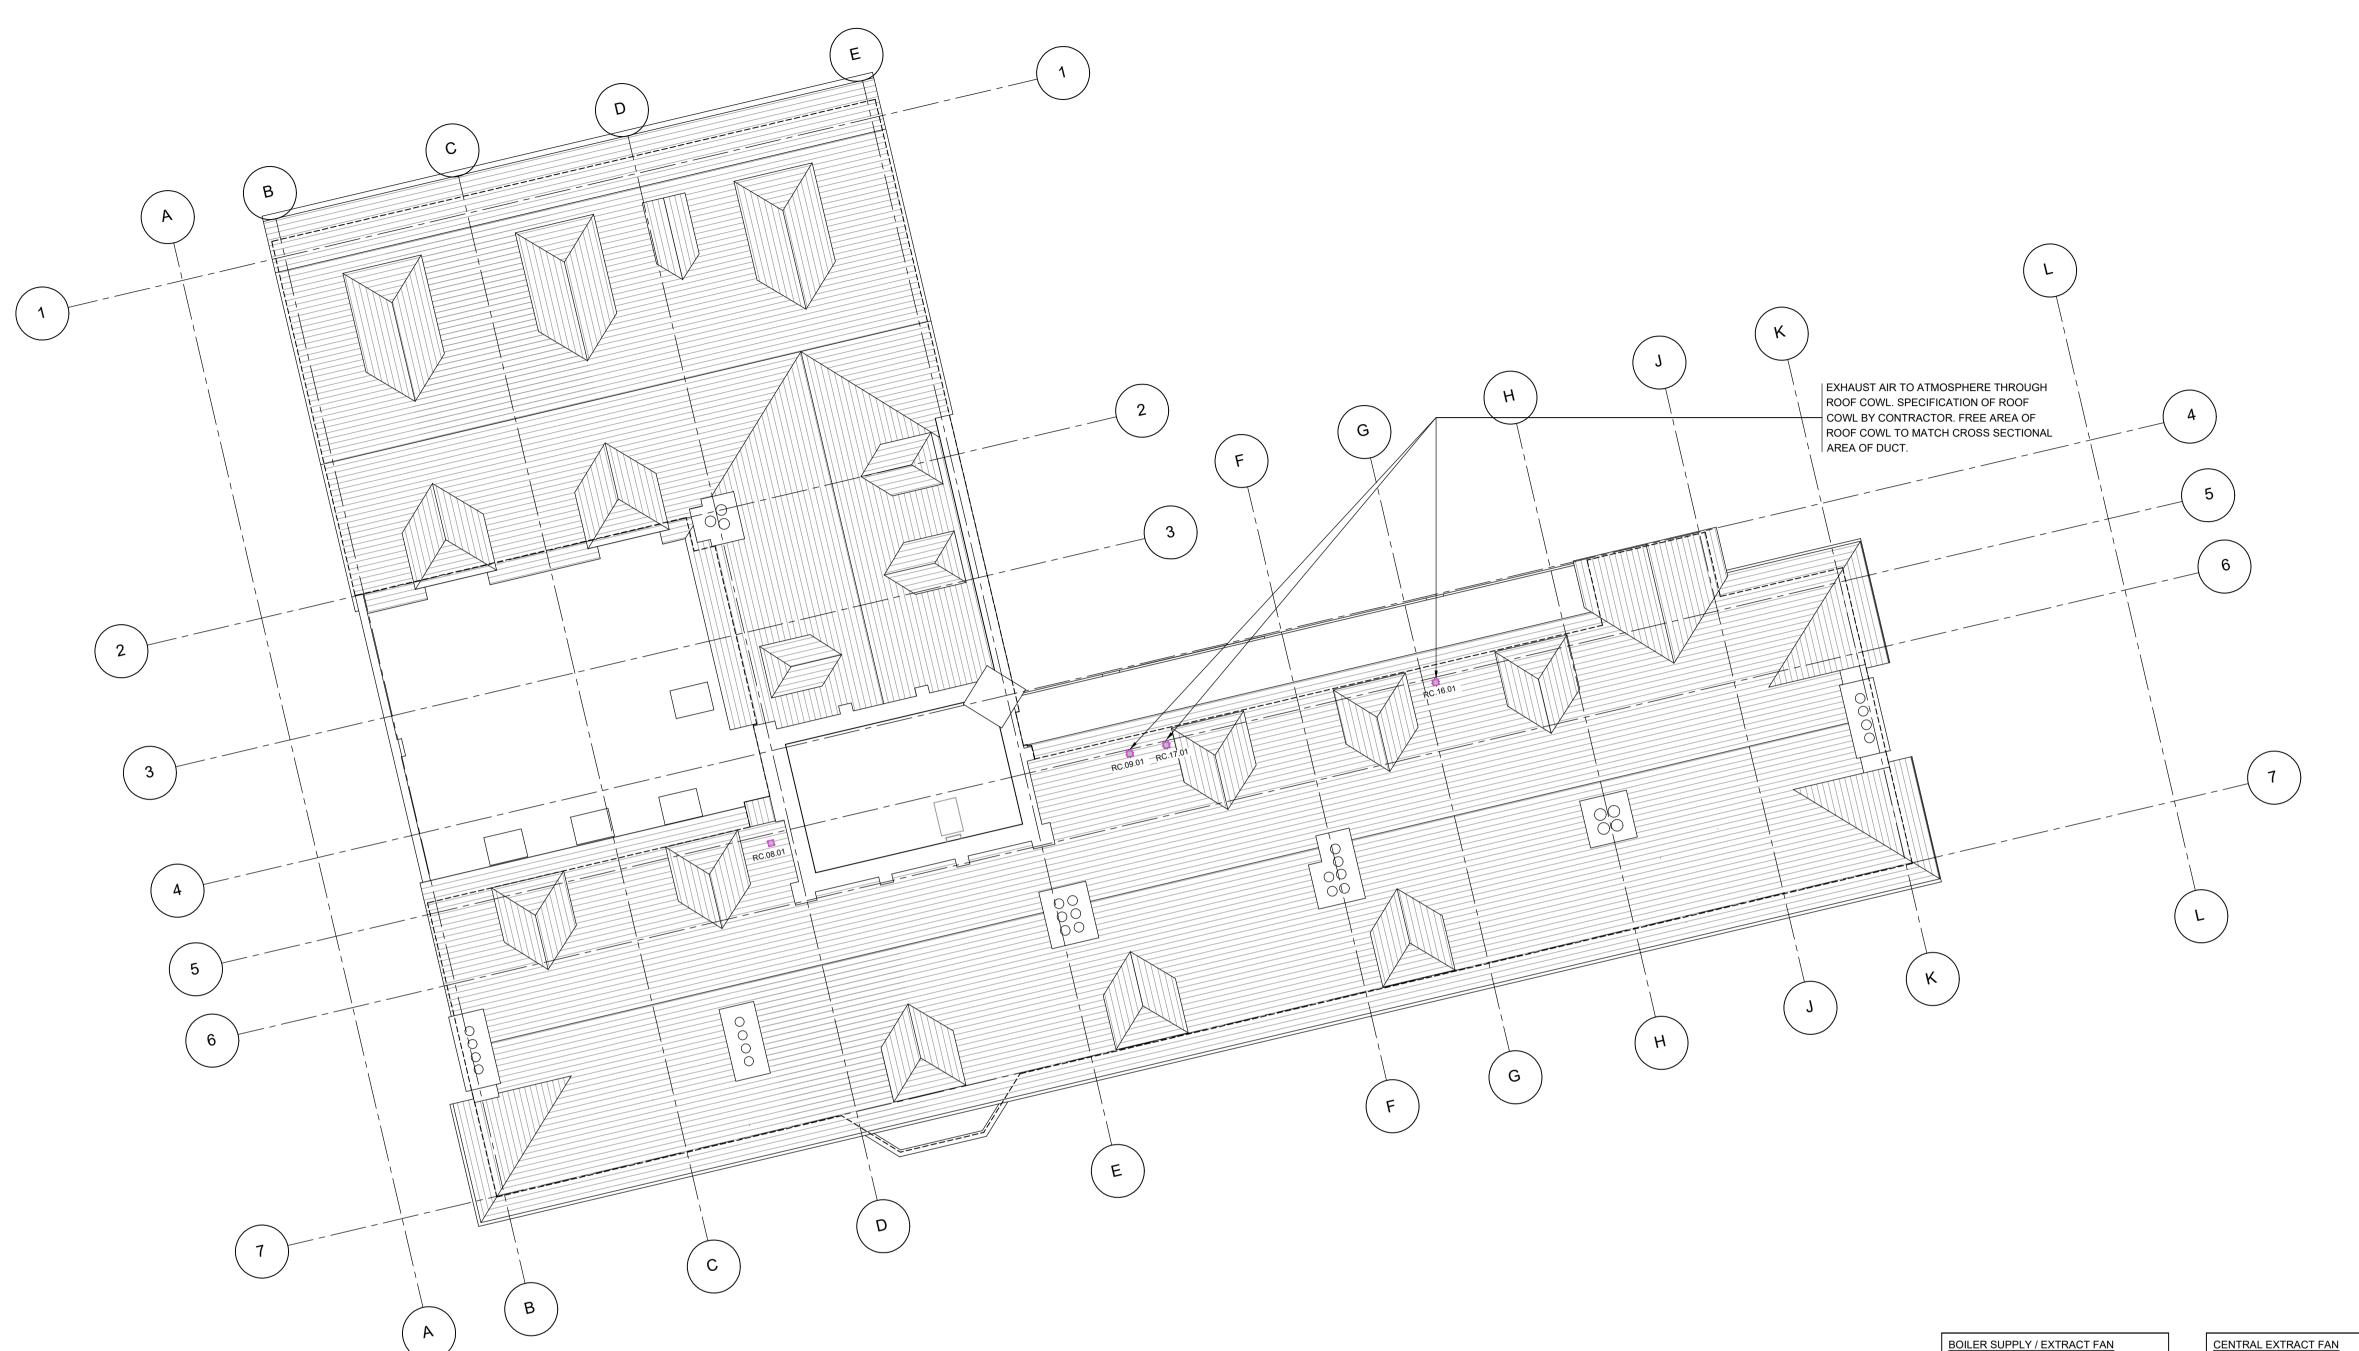


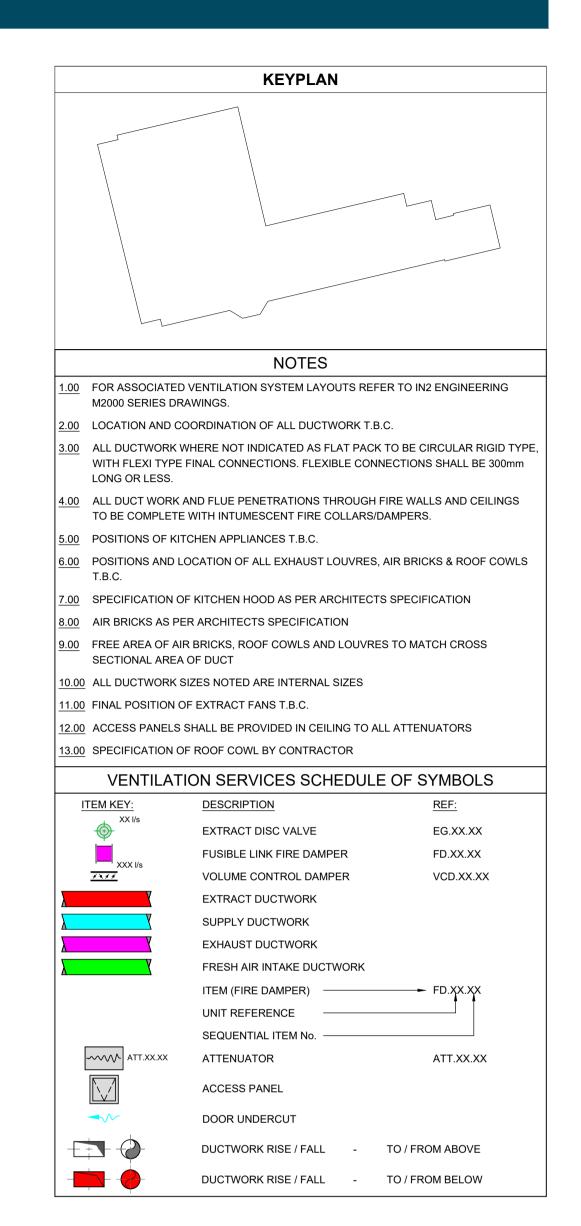

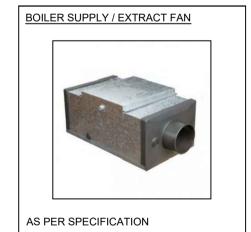






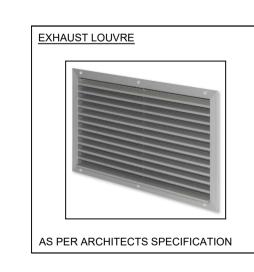








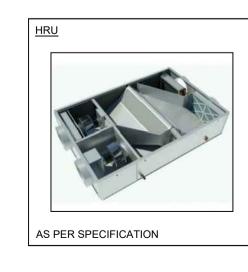

NOTE: ARCHITECTURAL DRAWING USED FOR COMPILATION OF IN2 DRAWING. ARCHITECTURAL DRAWING REVISION : DATE RECEIVED: 14.06.2019

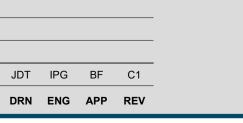

S4 19.06.2019

STATUS DATE

CONSTRUCTION ISSUE

DESCRIPTION


ENGINEERING DESIGN PARTNERSHIP DUBLIN . ATHLONE . BELFAST . LONDON

BELSIZE PARK FIRESTATION


PLATINUM LAND

DRAWING TITLE MECHANICAL SERVICES INSTALLATION ROOF LEVEL VENTILATION SERVICES LAYOUT

SCALE SIZE PROJECT REF: DRAWING No.

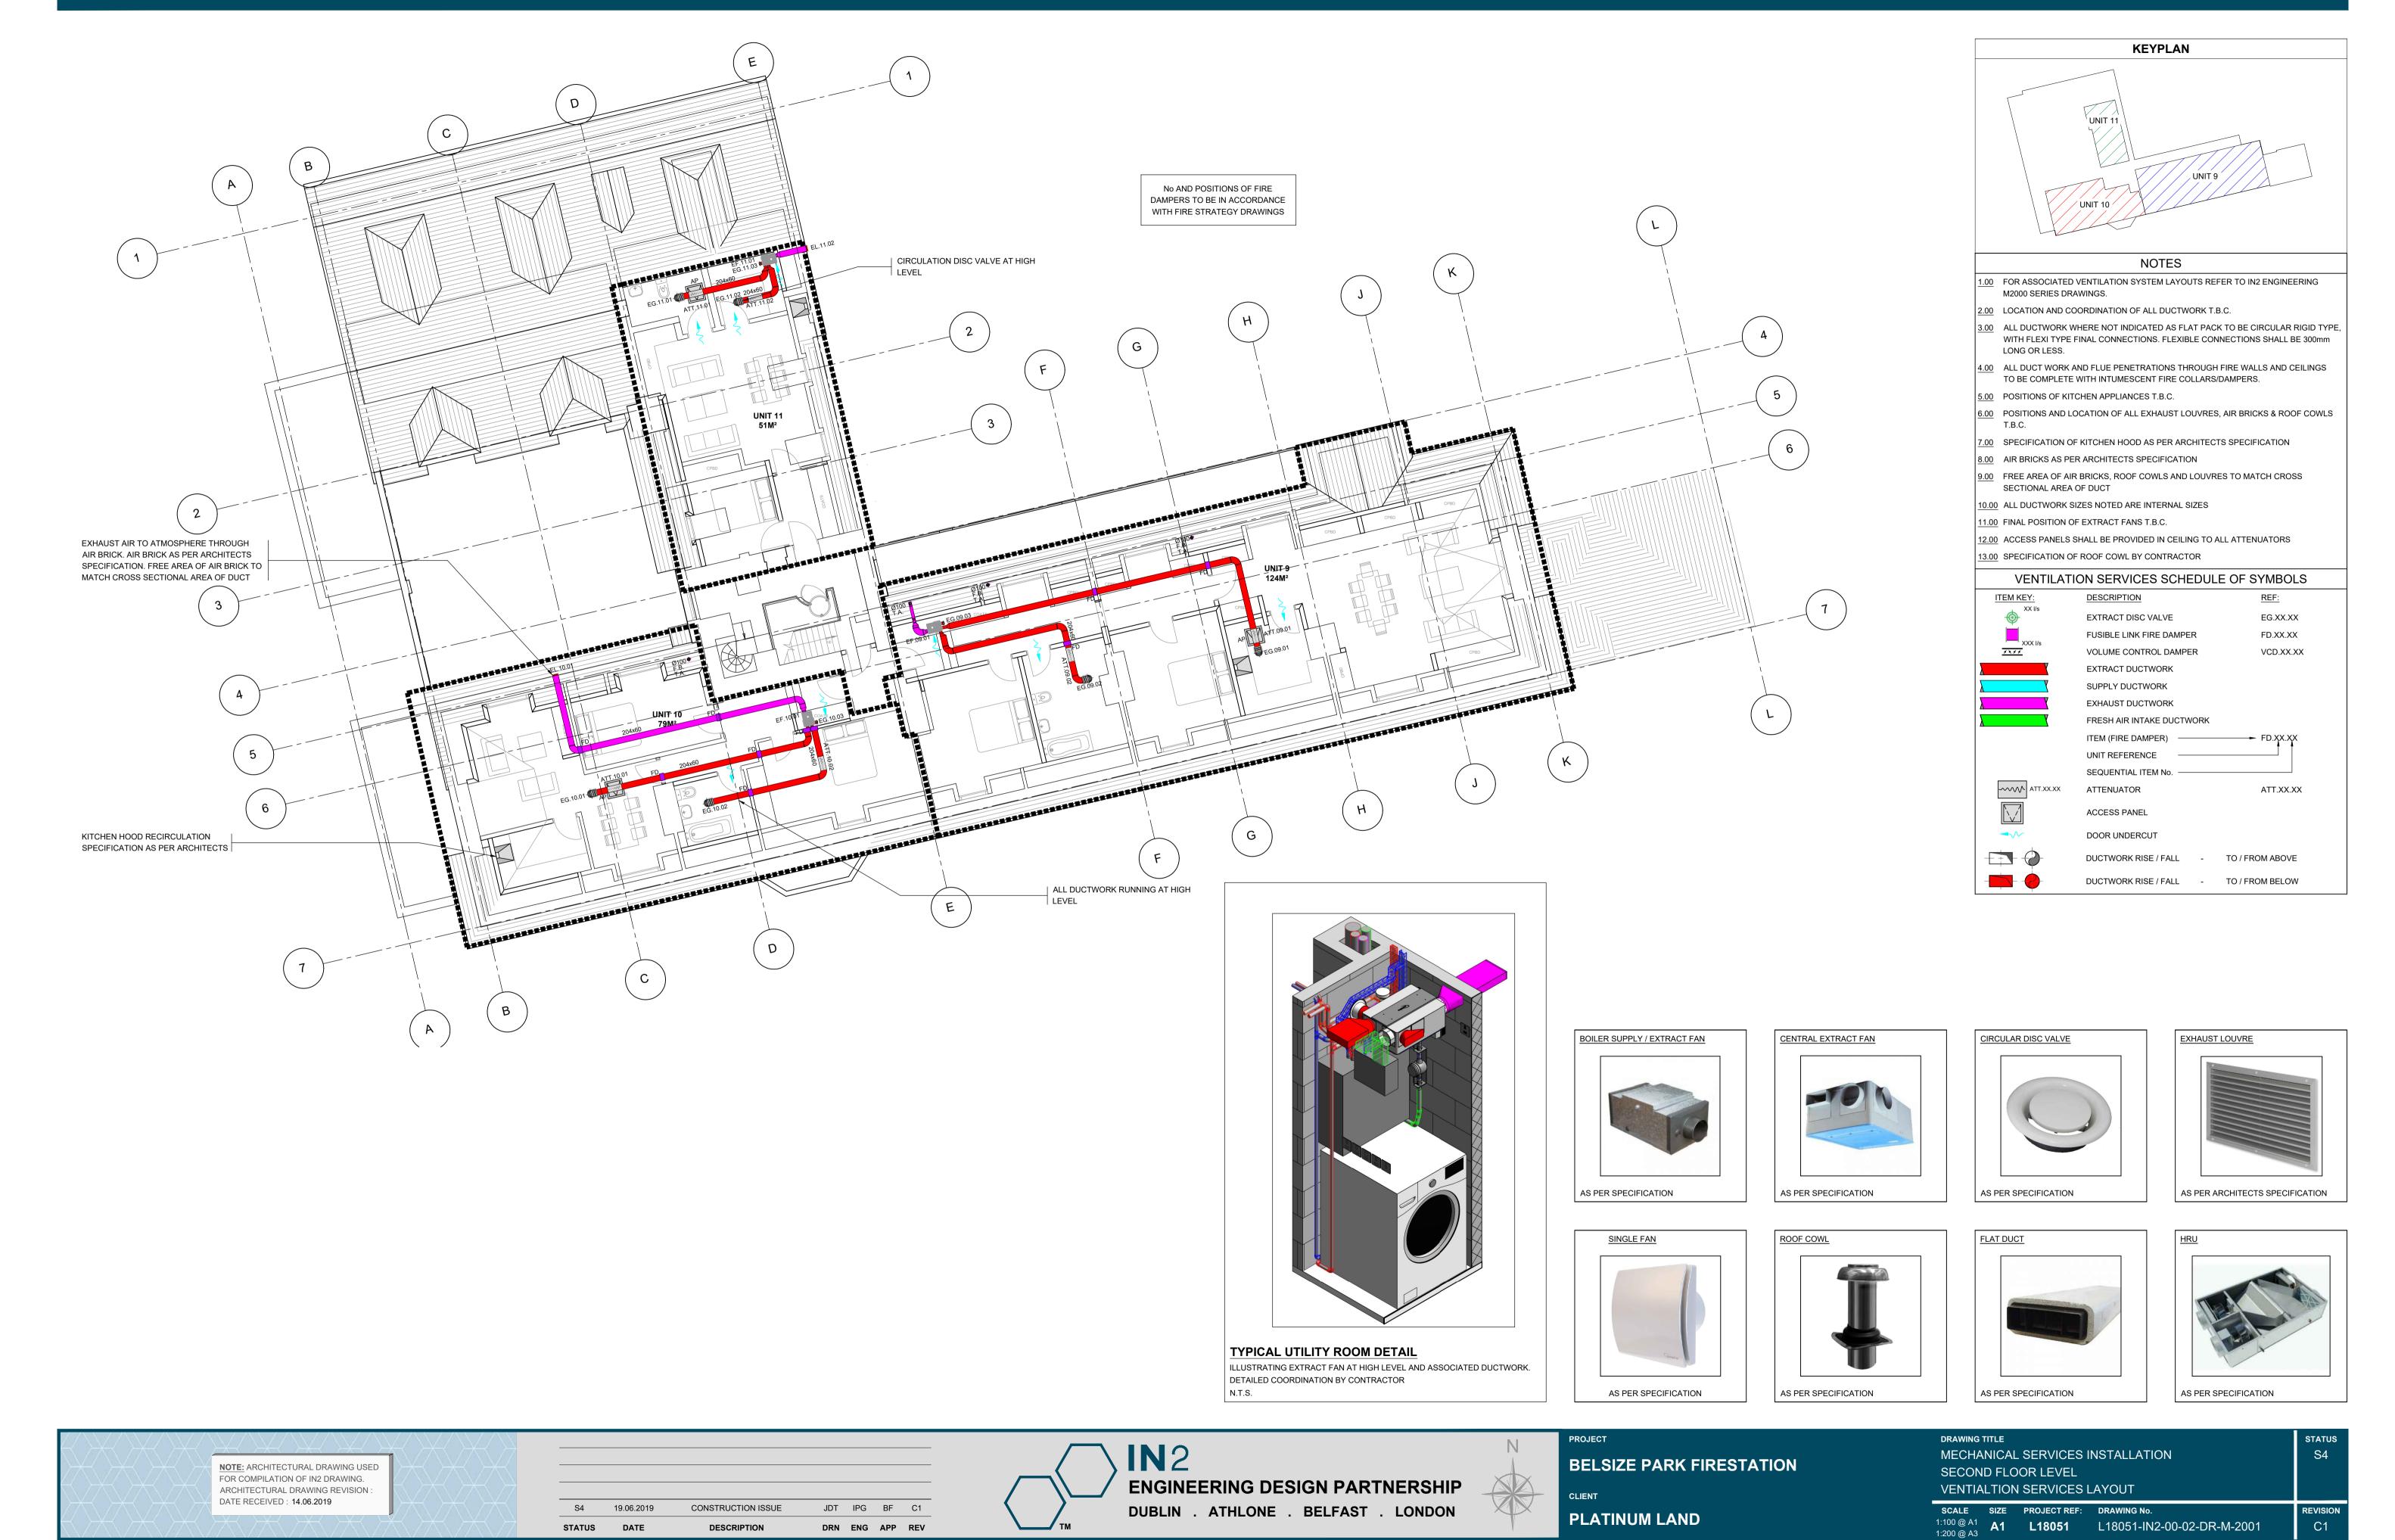




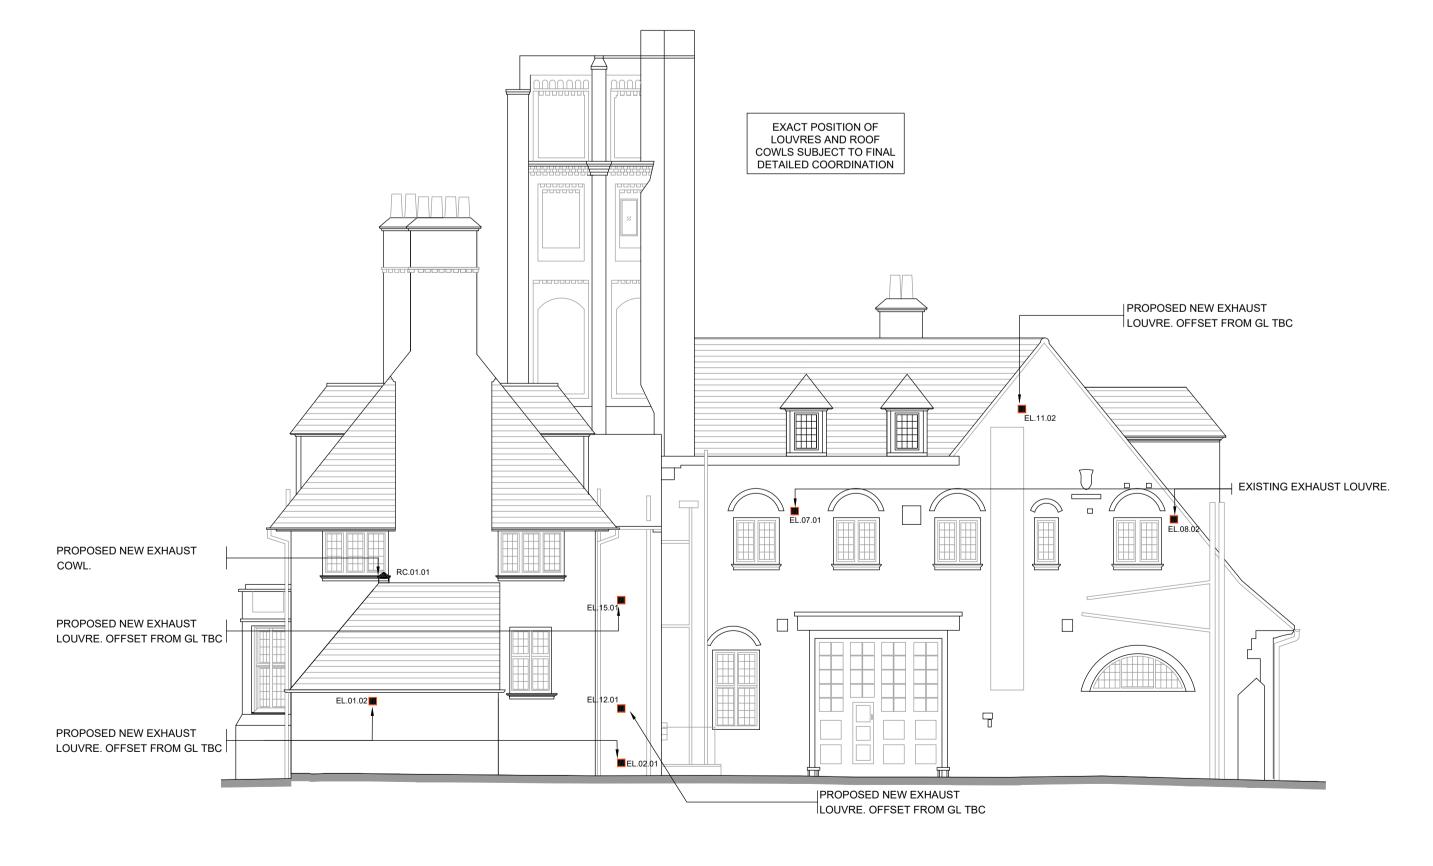







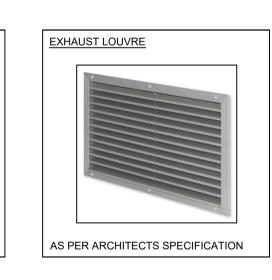

KEYPLAN

NOTES

3.00 ALL DUCTWORK WHERE NOT INDICATED AS FLAT PACK TO BE CIRCULAR RIGID TYPE, WITH FLEXI TYPE FINAL CONNECTIONS. FLEXIBLE CONNECTIONS SHALL BE 300mm

4.00 ALL DUCT WORK AND FLUE PENETRATIONS THROUGH FIRE WALLS AND CEILINGS

6.00 POSITIONS AND LOCATION OF ALL EXHAUST LOUVRES, AIR BRICKS & ROOF COWLS

TO BE COMPLETE WITH INTUMESCENT FIRE COLLARS/DAMPERS.

7.00 SPECIFICATION OF KITCHEN HOOD AS PER ARCHITECTS SPECIFICATION

9.00 FREE AREA OF AIR BRICKS, ROOF COWLS AND LOUVRES TO MATCH CROSS

12.00 ACCESS PANELS SHALL BE PROVIDED IN CEILING TO ALL ATTENUATORS

VENTILATION SERVICES SCHEDULE OF SYMBOLS

REF:

EG.XX.XX FD.XX.XX

VCD.XX.XX

ATT.XX.XX

TO / FROM ABOVE

1.00 FOR ASSOCIATED VENTILATION SYSTEM LAYOUTS REFER TO IN2 ENGINEERING

2.00 LOCATION AND COORDINATION OF ALL DUCTWORK T.B.C.

M2000 SERIES DRAWINGS.

5.00 POSITIONS OF KITCHEN APPLIANCES T.B.C.

8.00 AIR BRICKS AS PER ARCHITECTS SPECIFICATION

10.00 ALL DUCTWORK SIZES NOTED ARE INTERNAL SIZES

13.00 SPECIFICATION OF ROOF COWL BY CONTRACTOR

DESCRIPTION

EXTRACT DISC VALVE

EXTRACT DUCTWORK

SUPPLY DUCTWORK

EXHAUST DUCTWORK

ITEM (FIRE DAMPER)
UNIT REFERENCE
SEQUENTIAL ITEM No.

ATTENUATOR

ACCESS PANEL

DOOR UNDERCUT

FUSIBLE LINK FIRE DAMPER

VOLUME CONTROL DAMPER

FRESH AIR INTAKE DUCTWORK

DUCTWORK RISE / FALL -

DUCTWORK RISE / FALL - TO / FROM BELOW

11.00 FINAL POSITION OF EXTRACT FANS T.B.C.

SECTIONAL AREA OF DUCT

LONG OR LESS.

T.B.C.

ITEM KEY:


4 #

ATT.XX.XX







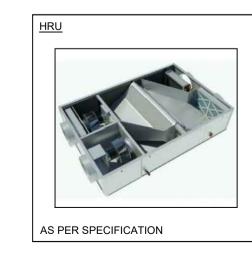

NOTE: ARCHITECTURAL DRAWING USED FOR COMPILATION OF IN2 DRAWING. ARCHITECTURAL DRAWING REVISION: DATE RECEIVED: 14.06.2019



22.07.2019

STATUS DATE

CONSTRUCTION ISSUE

DESCRIPTION

ENGINEERING DESIGN PARTNERSHIP
DUBLIN . ATHLONE . BELFAST . LONDON

BEL

BELSIZE PARK FIRESTATION

CLIENT

PLATINUM LAND


DRAWING TITLE
MECHANICAL SERVICES INSTALLATION
NORTH & EAST EXTERNAL ELEVATIONS
VENTILATION SERVICES LAYOUT

 SCALE
 SIZE
 PROJECT REF: DRAWING No.

 1:100 @ A1 1:200 @ A3
 A1
 L18051
 L18051-IN2-00-XX-DR-M-2702

EAST ELEVATION

SCALE: 1:100@A1

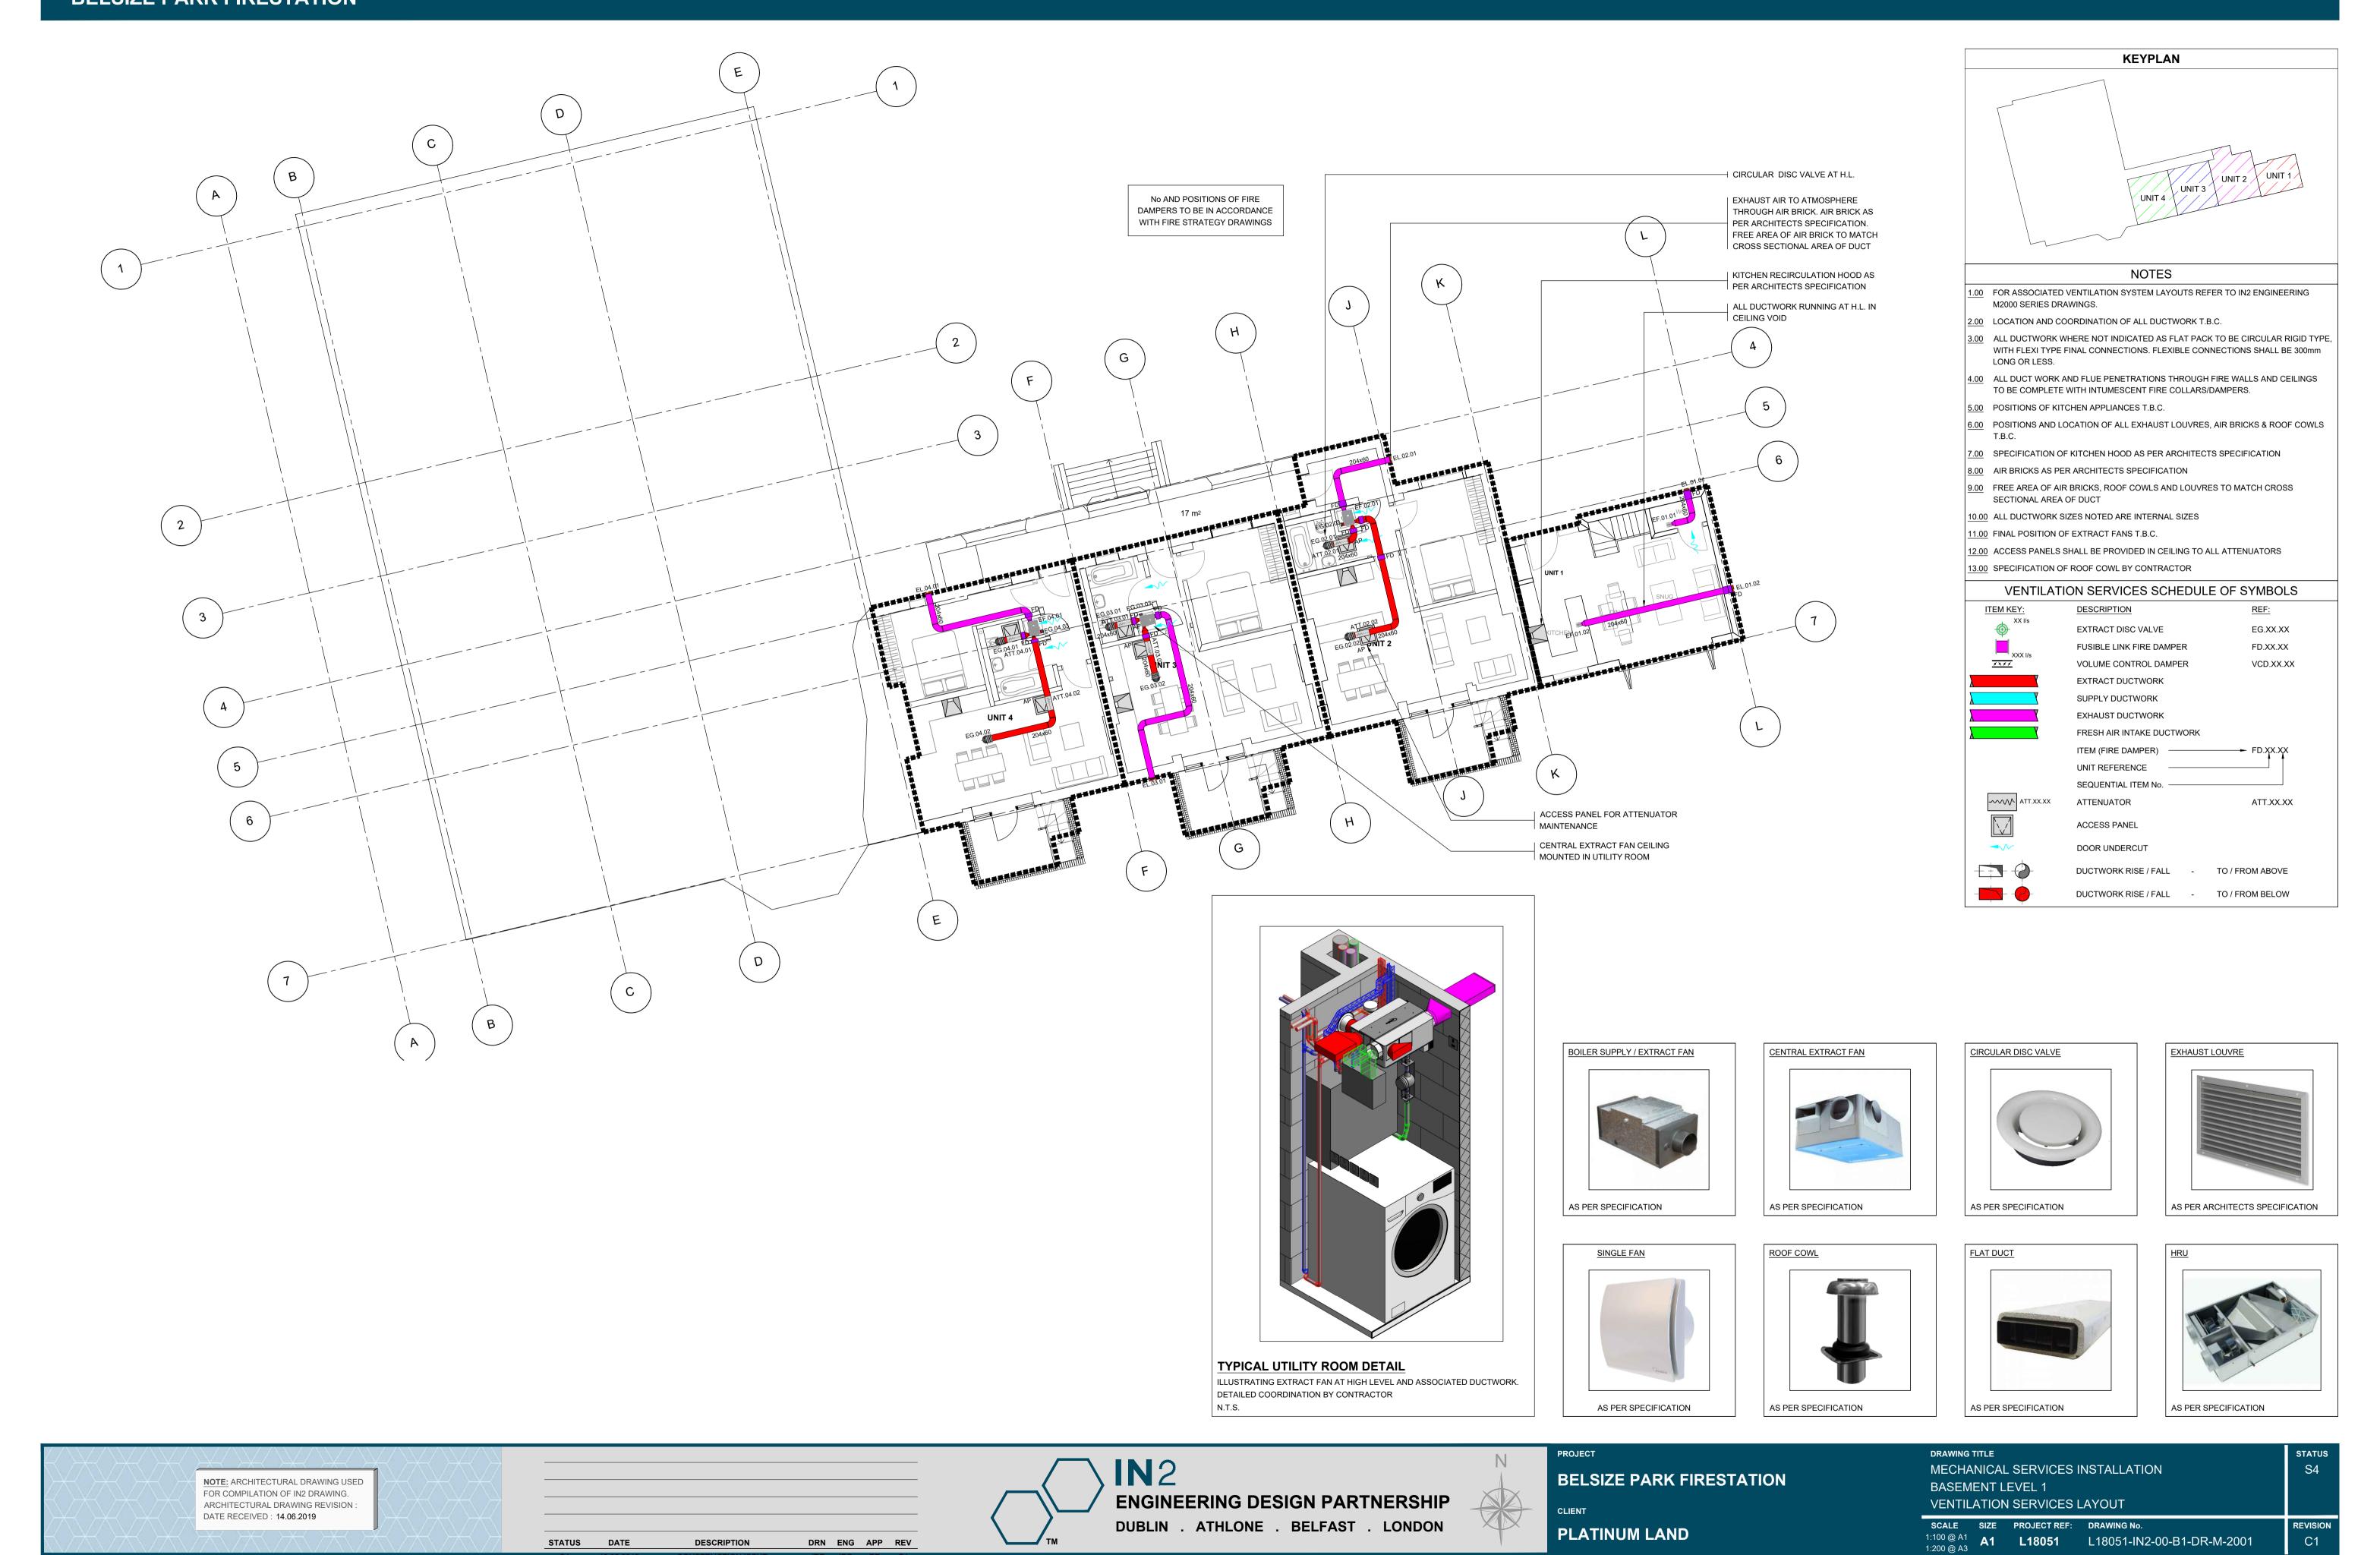

STATUS DATE

DESCRIPTION