

## Thurlow Road

# ROOF AMENDMENTS 30/05/2019

Flat 4, 20 Thurlow Rd, London NW3 5PP



### **COMMENTS FROM NORA**

30/05/2019

I think the option B would better preserve the integrity, character and appearance of the building; however, there are still some elements that need to be revised:

A)

As the ridge is increased and the overall roof volume, the dimensions of the dormers should remain the same as in option A. There would be sufficient internal height (up to 2.3m) to allow the dormers to be further set down from the ridge, and up from the eaves in order to be proportionate to the roof slope they sit within. Currently they look too stretched out and bulky. Please clarify what materials you are proposing for the dormers.

The proportions of the dormers have been changed as requested and were set down from the ridgeline by 350mm.

The materiality of the proposed dormers is as follows:

EXISTING DORMERS: PROPOSED DORMERS:

Dormer cheeks and front: Natural slate

Dormer cheeks and front: Natural slate

Dormer roof: Bitumen roof

Dormer roof: Zinc cladding

B)

In the drawings for option B, the increase in ridge height seemed to enlarge the other elements of the roof too – the chimney breasts are higher. These should remain the same as existing. In relation to this, please explain how you envisage the construction works would take place around the chimney breasts, in order to ensure they will be retained and protected.

The chimney breasts will remain as they are.

We propose a new construction for the whole roof, reusing the existing slates.

C)

Please provide detailed drawings of how the front bay roof would meet the new ridge. As I said before we need a bit more detailed drawings overall to ensure the proposal is actually feasible.

See Detail A - p7

D'

Please clarify what materials are on the existing roof and if you will reuse these. If you are planning to replace them, we would require a natural slate, Spanish or Welsh.

The existing roof is clad with Welsh slates.

Due to the increase of roof surface, additional Welsh slates matching seamlessly the existing slates will be required.





### **EXISTING ELEVATION**

PROPOSED ELEVATION
Ridge height increased by 400mm while eaves remain as they are.





### **EXISTING ELEVATION**

### PROPOSED ELEVATION


Ridge height increased by 400mm while eaves remain as they are.







PROPOSED ELEVATION
Ridge height increased by 400mm while eaves remain as they are.

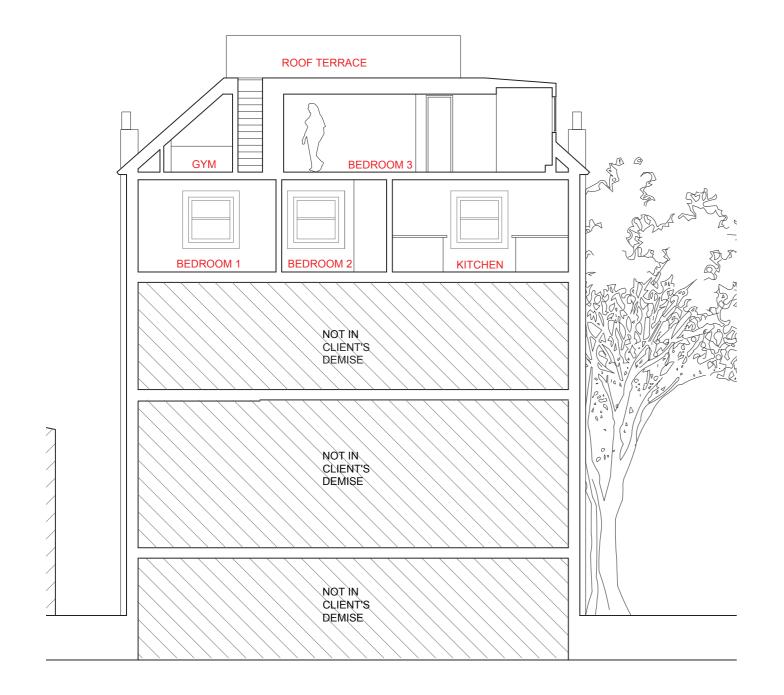




### **EXISTING SECTION**


### PROPOSED SECTION

Ridge height increased by 400mm while eaves remain as they are.

# ROOF DETAIL A - BAY WINDOW ON NORTH ELEVATION ROOF LIFTING

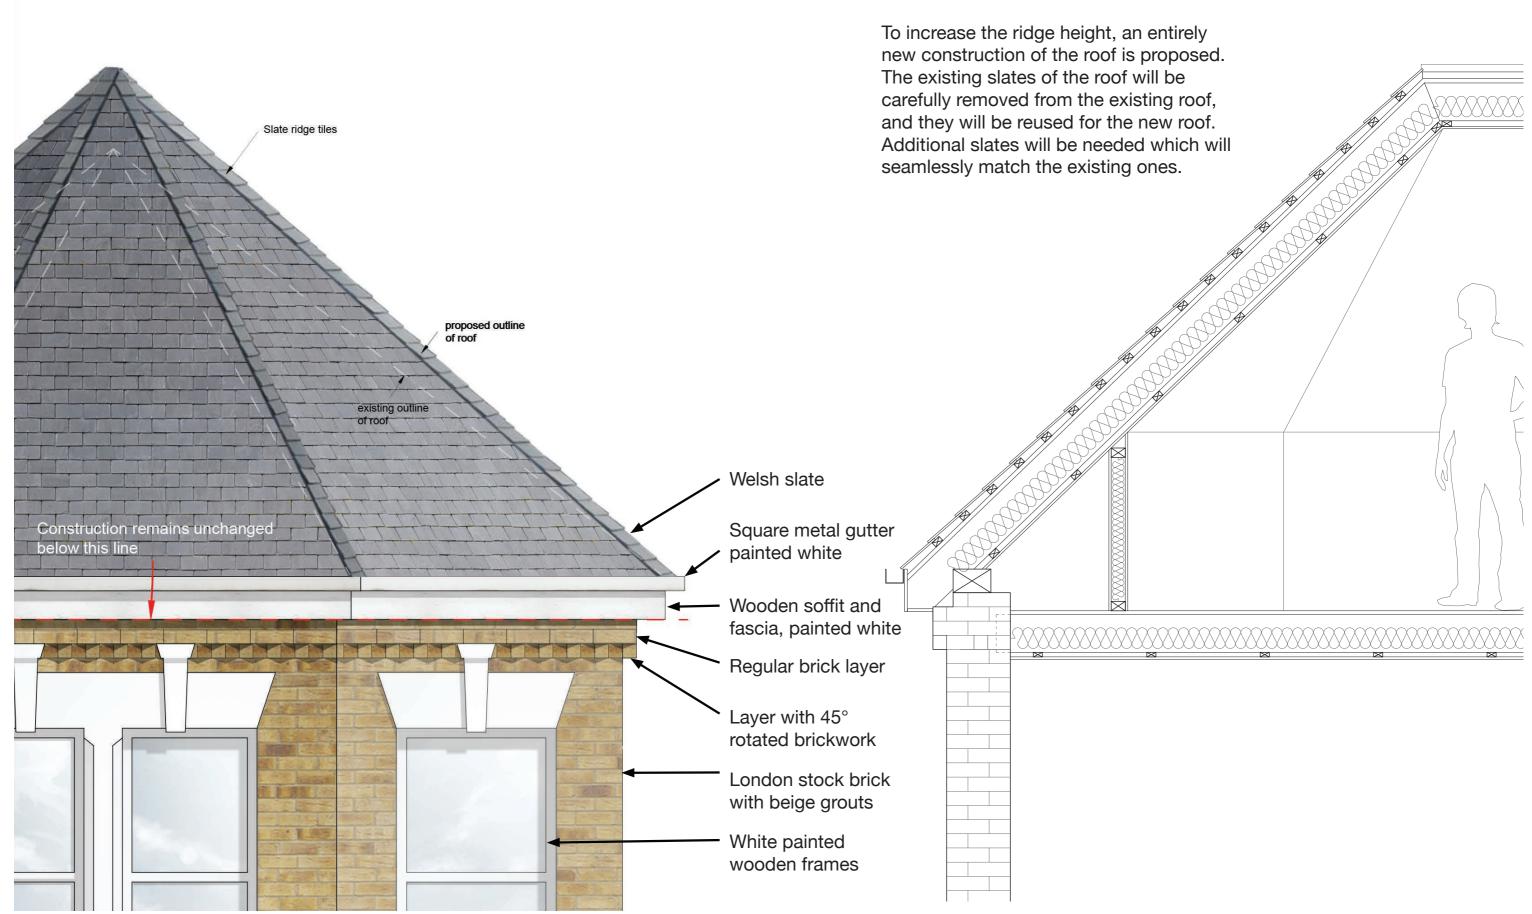

### PROPOSED THIRD FLOOR PLAN

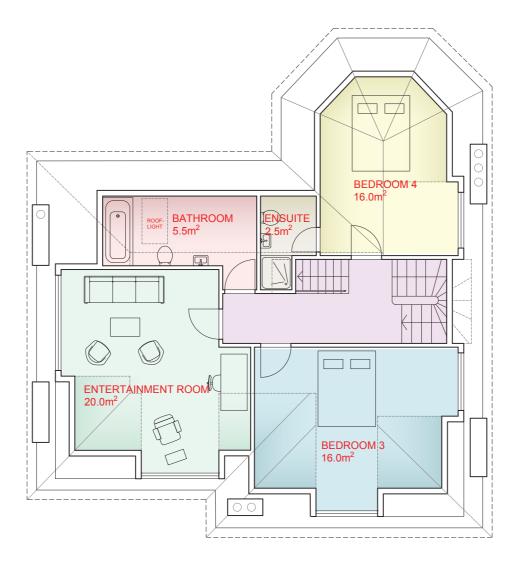

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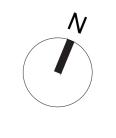
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PLANNING

**PROPOSED** 

Work Package	Cost Check	Info/Briefing	Tender	Contract	Construction	Date	Revision	Description Draw	n by Date	F	Ref.	Revision	Drawn by	Project	20 Thurlow Road	Project Code	Drawing Number	Rev	
-						15.12.2017	A	Proposed Third Floor Plan						Project	20 THUHOW ROAU	Project Code Drawing Number Rev.			
														Cubicat	Proposed Third Floor Plan			Н	
						28.01.2019		Amendments according to pre-app report from Nora-Andreea Constantinescu from 14/12/2018						Subject		1802	153		
						07.05.2019	Н	Amendments according to pre-app notes from Nora-Andreea Constantinescu, email form 01/05/2019							20 Thurlow Rd	1002	153		
														LONDON NW3 5PP, UK					
														Architecto	ZAP Architecture	Date 07.05.2019 Scale 1:100 at A3			
														Architects	365 High Street, London, E15 4QZ				
															T: 020 37614996 E: info@zaparchitecture.com				
														7			1		

