
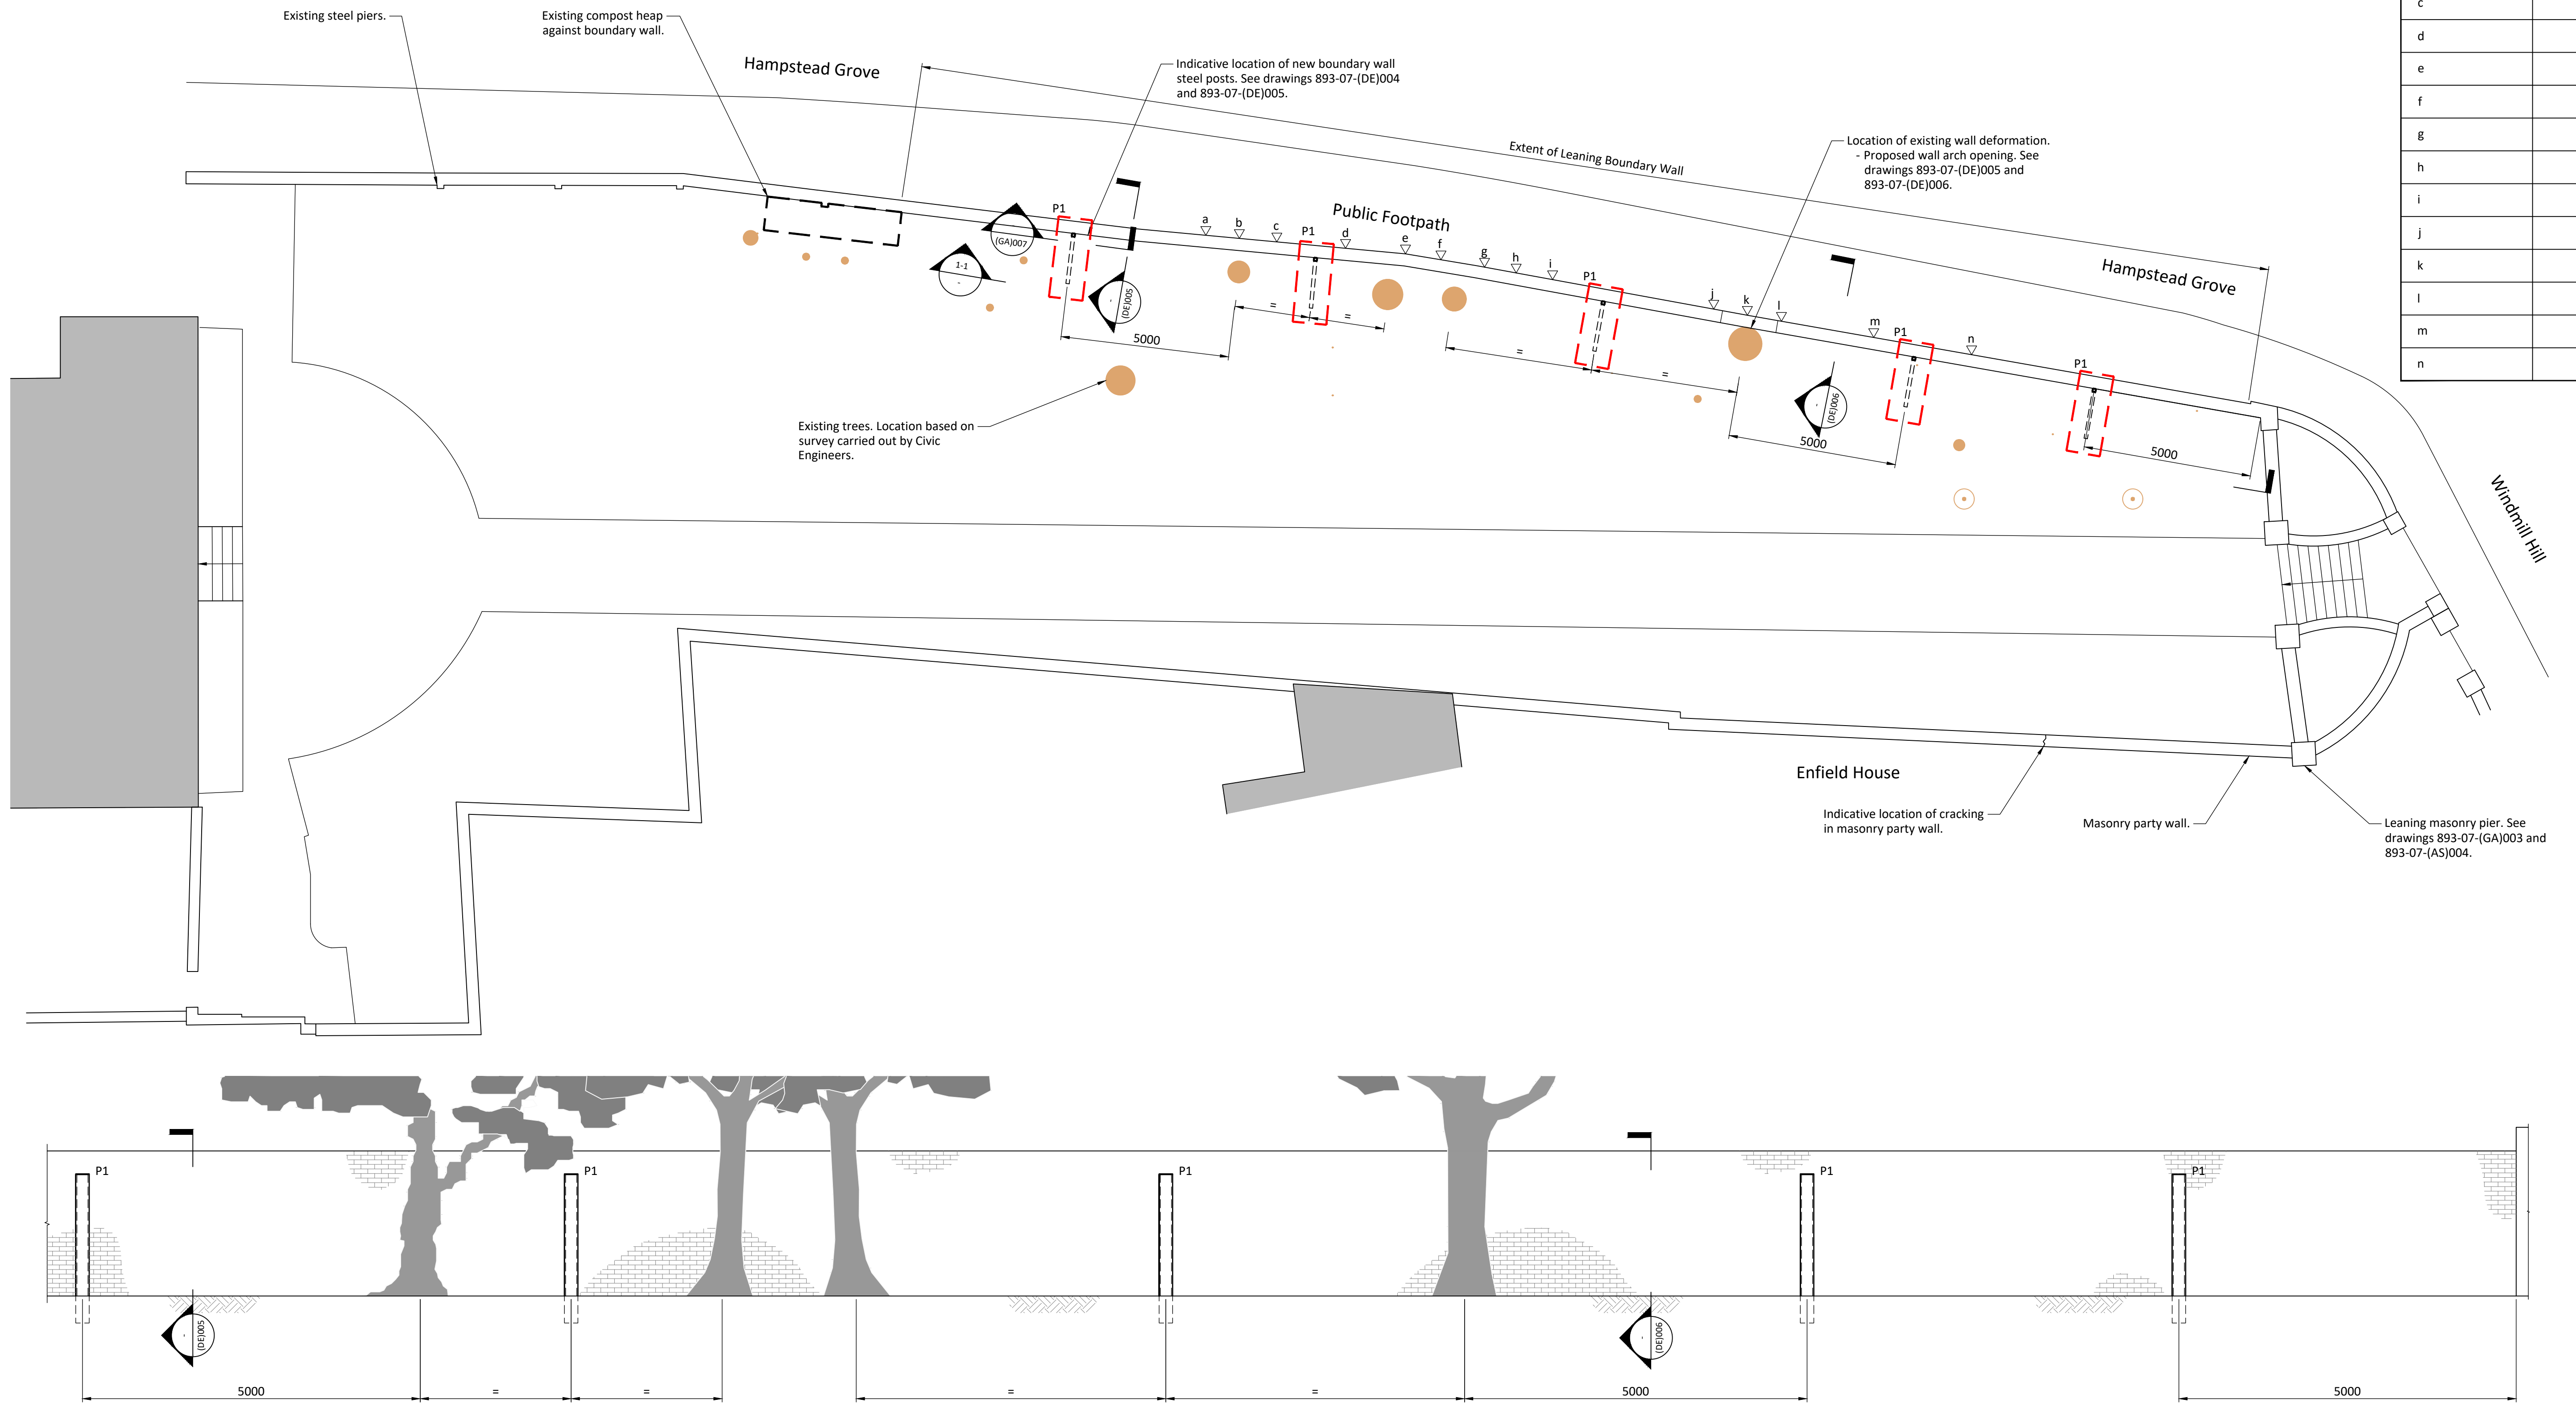



Existing Extent of Boundary Wall Lean	
Location Ref.	Lean (°)
a	4.1
b	4.2
c	2.4
d	2.8
e	2.9
f	4.2
g	5.5
h	5.9
i	5.9
j	3.5
k	4.4
l	4.4
m	2.4
n	2.5

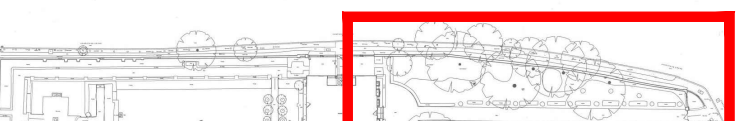

Section 1-1
Scale 1:50

<p>Location Plan</p> 	<p>Standard Notes</p> <ol style="list-style-type: none"> This drawing is to be read in conjunction with all relevant Architect's and Engineer's drawings and the specification. This drawing should not be scaled. All dimensions are to be verified by the contractor on site. All discrepancies should be reported to the C.A. prior to the commencement of the works. <p>© CIVIC ENGINEERS</p>	<p>Notes and Keys</p> <ol style="list-style-type: none"> This drawing is based on a garden survey by James Brennan Associates dated Jan. 2016, and a survey carried out by Civic Engineers on 29.11.18. For the proposed leaning boundary wall details, refer to drawing 893-07-(GA)004 and 893-07-(DE)005. For the proposed leaning pier details, refer to drawings 893-07-(GA)003 and 893-07-(AS)004. For the proposed wall arch opening details, refer to drawing 893-07-(GA)005 and 893-07-(DE)006. Setting out of new steel posts to be based on location of existing trees, and existing boundary wall. 	<p>Notes and Keys</p> <p>P1 - New Posts</p>	<p>Notes and Keys</p>	<div> <div></div> <div></div> <div></div> <div></div> <div></div> <div></div> </div>	<p>Project</p> <p>National Trust Fenton House Hampstead Grove</p>	 <p>MANCHESTER LONDON LEEDS GLASGOW</p> <p>Carver's Warehouse, 77 Dale Street, Manchester, M1 2HG. Tel: 0161 226 6701 Rivets Wharf, 33 Mill Street, London SE1 2AR. Tel: 020 7261 2997 Tower Works, Unit 10-11, Colne Road, Leeds, LS10 5SG. Tel: 0113 2025 130 Graham Chambers, 45 West Nile St, Glasgow, G1 2PT. Tel: 0141 370 1829</p> <p>www.civicingengineers.com</p>	<p>Title</p> <p>Site Plan</p>	<p>Status</p> <p>PRELIMINARY</p>	<table> <tr> <td>Scale @ A1</td> <td>Date Created</td> <td>Drawn</td> <td>Checked</td> <td>Project Number</td> <td>Originator</td> <td>Discipline</td> <td>Drawing Number</td> <td>Revision</td> </tr> <tr> <td>1:100</td> <td>Jan. '19</td> <td>AB</td> <td>DP</td> <td>893-07</td> <td>CIVIC</td> <td>S</td> <td>(GA)006</td> <td>P01</td> </tr> </table>	Scale @ A1	Date Created	Drawn	Checked	Project Number	Originator	Discipline	Drawing Number	Revision	1:100	Jan. '19	AB	DP	893-07	CIVIC	S	(GA)006	P01
	Scale @ A1	Date Created	Drawn	Checked	Project Number	Originator	Discipline	Drawing Number	Revision																			
	1:100	Jan. '19	AB	DP	893-07	CIVIC	S	(GA)006	P01																			
	<table> <tr> <td>04.04.19</td> <td>P02</td> <td>New posts highlighted, Section 1-1 added</td> <td>AB</td> <td>DP</td> </tr> <tr> <td>15.03.19</td> <td>P01</td> <td>Issued for Leaning Pier and Boundary Wall</td> <td>AB</td> <td>DP</td> </tr> <tr> <td>Date</td> <td>Rev</td> <td>Description</td> <td>Drawn</td> <td>Chk</td> </tr> </table>	04.04.19	P02	New posts highlighted, Section 1-1 added	AB	DP	15.03.19	P01	Issued for Leaning Pier and Boundary Wall	AB	DP	Date	Rev	Description	Drawn	Chk												
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