
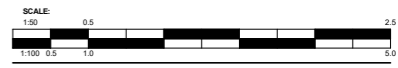




© COPYRIGHT  
The copyright in this drawing is vested in oculus architects and no licence or assignment of any kind has been or is granted to any third party whether by provision of copies or originals of the drawings or otherwise unless otherwise agreed in writing.

FOR ELECTRONIC DATA ISSUE  
Electronic data / drawings are issued as "read only" and should not be interrogated for measurement. All dimensions and levels should be read, only from those values stated in text, on the drawing.


AREA MEASUREMENT  
The areas are approximate and can only be verified by a detailed dimensional survey of the completed building. Any decisions to be made on the basis of these predictions, whether as to project viability, one-letting, lease agreements or the like, should include due allowance for the increases and decreases inherent in the design development and building processes. Figures relate to the floor areas of the building at the current state of the design and using the Gross External Area (GEA) / Gross Internal Area (GIA) / Net Internal Area (NIA) method of measurement from the Code of Measuring Practice, 6th Edition (RICS Code of Practice). All areas are subject to Town Planning and Conservation Area Consent, and detailed Rights to Light analysis.

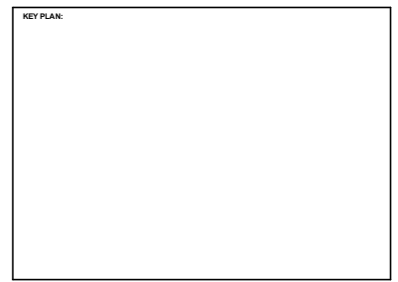

NOTES:

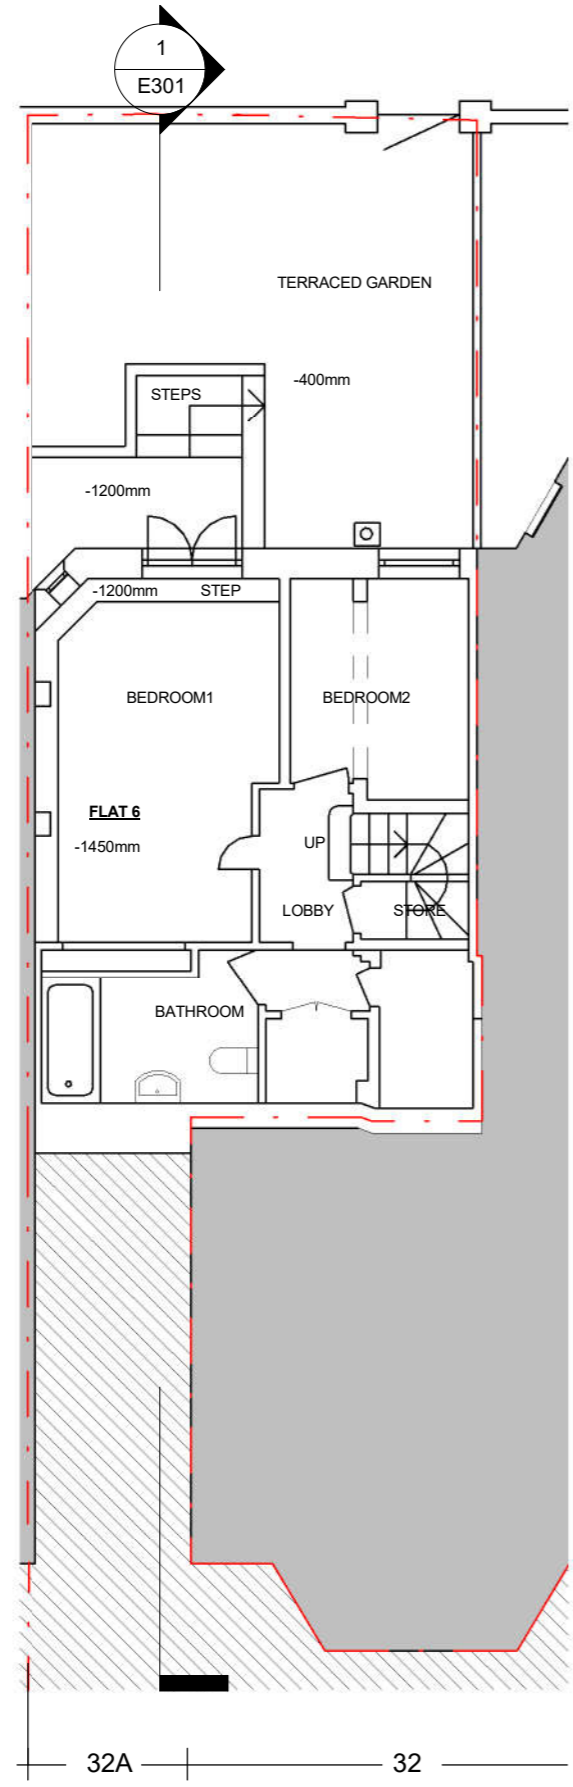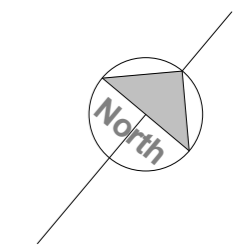

**1** EXISTING LG FLOOR PLAN  
1 : 100

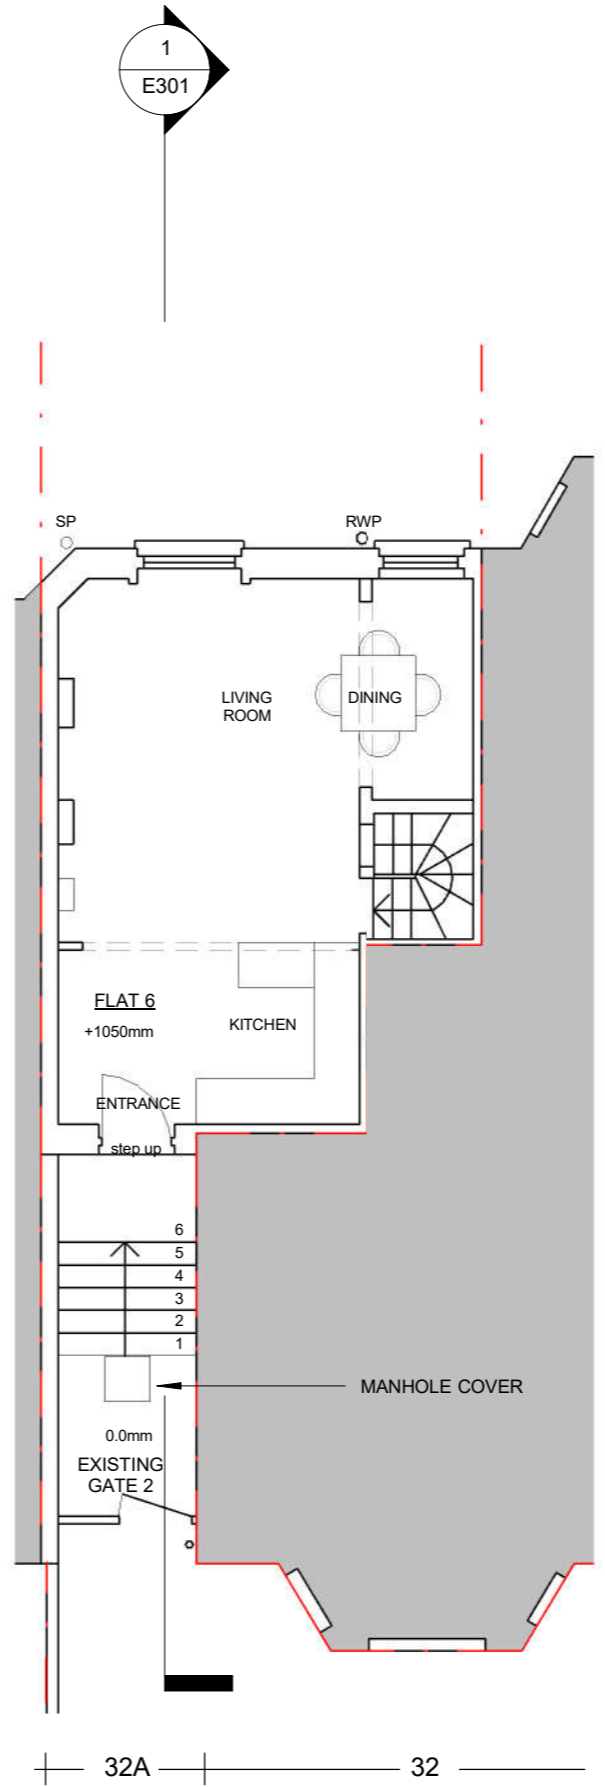

**2** EXISTING GROUND FLOOR PLAN  
1 : 100

REV	DATE	AMENDMENT

TITLE  
**FLAT 6, 32A COMPAYNE GARDENS  
NW6 3DN LONDON**

**oculus architects Ltd**  
16A Pratt Street London NW1 0AB  
Tel: 02035839227 www.oarch.co.uk

DRAWING TITLE  
**EXISTING PLANS**

SCALE 1 : 100@ A3	DRAWN BY
DATE 2019.02.13	CHECKED BY
JOB No. 1098	DWG No. E102
STAGE PRE-PLANNING	REV.