

1. Kingspan Thermabate PLUS cavity closers installed around all window and external door openings.

2. Install new double glazed aluminium windows and doors by specialists with new lintels over to structural engineers details and specification. Windows to achieve Double glazed, 16mm+ btwn panes, Low E glass (Soft coating, 0.05), , Argon Fill. Window to achieve max. 'U' value of 1.4W/m2K. Half Glazed doors to be Double glazed, 16mm+ btwn panes, Low E glass (Soft coating, 0.05), , Argon Fill. Doors that are half glazed t to a chieve max. 'U' value of 1.4W/m2K

Rooflight on rain sensor with 3. mechanical over ride within electrical plan with over ride switch.

4. Specialist staircase as per specialists drawings and details.

5. 254x254 UC to have timber blocking bolted through the web as per engineers specifications and details.


6. Circular rooflight by specialist.

7. 203x203 UC 60 as per engineers specifications drawings and calculations


DG002	
DG003	
DG004	
Element ID	
Element ID DF001	

Element ID

DG001

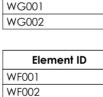


Element ID

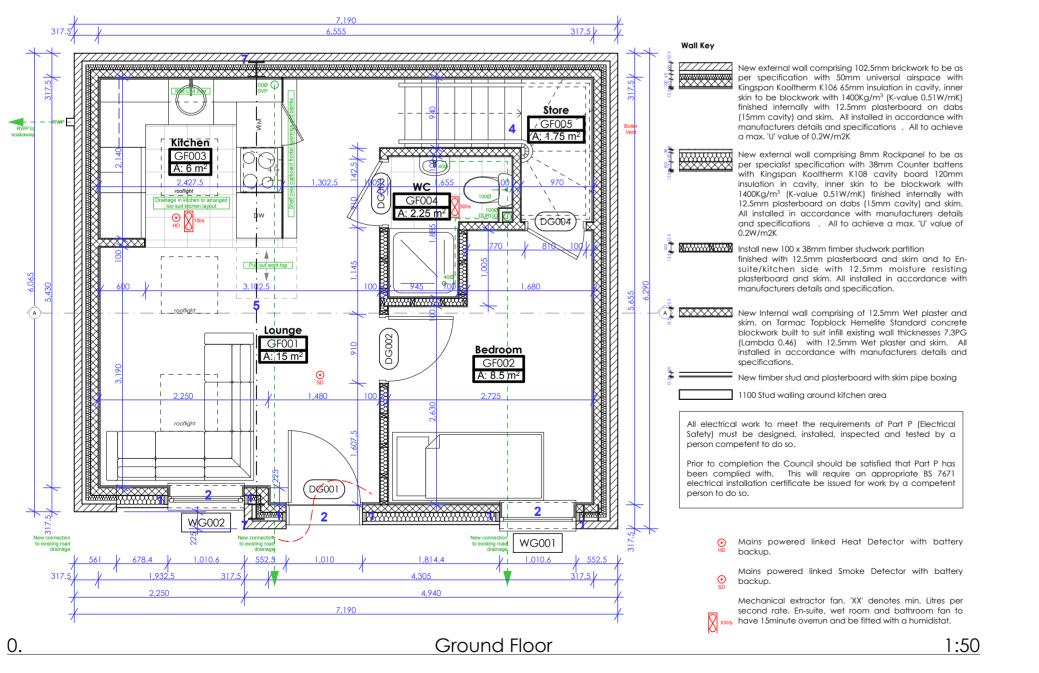

(A)-

Ground Floor Doors						
	To Room Number	To Room Name	Structural Opening	Notes		
	GF001	Lounge	1,010×2,450	Front door		
	GF002	Bedroom	910×2,025			
	GF004	WC	910×2,025			
	GF005	Store	810×2,025			
First Floor Doors						
	To Room Number	To Room Name	Structural Opening	Notes		
	FF002	Bedroom	910×2,025			
	FF003	Bathroom	810×2,025			
Ground Floor Windows						
	To Room Number	To Room Name	Structural Opening	Notes		
	GF002	Bedroom	1,010.6×2,450			
	GF001	Lounge	1,010.6×1,400			
First Floor Windows						
	To Room Number	To Room Name	Structural Opening	Notes		
	FF002	Bedroom	2,824.4×1,094.8			
	FF002	Bedroom	1,010.6×1,850			

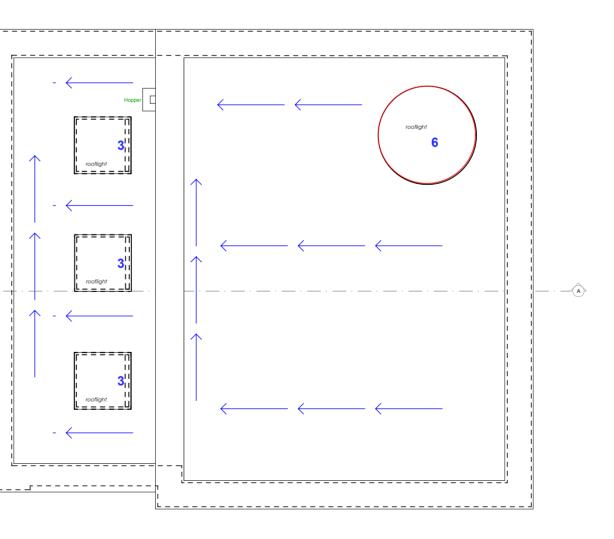

roof plan

STEENE ASSOCIATES [ARCHITECTS] LTD

THE STUDIO * 17 OAKRIDGE AVENUE RADLETT * HERTFORDSHIRE * WD7 8EW TEL: 0844 936 0220 * FAX: 01923 663608

Email info@steeneassociates.co.uk

CLIENT Mr + Mrs Feldman

PROJECT

Proposed Annex 144 Mill Lane, London. NW6 1TF

DRAWING Proposed

SCALE 1:25

1:50

DRAWN

DWG NO. CAD REF NO AJK

REVISION

DB350-W001

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DATE

June 2018



REVISION