


VIEW D-D PROPOSED FRONT ELEVATION  
1:50



VIEW E-E PROPOSED REAR ELEVATION  
1:50

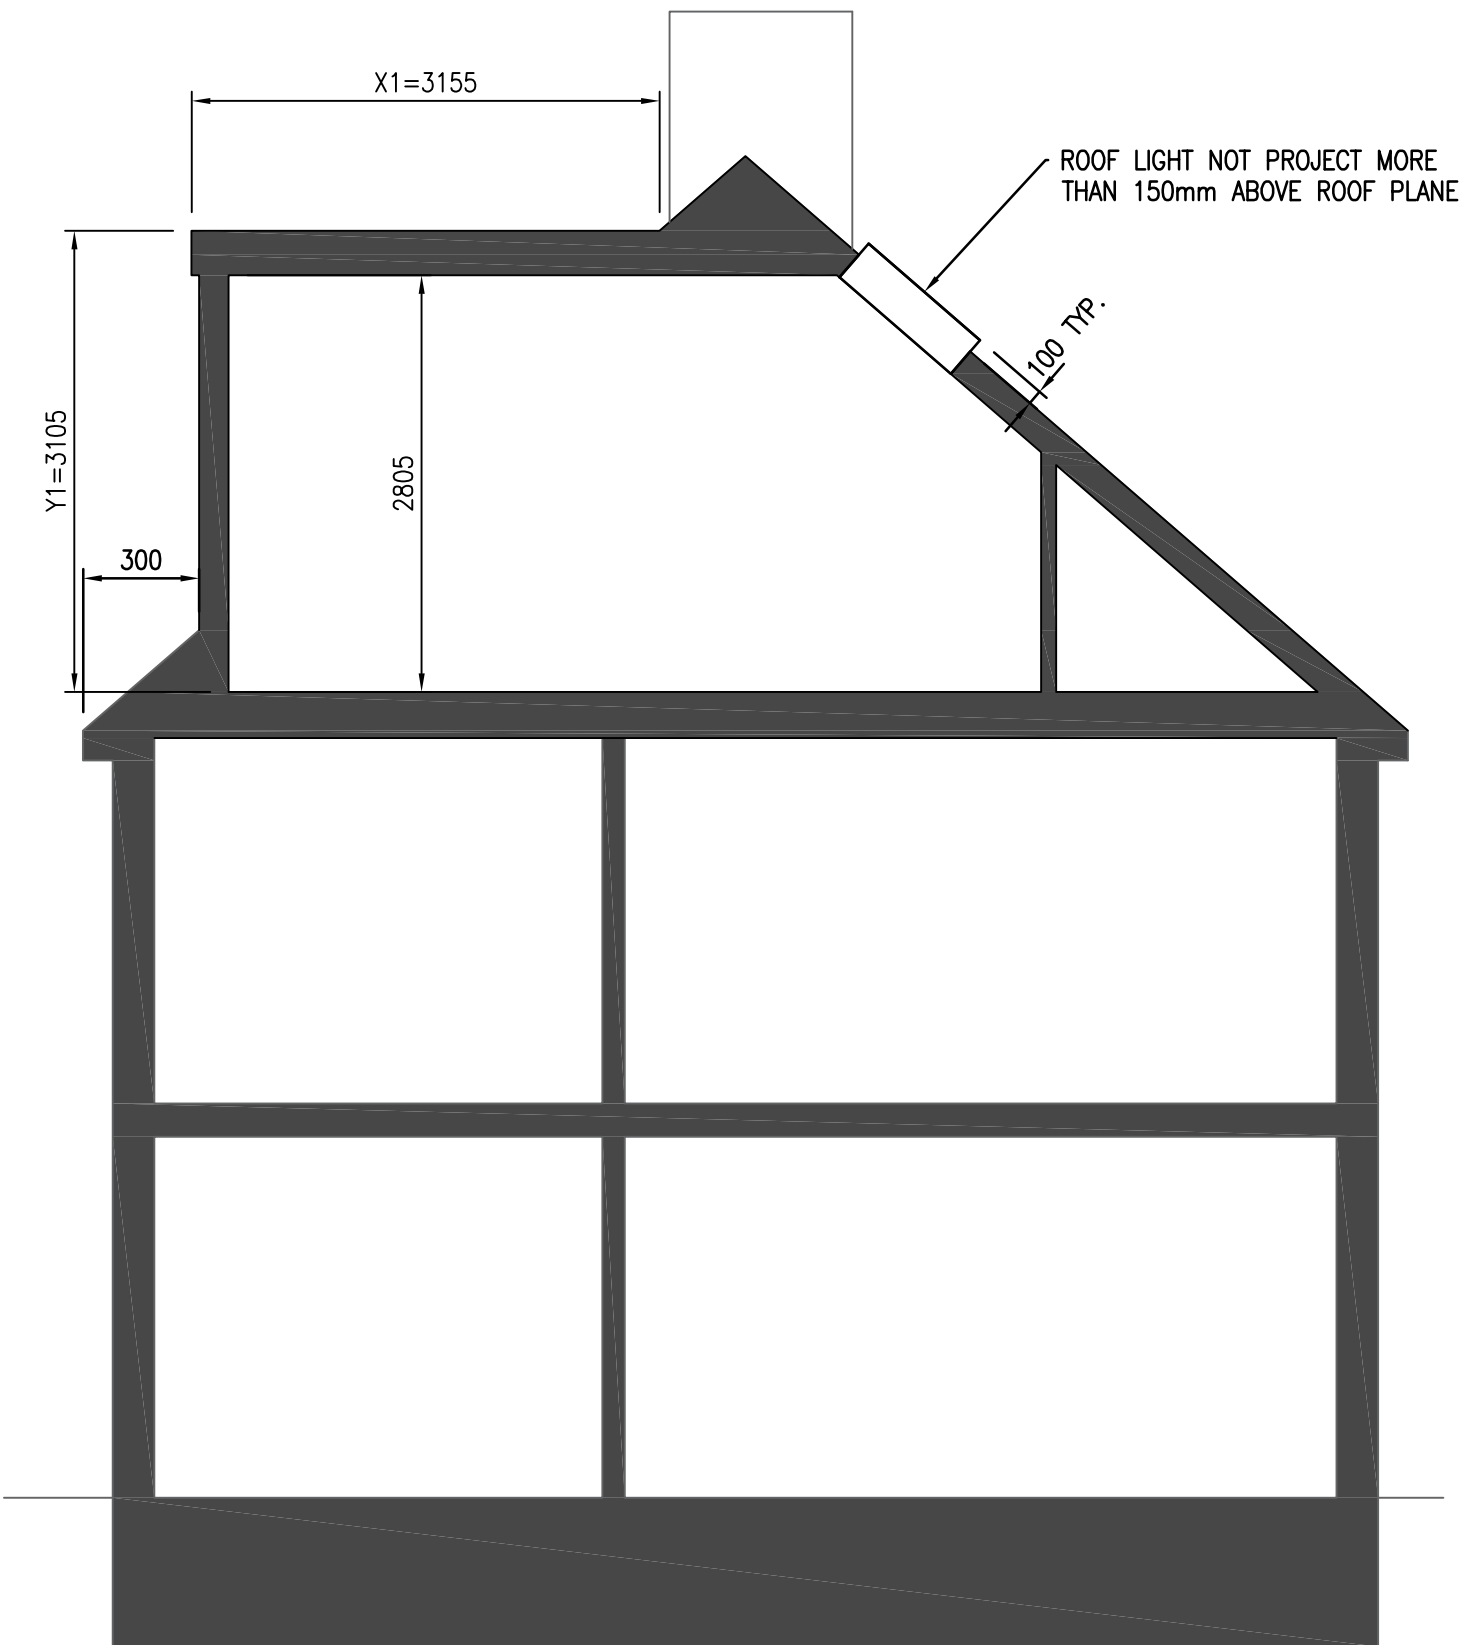


VIEW F-F PROPOSED SECTION  
1:50

NOTES:  
1. ALL DIMENSIONS ARE IN MILLIMETRES UNLESS NOTED OTHERWISE.

VOLUME FOR REAR ROOF DORMER EXTENSION:

$$= (X1) \times (Y1) \times (Z1) / 2$$
$$= 3.155 \times 3.105 \times 6.570 / 2$$
$$= 32.18 \text{ CUBIC METRE}$$

Rev	Purpose of Issue	Date	Authorised
A02	PLANNING APPROVAL.	8.11.18	CC
A01	BUILDING CONTROL APPROVAL.	9.9.18	CC

 RICHARD JAMIE CONSULTING CIVIL AND STRUCTURAL ENGINEERING			
Client MISS LOW			
Project 7 DOBSON CLOSE NW6 4RS			
Title LOFT CONVERSION PROPOSED SECTION AND ELEVATIONS			
Scale AS SHOWN.	Designed JL	Approved CC	
Drawn JL	Checked CC	Date 09/09/2018	
Drawing Number 7 DOBSON-ARC-0023			Rev A02

