


PROPOSED GROUND FLOOR PLAN STRUCTURE OVER

SCALE 1:50


BOUNDARY LINE

FOR CONNECTIONS DETAIL PLEASE REFER TO CALCULATION REPORT.

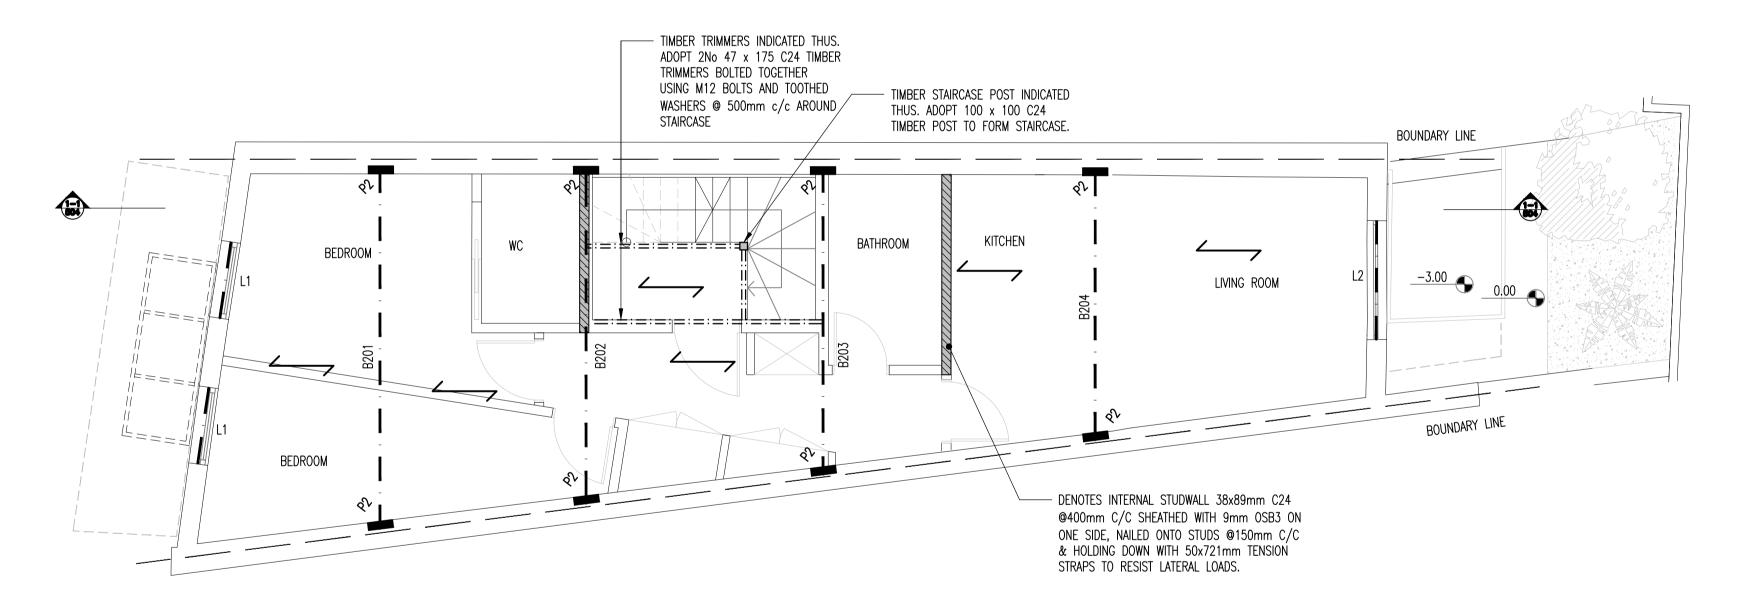

PROPOSED FIRST FLOOR PLAN

STRUCTURE OVER SCALE 1:50

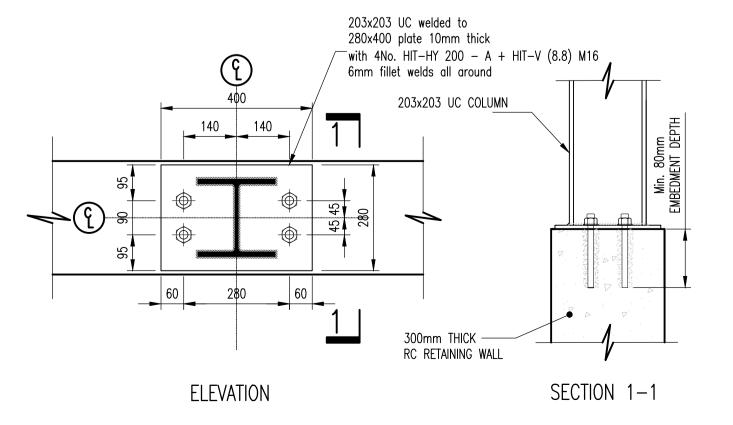

COLUMNS C101 - C106 TO RETAINING WALL CONNECTION DETAIL 1

SCALE 1:10

COLUMN LEVELS KEY COLUMN FINISHES AT THIS LEVEL

STRUCTURAL KEY:

COLUMN STARTS AT THIS LEVEL

DENOTES SPAN OF 47 x 175 C24
PROPOSED FLOOR JOISTS AT 400mm CENTRES

<u>TIMBER</u>

16. ALL TIMBER IS TO BE TREATED IN ACCORDANCE WITH CURRENT REGULATIONS AND STANDARDS.

17. ALL TIMBER FIXINGS ARE TO GALVANISED UNLESS NOTED OTHERWISE.

18. ALL TIMBER TO BE STRESS GRADED.

MASONRY

19. ALL STEELWORK BEARING ONTO PADSTONES TO BE BEDDED ON 1:2 CEMENT/SAND MORTAR.

20. ALL PADSTONES TO BE ENGINEERING BRICK UNLESS NOTED OTHERWISE.

<u>Steelwork</u>

21. ALL STEELWORK ENCASED IN MASONRY SHALL RECEIVE TWO COATS OF BITUMINOUS PAINT BUILD UP OF 75 MICRONS.

22. ALL STEELWORK IS TO BE COATED AS PER THE SPECIFICATION.

23. ALL STEELWORK LOCATED BELOW GROUND LEVEL TO HAVE 75mm MIN. CONCRETE COVER.

24. PROPOSED STEELWORK DETAILS HAVE BEEN PREPARED AND PRESENTED ON THE BASIS OF LIMITED EXISTING SITE DATA. THE MAIN CONTRACTOR OR HIS APPOINTED SUB-CONTRACTORS MUST ALLOW FOR SITE SURVEYING AND MEASURING TO ENSURE CORRECT ALIGNMENT AND FIT OF NEW STEELWORK.

	STEEL BEAM SCHEDULE				
SECTION Ref.	SIZE	STEEL GRADE	SURFACE TREATMENT	NOTES	
B101	203 x 203 UC 86	S275	С	TO SUPPORT EXISTING SOLID WALL OVER	
B102	203 x 102 UB 23	S275	С	_	
B103	203 x 102 UB 23	S275	С	_	
B104	203 x 203 UC 46	S275	С	_	
B105	203 x 102 UB 23	S275	С	-	
B106	203 x 203 UC 46	S275	С	TO SUPPORT EXISTING SOLID WALL OVER	

	STEEL COLUMN SCHEDULE				
SECTION Ref.	SIZE	STEEL GRADE	PAINT CONDITION	NOTES	DETAIL
C101	203 x 203 UC 46	S275	С	SUPPORTED ONTO RETAINING WALL	1
C102	203 x 203 UC 46	S275	С	SUPPORTED ONTO RETAINING WALL	1
C103	203 x 203 UC 60	S275	С	SUPPORTED ONTO RETAINING WALL	1
C104	203 x 203 UC 60	S275	С	SUPPORTED ONTO RETAINING WALL	1
C105	203 x 203 UC 46	S275	С	SUPPORTED ONTO RETAINING WALL	1
C106	203 x 203 UC 46	S275	С	SUPPORTED ONTO RETAINING WALL	1

	PADSTONE SCHEDULE				
PADSTONE Ref.	SIZE	MATERIAL	BEARING		
P1	215mm LONG x 102.5mm WIDE	2 COURSES ENGINEERING BRICK	100mm		
P2	330mm LONG x 102.5mm WIDE	2 COURSES ENGINEERING BRICK	100mm		
P3	440mm LONG x 102.5mm WIDE	3 COURSES ENGINEERING BRICK	100mm		

STEEL BEAM SCHEDULE					
SECTION Ref.	SIZE	STEEL GRADE	SURFACE TREATMENT	NOTES	
B201	203 x 102 UB 23	S275	С	-	
B202	203 x 102 UB 23	S275	С	-	
B203	203 x 102 UB 23	S275	С	-	
B204	178 x 102 UB 19	S275	С	_	

LINTEL SCHEDULE			
LINTEL Ref.	TYPE	MANUFACTURER	
L1	I BEAM (2C)	IG	
12	I BEAM (3C)	IG	

GENERAL NOTES:

1. DO NOT SCALE THIS DRAWING OR MODEL. ALL DIMENSIONS ARE IN MILLIMETRES UNLESS NOTED OTHERWISE. ANY DISCREPANCIES ARE TO BE RECORDED AND REPORTED TO THE ENGINEERS IMMEDIATELY.

2. THIS DRAWING IS TO BE READ IN CONJUNCTION WITH ALL OTHER

ENGINEERS AND ARCHITECTS DRAWINGS AND THE SPECIFICATION.

3. ALL WORK IS TO BE TO THE SATISFACTION OF THE ENGINEER AND LOCAL AUTHORITY BUILDING CONTROL.

4. THE CONTRACTOR IS RESPONSIBLE FOR AND MUST TAKE ALL NECESSARY PRECAUTIONS TO ENSURE THE STABILITY OF THE WORKS AT ALL TIMES DURING CONSTRUCTION.

5. ALL WORKMANSHIP AND MATERIALS ARE TO BE TO CURRENT BRITISH STANDARDS OR EUROCODES. ALL CONSTRUCTION PRODUCTS AND STRUCTURAL STEELWORK SHOULD BE CE MARKED IN ACCORDANCE WITH CURRENT LEGISLATION.

6. ALL SERVICES ARE TO BE LOCATED AND PROTECTED AS NECESSARY BY THE CONTRACTOR PRIOR TO THE COMMENCEMENT OF THE WORKS.

7. ANY EXISTING DETAILS WHICH ARE SHOWN ON THIS DRAWING ARE FOR GUIDANCE ONLY AND ARE TO BE CHECKED ON SITE BY THE CONTRACTOR. ANY VARIATIONS ARE TO BE RECORDED AND REPORTED TO THE ENGINEER IMMEDIATELY.

> LOAD-BEARING TIMBER STUDWORK WALL INDICATED THUS: STUDWORK TO BE AS FOLLOWS: <u>INTERNAL (MINIMUM)</u>

38 x 89 TIMBER C24 AT 400mm CENTRES EXTERNAL (MINIMUM)

38 x 140 C24 TIMBER AT 400mm CENTRES ALL TO BE SHEATHED WITH 9.5mm THICK

EXISTING EXTERNAL MASONRY WALLS PRESUMED TO BE SOLID WALLS. INTERNAL WALLS PRESUMED TO BE NON -LOAD BEARING UNLESS NOTED OTHERWISE.



P2	REVISED DESIGN ACCORDING TO LATEST ARCHITECT'S DRAWINGS	KP	DJS	12.09.20
P1	INITIAL ISSUE	KP	DJS	13.08.20
Rev	Amendments	Drawn	Approved	Date

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Rev. P2

74 FORTUNE GREEN ROAD NW6 1DS

Drawing Title PROPOSED GROUND FLOOR PLAN PROPOSED FIRST FLOOR PLAN SHOWING STRUCTURE OVER

ENTIRE HOUSE Ltd

Drawn by KP	Designed by KP
Approved by DJS	Checked by DJS
Scale AS SHOWN @ A1	Date AUGUST 2018

EX18_132_07 / 502